




SPRINKLER HEAD INFORMATION

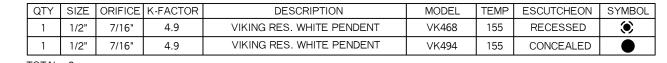

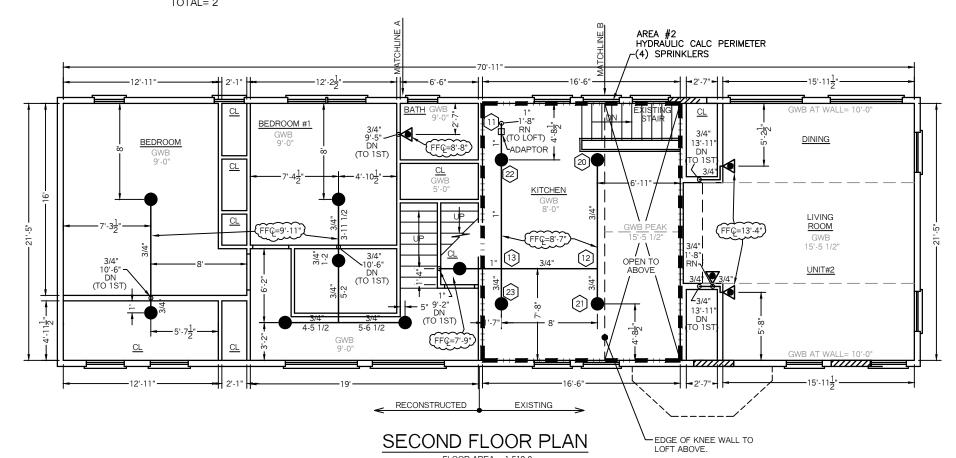

SPRINKLER HEAD INFORMATION


					_			
QTY	SIZE	ORIFICE	K-FACTOR	DESCRIPTION	MODEL	TEMP	ESCUTCHEON	SYMBOL
4	1/2"	7/16"	4.0	VIKING RES. WHITE SIDEWALL	VK486	155	RECESSED	•
11	1/2"	7/16"	4.9	VIKING RES. WHITE PENDENT	VK494	155	CONCEALED	•

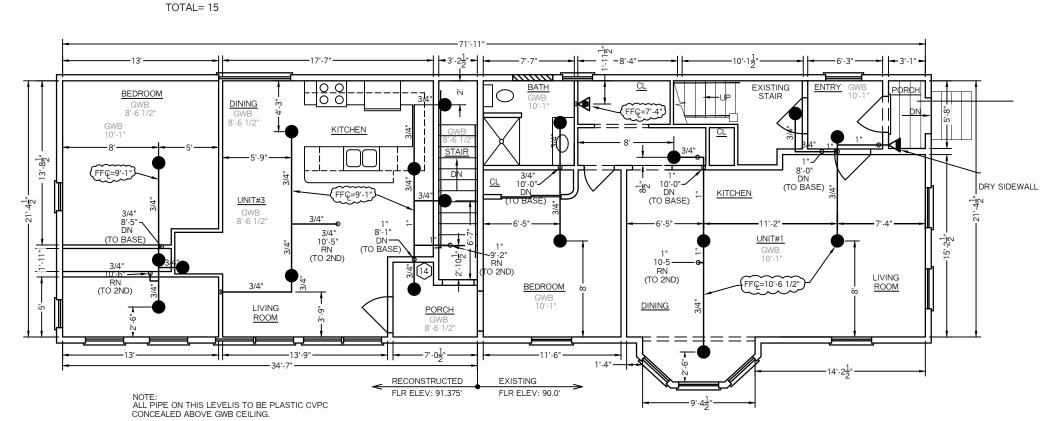

FIRST FLOOR PLAN FLOOR AREA = 1,565.0 FLR ELEV: 90.0' SCALE: 1/8" = 1'-0"


SPRINKLER HEAD INFORMATION ORIFICE K-FACTOR DESCRIPTION MODEL TEMP ESCUTO THE REPUBBLISH NAMED BEAUTICAL AND ADMINISTRATION ADMINISTRATION ADMINISTRATION AND ADMINISTRATION ADMINIS


QTY	QTY SIZE ORIFICE K-FACTOR		K-FACTOR	DESCRIPTION	MODEL	TEMP	ESCUTCHEON	SYMBOL
18	1/2	7/16"	4.9	VIKING RES. WHITE PENDENT	VK494	155	CONCEALED	
1	1/2	" 7/16"	4.0	VIKING RES. WHITE SIDEWALL	VK486	155	RECESSED	•
TOT	AL= 19							

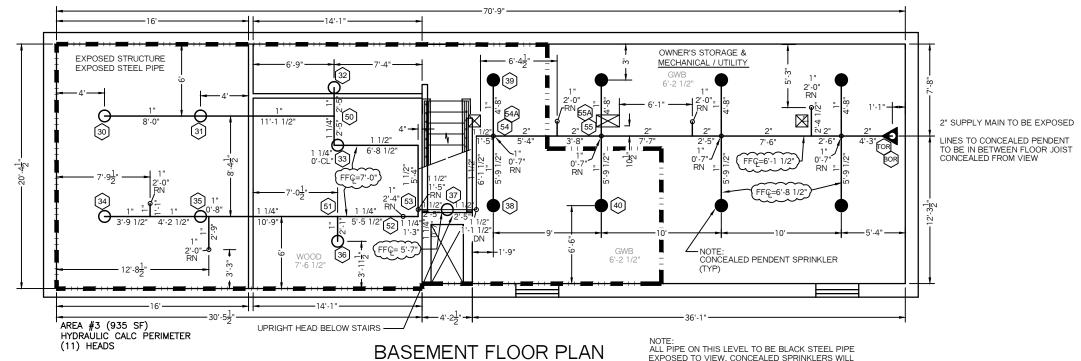

FLOOR AREA = 1,400.0 FLR ELEV: 82.54 SCALE: 1/8" = 1'-0" EXPOSED TO VIEW. CONCEALED SPRINKLERS WILL INSTALLED WHERE THERE IS A CEILING.


SPRINKLER HEAD INFORMATION										
QTY	SIZE	ORIFICE	K-FACTOR	DESCRIPTION	MODEL	TEMP	ESCUTCHEON	SYMBOL		
8	1/2"	1/2"	5.6	VIKING "QR" BRASS UPRIGHT	VK300	155	NONE	0		
8	1/2"	1/2"	5.6	VIKING "QR" WHITE PENDENT	VK462	155	CONCEALED			
TOTAL= 16										

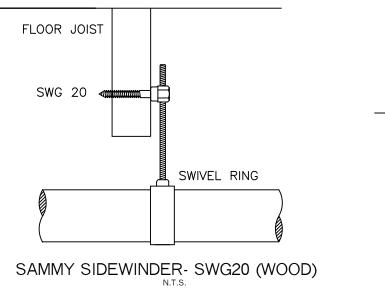

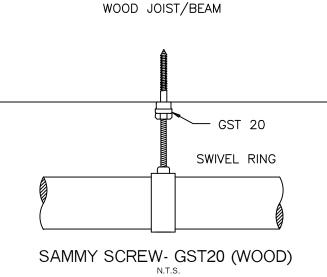

HANGER DETAILS


SCALE: NTS

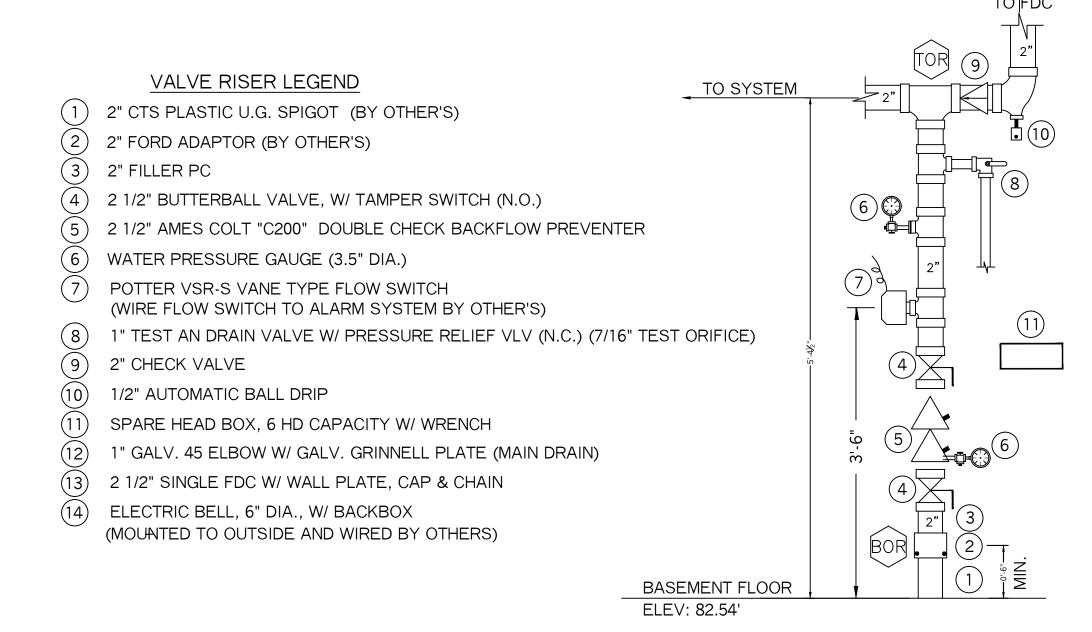

HYDRAUI	LIC CALCULA	ATION INF	ORMATION				
LOCATION: LOFT (AREA #1)							
BASIS OF DESIGN: NFPA 13, 2016 EDITION DENSITY AREA OF COVERAGE .0508 2 SPRK'S							
OCCUPANCY:	OCCUPANCY: BEDROOM						
SPRINKLERS:	TOTAL 2	THRD 1/2"	ORIFICE 7/16"	TEMP 155			
SYSTEM DEMAND AT BASE OF RISER (BOR):							
PRESSURE FLOW HOSE							
41.43 PS	SI 26.7	12 GPM	0				
SAF	SAFETY MARGIN: 51.09 PSI						


HYDRAULIC CALCULATION INFORMATION							
LOCATION: 2ND FLR (AREA #2)							
BASIS OF DESIGN: NFPA 13, 2016 EDITION DENSITY AREA OF COVERAGE .0508 4 SPRK'S							
OCCUPANCY: KITCHEN AREA							
SPRINKLERS: TOTAL THRD ORIFICE TEMP 4 1/2" 7/16" 155							
SYSTEM DEMAND AT BASE OF RISER (BOR):							
PRESSURE FLOW HOSE							
67.85 PSI 57.83 GPM 250							
SAFETY MARGIN: 23.71 PSI							

HYDRAULIC CALCULATION INFORMATION LOCATION: BASEMENT (AREA #3) BASIS OF DESIGN: NFPA 13, 2016 EDITION DENSITY AREA OF COVERAGE .15 935 SQ FT OCCUPANCY: MISC. STORAGE SPRINKLERS: TOTAL THRD ORIFICE TEMP 11 1/2" 1/2" 155 SYSTEM DEMAND AT BASE OF RISER (BOR): PRESSURE FLOW HOSE 65.91 PSI 239.93 GPM 250								
BASIS OF DESIGN: NFPA 13, 2016 EDITION DENSITY AREA OF COVERAGE .15 935 SQ FT OCCUPANCY: MISC. STORAGE SPRINKLERS: TOTAL THRD ORIFICE TEMP 11 1/2" 1/2" 155 SYSTEM DEMAND AT BASE OF RISER (BOR): PRESSURE FLOW HOSE	HYDRAU	LIC CALCUL	ATION INF	ORMATION				
DENSITY AREA OF COVERAGE .15 935 SQ FT OCCUPANCY: MISC. STORAGE SPRINKLERS: TOTAL THRD ORIFICE TEMP 11 1/2" 1/2" 155 SYSTEM DEMAND AT BASE OF RISER (BOR): PRESSURE FLOW HOSE	LOCATION: BASEMENT (AREA #3)							
SPRINKLERS: TOTAL THRD ORIFICE TEMP 1/2" 1/2" 155 SYSTEM DEMAND AT BASE OF RISER (BOR): PRESSURE FLOW HOSE	DENSITY AREA OF COVERAGE							
SPRINKLERS: 11 1/2" 1/2" 155 SYSTEM DEMAND AT BASE OF RISER (BOR): PRESSURE FLOW HOSE	OCCUPANCY: MISC. STORAGE							
PRESSURE FLOW HOSE	SDDINKI FDS:							
	SYSTEM DEMAND AT BASE OF RISER (BOR):							
65.91 PSI 239.93 GPM 250	PRESSURE FLOW HOSE							
	65.91 PSI 239.93 GPM 250							
SAFETY MARGIN: 4.23 PSI								

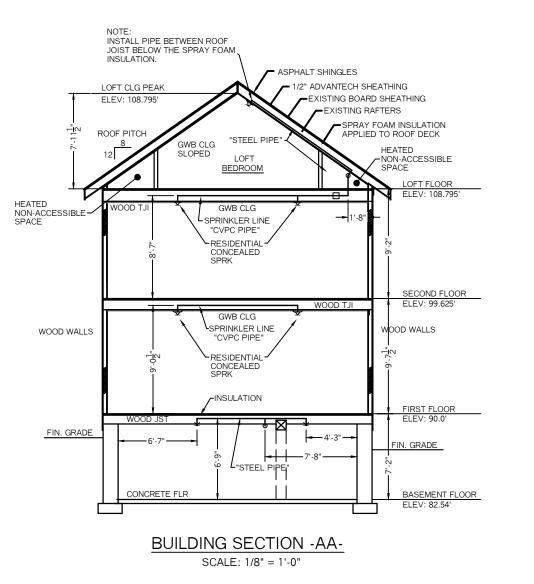

VALVE RISER DETAIL

N.T.S.

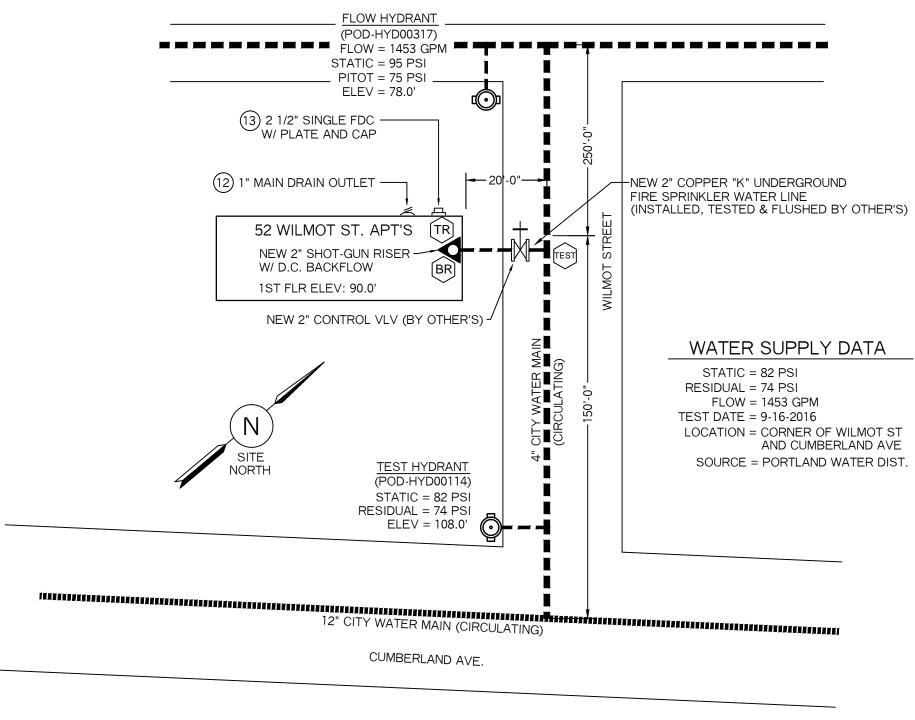

PLOT / SITE PLAN
SCALE: NTS

SYSTEM GENERAL NOTES:

- A WET PIPE SYSTEM OF AUTOMATIC SPRINKLERS DESIGNED AND INSTALLED PER NFPA 13R (2016 EDITION)
- -NEW 2" COPPER TYPE K SPRINKLER WATER LINE TO BE INSTALLED, TESTED AND FLUSHED BY OTHER'S IN ACCORDANCE WITH NFPA 24 AND LOCAL CODES.
 RESIDENTIAL FIRE PROTECTION TO START AT END OF 2" COPPER LINE IN THE BASEMENT.
- -2" SHOT-GUN VALVE RISER WITH A 2 1/2" DOUBLE CHECK BACKFLOW.
- -EXPOSED LINE PIPING IN THE BASEMENT TO BE SCHEDULE 40 BLACK STEEL WITH THREADED C.I. FITTINGS AND BRASS UPRIGHT HEADS ON LINE.
- -CVPC BLAZEMASTERS PLASTIC PIPE AND FITTINGS TO BE INSTALLED ON THE FIRST AND SECOND FLOORS. ALL CVPC PIPE TO BE CONCEALED FROM VIEW, TO BE INSTALLED IN WALLS AND ABOVE GWB CEILINGS.
- -WHITE RESIDENTIAL CONCEALED PENDENT SPRINKLERS WILL BE INSTALLED IN THE CEILINGS AND WHITE RECESSED RESIDENTIAL SIDEWALL HEADS WILL BE INSTALLED ON THE WALLS. RECESSED ESCUTCHEON SHALL BE USED WHERE THERE IS NOT ENOUGH ROOM FOR A
- CONCEALED PENDENT TO BE USED.

NFPA 13R NOTES:

SPRINKLERS SHALL BE INSTALLED IN ALL AREA'S EXCEPT THE FOLLOWING:

- 1.) BATHROOM'S WHERE THE AREA DOES NOT EXCEED 55 SF
- 2.) CLOTHES CLOSET'S, LINEN CLOSET'S AND PANTRIES THAT MEET THE FOLLOWING CONDITIONS;
- -THE AREA OF THE SPACE DOES NOT EXCEED 24 SF
- -THE LEAST DIMENSION DOES NOT EXCEED 3'-0"
 -THE WALLS AND CEILINGS ARE SURFACED WITH NON-COMBUSTIBLE OR
- LIMITED COMBUSTIBLE MATERIALS.
- * SPRINKLERS SHALL BE INSTALLED IN ANY CLOSET USED FOR HEATING OR AIR CONDITIONING EQUIPMENT
- 3.) PORCHES, BALCONIES, CORRIDORS AND STAIRS THAT ARE OPEN AND ATTACHED
- 4.) ATTICS, PENTHOUSES, EQUIPMENT ROOMS, ELEVATOR MACHINE ROOMS, CONCEALED SPACES DEDICATED EXCLUSIVELY TO AND CONTAINING ONLY DWELLING UNIT VENTILATION EQUIPMENT, CRAWL SPACES, FLOOR/CEILING SPACES, NON-COMBUSTIBLE ELEVATOR SHAFTS WITH THE CAR IN COMPLIANCE WITH ANSI A17.1 "SAFETY CODE FOR ELEVATORS" AND OTHER CONCEALED SPACES THAT ARE NOT USED OR INTENDED FOR LIVING PURPOSES OR STORAGE AND DO NOT CONTAIN FUEL FIRED EQUIPMENT
- 5.) CLOSETS ON EXTERIOR BALCONIES, REGARDLESS OF SIZE, AS LONG AS THERE ARE NO DOORS OR UNPROTECTED PENETRATIONS FROM THE CLOSET DIRECTLY INTO THE DWELLING UNIT.

PROJECT NAME: 52 WILMOT ST. APT'S 52 WILMOT STREET PORTLAND, ME. 04101	FIRE SPRINKLER PLANS AND DETAILS REQUIRED APPROVALS: STATE FIRE MARSHALS OFFICE LOCAL FIRE DEPARTMENT	RESIDENTIAL FIRE
CRANDALL TOOTHAKER (OWNER) PH: (207) 797-6066	OWNER DRAWN BY: TPP NICET III CERTIFICATION # 100854	印紀下E: 6-28-2017 SCALE: 1/8" = 1'-0"
	CHECKED BY: SJC NICET III (100854)	CONTRACT NO.
RESIDENTIAL FIRE PROTECTION	CERTIFICATION # 78065	C16032
64 DAGGETT HILL ROAD, GREENE, MAINE 04236	CONTRACTOR LICENSE #511	DRAWING NO. 1 OF 1
PH: (207) 946-3473 FAX: (207) 946-3474	CONTRACTOR RMS #80	1 01 1