1. ALL DIMENSIONS ARE FOR REFERENCE ONLY. ALL DIMENSIONS SHALL BE

FIELD VERIFIED BEFORE ORDERING SUPPLIES OR BEING CONSTRUCTION.

NOTE; WINDOW SUPPLIER SHALL PROVIDE TRIM PACKAGE AND ADJUST MULLED UNITS ROUGH OPENINGS AS REQUIRED. NOTE: ** CONTRACTOR SHALL VERIFY ROUGH OPENINGS BEFORE FRAMING OPENINGS NOTE: SEE ELEVATIONS FOR GRILLE PATTERNS, ORDER ACCORDINGLY.

				DOOR SCHEDUL	E	
NO.	SIZE (WxH) (E)=EXISTING	INSUL	FIRE RATING	HARDWARE	SWING	REMARKS
	3'-0''x6'-8''	R-7	I HR	HW-5	SEE PLAN	* DOOR/FRAME ASSEMBLY, SELF CLOSING, PANEL
<u>02</u>	3'-0"x6'-2"	R-7	IHR	HW-5	SEE PLAN	* DOOR/ FRAME ASSEMBLY, SELF CLOSING, PANEL
(3)	3'-0"x6'-2"	R-7	IHR	HW-5	SEE PLAN	* DOOR/ FRAME ASSEMBLY, SELF CLOSING, PANEL
	3'-0''x6'-8''	R-7	I HR	HW-I	SEE PLAN	* DOOR/ FRAME ASSEMBLY, SELF CLOSING, FULL VIEW
(102)	3'-0''x6'-8''	R-7	I HR	HW-3	SEE PLAN	* DOOR/FRAME ASSEMBLY, SELF CLOSING, 9 LITE
(103)	3'-0''x6'-8''	R-7	I HR	HW-3	SEE PLAN	* DOOR/ FRAME ASSEMBLY, SELF CLOSING, FULL VIEW
(104)	3'-0''x6'-8''	R-7	I HR	HW-4	SEE PLAN	* DOOR/ FRAME ASSEMBLY, SELF CLOSING, PANEL
(105)	3'-0''x6'-8''	R-7	I HR	HW-2	SEE PLAN	* DOOR/FRAME ASSEMBLY, SELF CLOSING, PANEL (REPLACE EXISTING DOOR).


{	<u></u>	3'-0"x6'-2"	R-7	1 HR	HW-5	SEE PLAN	* DOOR/FRAME ASSEMBLY, SELF CLOSING, PANEL
{	03	3'-0"x6'-2"	R-7	I HR	HW-5	SEE PLAN	* DOOR/FRAME ASSEMBLY, SELF CLOSING, PANEL
	lOl	3'-0"x6'-8"	R-7	1 HR	HW-I	SEE PLAN	* DOOR/ FRAME ASSEMBLY, SELF CLOSING, FULL VIEW
	102	3'-0"x6'-8"	R-7	I HR	HW-3	SEE PLAN	* DOOR/FRAME ASSEMBLY, SELF CLOSING, 9 LITE
	103	3'-0"x6'-8"	R-7	I HR	HW-3	SEE PLAN	* DOOR/FRAME ASSEMBLY, SELF CLOSING, FULL VIEW
	104	3'-0"x6'-8"	R-7	I HR	HW-4	SEE PLAN	* DOOR/FRAME ASSEMBLY, SELF CLOSING, PANEL
	105	3'-0"x6'-8"	R-7	I HR	HW-2	SEE PLAN	* DOOR/FRAME ASSEMBLY, SELF CLOSING, PANEL (REPLACE EXISTING DOOR)


NOTE: SEE FLOOR PLANS FOR UNIT INTERIOR DOOR SIZES, SWING AND TYPE. REPLACE EXISTING DOORS & FRAMES NOTED IN DOOR SCHEDULE AS REQUIRED. HW-I 3 BUTTS*, DOOR; ENTRY LEVER LOCKSET; THRESHOLD WEATHER STRIPPING; DOOR BOTTOM * GC OPTION: SELF CLOSING BUTTS OR DOOR CLOSERS	SEE PLAN * DOOR/ FRAME ASSEMBLY, SELF CLOSING, PANEL (REPLACE EXISTING DOOR)	SEE P	HW-2	I HR	R-7	'-8"	3'-0"x6	(105)	
REPLACE EXISTING DOORS & FRAMES NOTED IN DOOR SCHEDULE AS REQUIRED. 3 BUTTS*, DOOR;ENTRY LEVER LOCKSET; THRESHOLD * GC OPTION: SELF CLOSING BUTTS OR DOOR CLOSERS									
	* GC OPTION: SELF CLOSING BUTTS OR DOOR CLOSERS						HW-I		
HW-2 3 BUTTS*, DOOR; ENTRY LEVER LOCKSET; THRESHOLD * GC OPTION: SELF CLOSING BUTTS OR DOOR CLOSERS WEATHER STRIPPING; DOOR BOTTOM; DOOR VIEWER	* GC OPTION: SELF CLOSING BUTTS OR DOOR CLOSERS						HW-2		
HW-3 3 BUTTS*, DOOR; ENTRY LEVER LOCKSET; THRESHOLD * GC OPTION: SELF CLOSING BUTTS OR DOOR CLOSERS WEATHER STRIPPING; DOOR BOTTOM;	* GC OPTION: SELF CLOSING BUTTS OR DOOR CLOSERS						HW-3		
HW-4 3 BUTTS*, DOOR; ENTRY LEVER LOCKSET; * GC OPTION: SELF CLOSING BUTTS OR DOOR CLOSERS	* GC OPTION: SELF CLOSING BUTTS OR DOOR CLOSERS	3 BUTTS* , DOOR; ENTRY LEVER LOCKSET;							
HW-5 3 BUTTS *; DOOR; STORE ROOM LEVER LOCKSET W/ EXIT FUNCTION * GC OPTION: SELF CLOSING BUTTS OR DOOR CLOSERS	* GC OPTION: SELF CLOSING BUTTS OR DOOR CLOSERS		(IT FUNCTION	LEVER LOCKSET W/E	*; DOOR; STORE ROON	3 BUTTS :	HW-5		
INTERNAL UNIT DOORS 3 BUTTS; LEVER LATCH SET; EXCEPT PRIVACY SET AT BATHROOMS * GC OPTION: SELF CLOSING BUTTS OR DOOR CLOSERS	* GC OPTION: SELF CLOSING BUTTS OR DOOR CLOSERS	* GC OPTION: SELF CLOSING BLITTS OR DOOR CLC				3 BUTTS;	AL UNIT DOORS	INTERNA	

				WINDOW SCHEDU	LE	
10.	SIZE (WxH)	TYPE	FIRE RATING	GLAZING	ROUGH OPENING (WxH)	REMARKS
A	MRAAW2O2OP	AWNING (FIXED)	NONE	TEMPERED, INSUL. GL	2'-11/4"x2'-03/4"	PLYGEM
B	MRAAW3030	AWNING	NONE	INSUL, GL	3'- "x3'-0 /2"	PLYGEM
\overline{C}	MRAAW3030	AWNING	NONE	TEMPERED, INSUL. AL FROSTED AL.	3'- ''x3'-0 /2''	PLYGEM
D)	MRADH60510P	PICTURE	NONE	TEMPERED, INSUL. GL	6'-23/8"X6'-1 1/4"	PLYGEM
E	MRAD28510	DOUBLE-HUNG	NONE	TEMPERED, INSUL. AL	2'-10 3/8"x6'-11/8"	PLYGEM
	MRADI 130510	DOUBLE HUNG	NONE	TEMPERED, INSUL. AL	3'-2 3/8"16'-11/4"	PLYGEM (EGRESS)
a	MRADH30410-2	DOUBLE-HUNG	NONE	TEMPERED, INSUL. GL	6'-4 3/4"x5'-11/8"	PLYGEM (EGRESS)
Н	MRADH34510	DOUBLE-HUNG	NONE	TEMPERED, INSUL. GL	3'-6 3/8"x6'- /8"	PLYGEM (EGRESS)
	MRV4W2424	AWNING	NONE	TEMPERED, INSUL. AL PROSTED AL.	2'-51/4",2'-43/4"	PLYGEM
K	CUSTOM-FIELD VERIFY	DOUBLE-HUNG	NONE	TEMPERED, INSUL. GL	(FIELD VERIFY)	PLYGEM (EGRESS)
	MRAAW3030-2	AWNING	NONE	TEMPERED, INSUL. GL	6'-2"13'-01/2"	PLYGEM
M	MRAAW3030-3	AWNING	NONE	TEMPERED, INSUL. GL	9'-2"13'-01/2"	PLYGEM
N	MR//\W2121 3	AWNING	NONE	TEMPERED, INSUL. AL	71-3-3/41/21-4-1/411	PLYGEM
P	MRAAW3030P	AWNING (FIXED)	NONE	TEMPERED, INSUL. GL	3'- ''x3'-0 /2''	PLYGEM
()	MRAW3030-2	AWNING	NONE	INSUL. AL	6'-2" 3'-01/2"	PLYGEM

WINDOW & DOOR SCHEDULE & HARDWARE SETS

NOTE: SEE STRUCTURAL HEADER SCHEDULE FOR HEADER SIZE

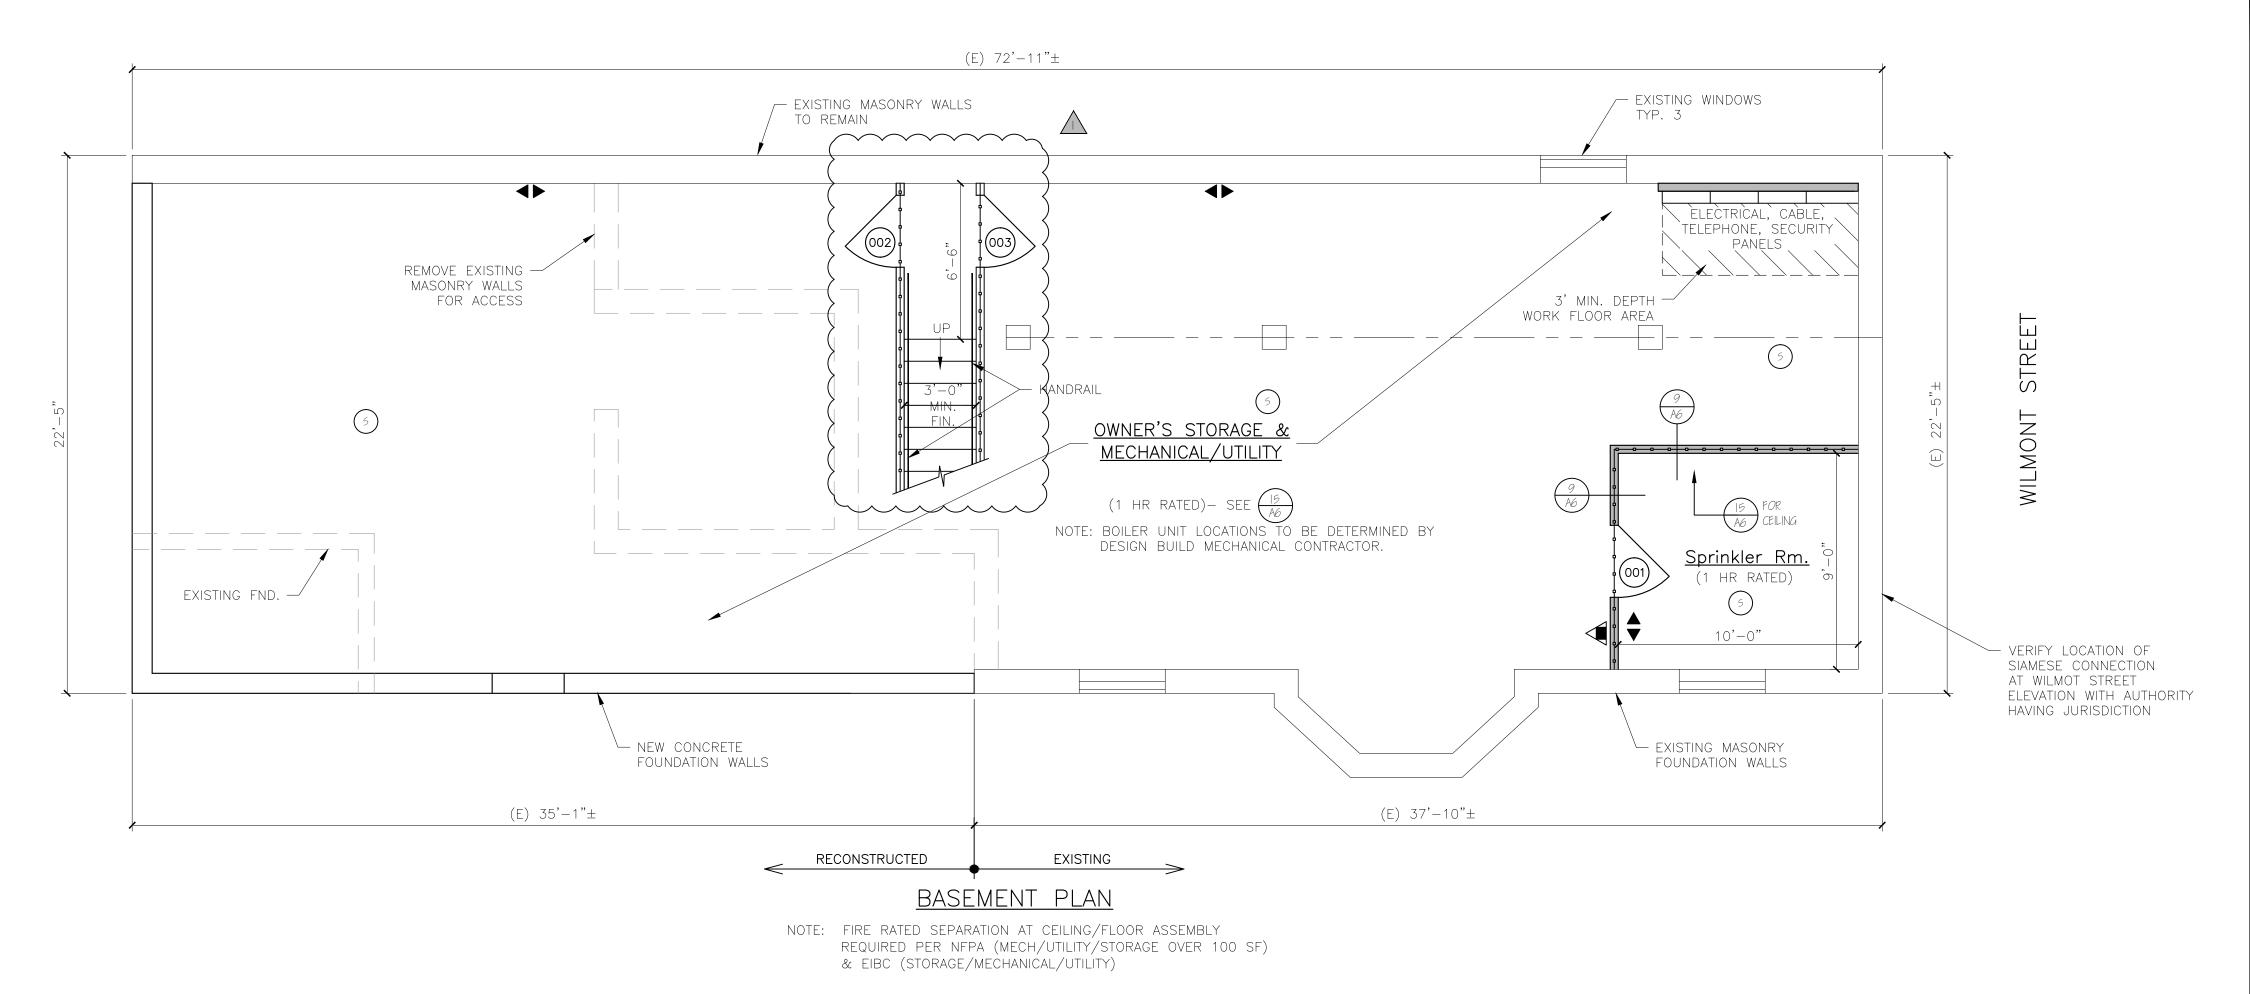

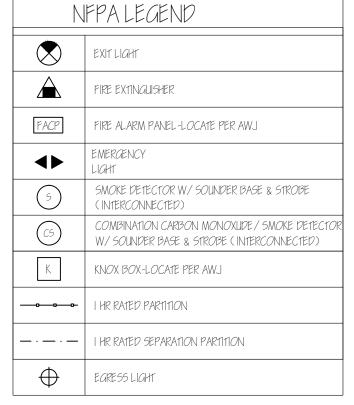

THE BUILDING SHALL HAVE AN NFPA 13R FIRE SUPPRESSION SPRINKLER SYSTEM INSTALLED, SPRINKLER SYSTEM SHALL BE INSTALLED BY A CERTIFIED SPRINKLER CONTRACTOR AND SHALL BE REVIEWED AND APPROVED BY THE STATE OF MAINE FIRE MARSHAL AS WELL AS THE LOCAL AUTHORITY HAVING JURISDICTION, THE CONTRACTOR SHALL BEAR SOLE RESPONSIBILITY FOR THE DESIGN AND INSTALLATION OF THE SYSTEM FOR OCCUPANCY. 2. THE BUILDING SHALL HAVE A FIRE ALARM SYSTEM AS REQUIRED FOR COMPLIANCE WITH NFPA IOI LIFE SAFETY CODE. COORDINATE WITH SPRINKLER SYSTEM. VERIFY LOCATION OF ALARM AND NOTIFICATION PANELS WITH THE AUTHORITY HAVING JURISDICTION. 3. ALL ALARMS AND DETECTORS SHALL BE INTERCONNECTED. 4. REFER TO THE WINDOW SCHEDULE FOR EGRESS WINDOWS.

LIFE SAFETY NOTES

LEGEND SYMBOL DESCRIPTION NEW WALL NEW WALL/EXISTING WALL W/INFILL EXISTING WALL THIN LINEWEIGHT DENOTES EXISTING CONDITIONS - HEAVY LINEWEIGHT DENOTES NEW CONDITIONS DEMOLISHED OR REMOVED STRUCTURE OR EQUIPMENT

GENERAL NOTES I. ALL HORIZONTAL UNIT SEPARATIONS (FLOOR/CEILING/ROOF) ASSEMBLIES SHALL BE I HR. FIRE RATED/STC 50. 2. ALL VERTICAL UNIT SEPARATIONS (TENANT WALLS) SHALL BE I HR. FIRE RATED/STC 50 -SEE (7) 3. ALL STAIR ENCLOSURES SHALL BE I HR FIRE RATED 4. SEE SHEET AG FOR HANDRAIL DETAILS 5. SEE $\frac{10}{A6}$ FOR FIRE RATING AT UNDERSIDE OF STAIR RUNS. 6. SEE $\frac{16}{A6}$ FOR I HOUR RATED EXTERIOR WALL.

STRUCTURAL HEADER SCHEDULE


5' wide openings - Use (2) 1 3/4" x 9 1/2" LVL's. 4' wide openings - Use (2) 1 3/4" x 9 1/2" LVL's. 3' or less openings - Use (3) 2 x 10's.

Second Floor Level: 5' wide openings - Use (2) 1 3/4" x 9 1/2" LVL's. 4' wide openings - Use (3) 2 x 10's. 3' or less openings - Use (2) 2 x 10's.

Third Floor Level: 5' and less openings - Use (2) 2 x 10's. REV 1 REVISED STAIRWAY 03-17-17

Engineering Review of Structural Framing System Only.

ENGINEERING DESIGN PROFESSIONALS PO Box 575 Freeport, Maine 04032 207-865-9505

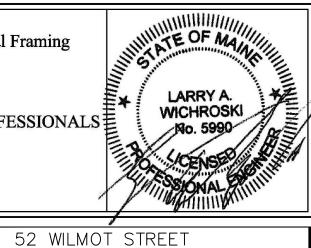

MORIN DRAFTING 318-1177 52 WILMOT STREET, L.L.C. 477 CONGRESS STREET PORTLAND, MAINE

FIRST FLOOR PLAN

ISSUED FOR CONSTRUCTION DRAWN: J. MORIN SCALE: 1/4"=1'-0" DATE: 07-06-2016 PLAN NO: SCALE: 1/4" = 1'-0"