


THA ARCHITECTS, LLC
 ARCHITECTURE DESIGN PLANNING INTERIOR DESIGN
 105 WILLOW BROOK AVENUE
 STRATHAM, NEW HAMPSHIRE 03885
 Tel: (603) 770-2491 Fax: (603) 773-0238
 www.thaarc.com

These drawings and specifications were prepared for use at the location indicated. Publication and reproduction in any form without the written permission of THA Architects, LLC.
 © 2015 THA Architects, LLC.

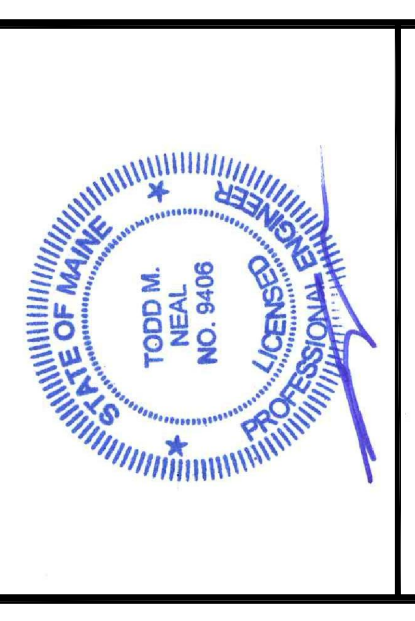

midtown Portland
 Somerset Street
 Elm Street
 Portland, ME


**Building 2
 LEVEL 2
 FRAMING PLAN**

Structural Engineer
BECKER STRUCTURAL ENGINEERS
 75 New Street, Portland, Maine 04101
 207.879.1838 • beckerstructural.com

MEP Engineer
McCabe & Associates
 FP Engineer
McCabe & Associates


SCALE: AS NOTED
 ISSUED / DRAWN BY _____
 © THA ARCHITECTS, LLC
 REVISED / REVISED BY _____
 APRIL 15, 2016

JOB NO: 15001
 SHEET NUMBER
S-1.2

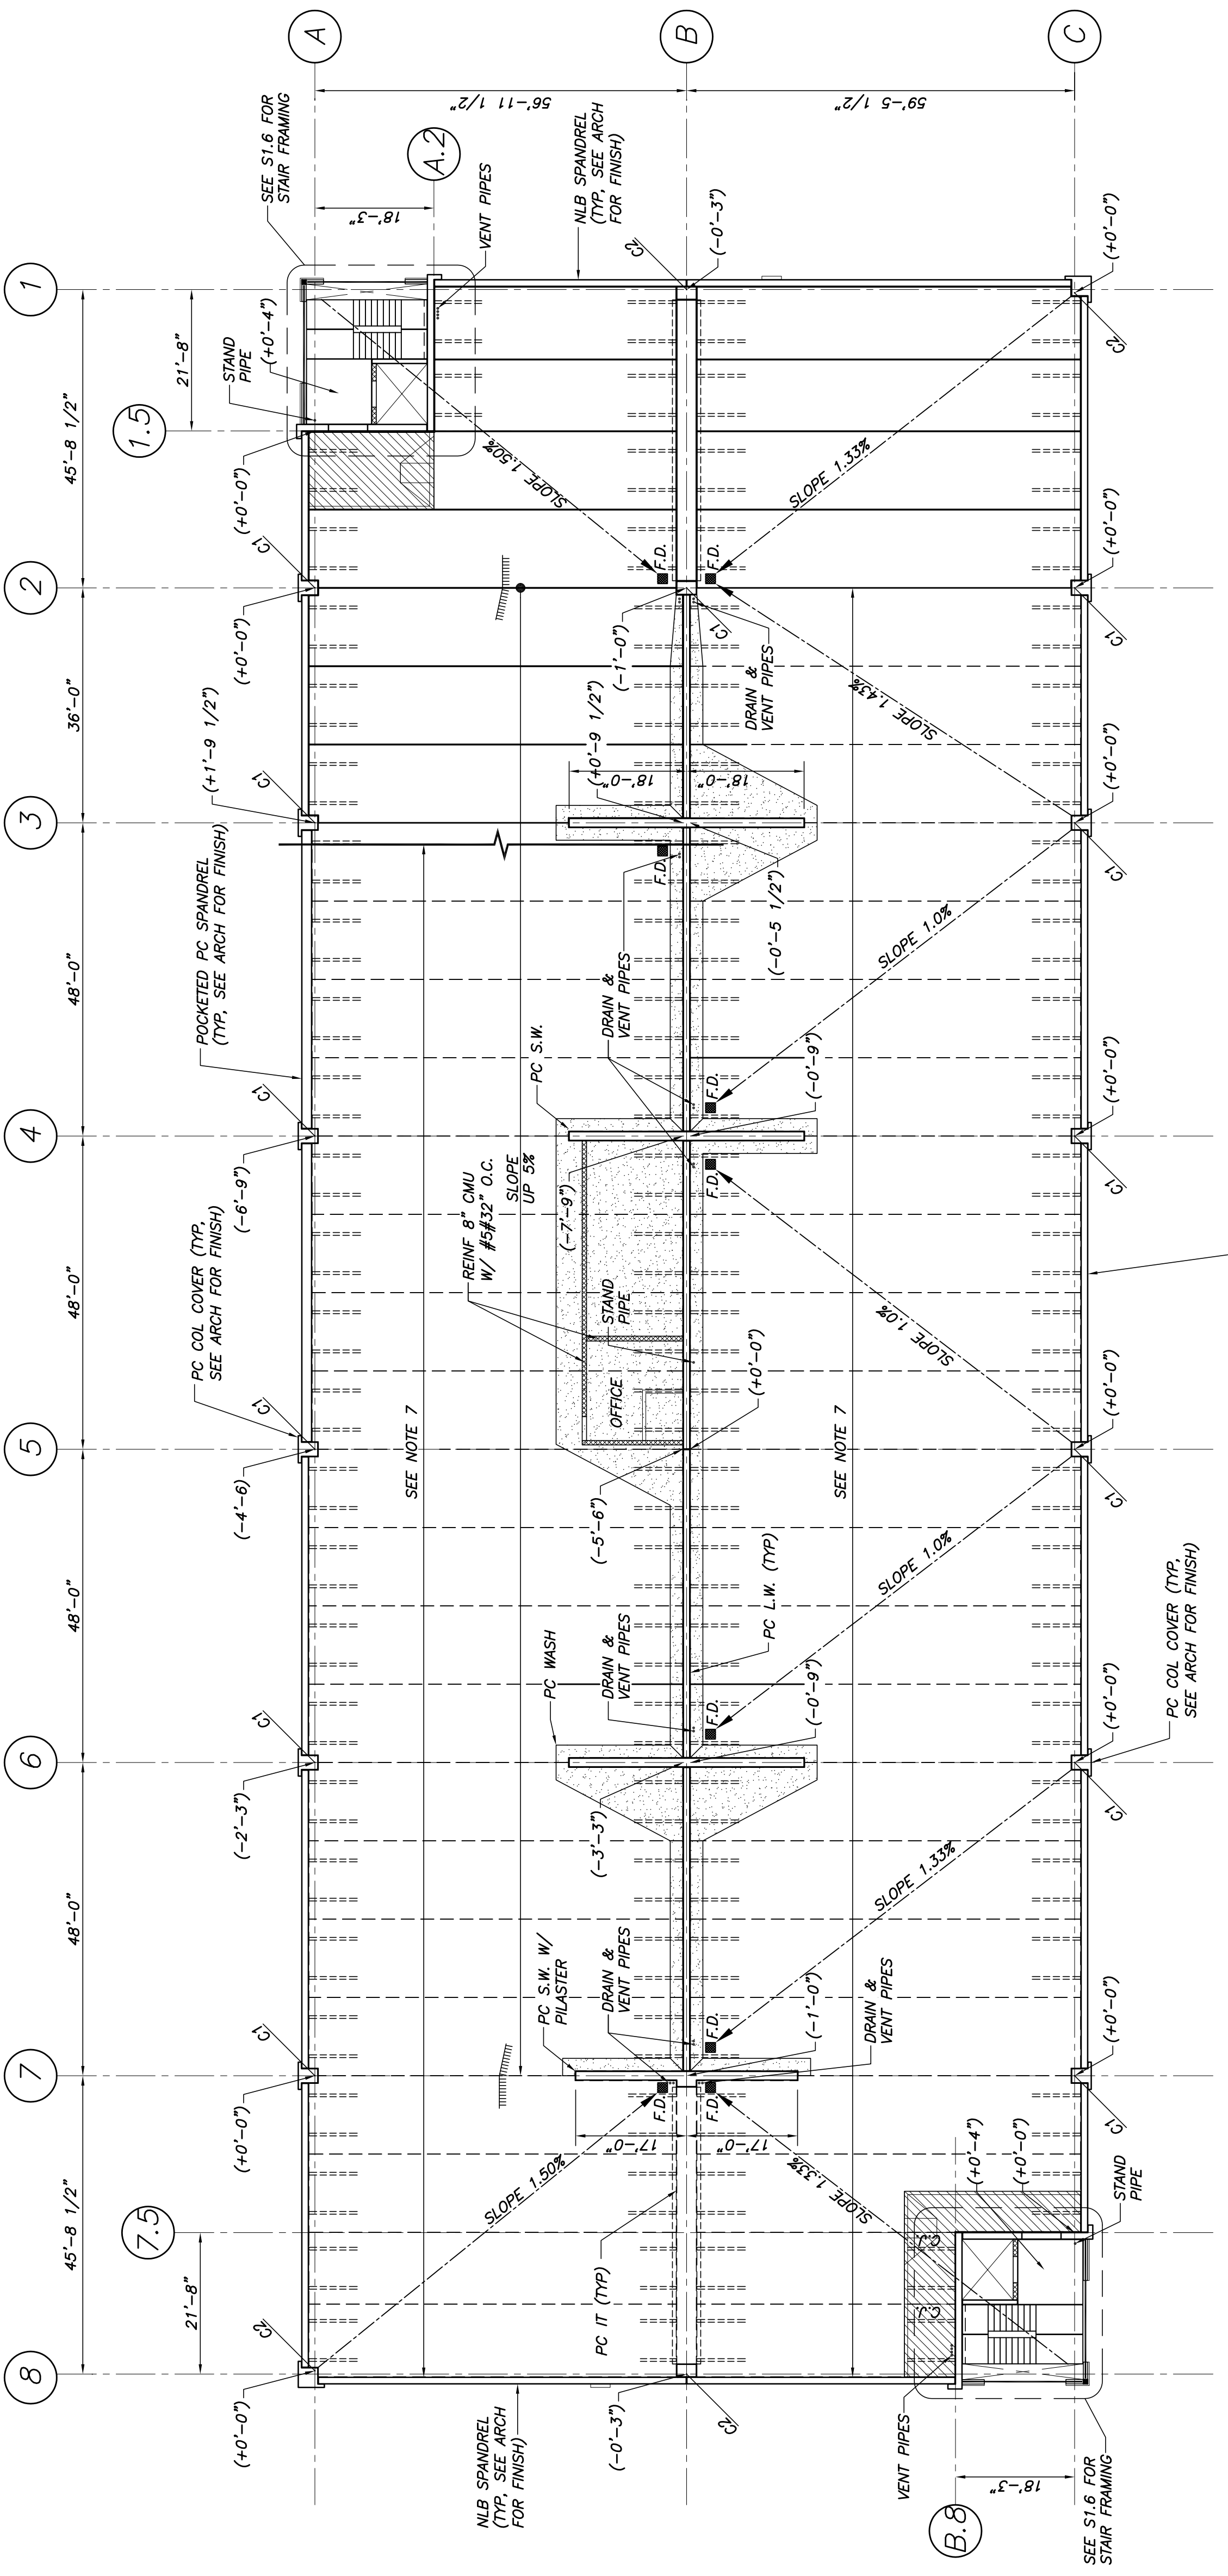


LEVEL 2 FRAMING PLAN
 1/16"=1'-0"

- NOTES:**
- (4' X-XX") INDICATES TOP OF DECK ELEVATION RELATIVE TO REFERENCE ELEVATION (23'-6" U.W.O. DETAIL DWG. S-4.1)
 - ALL PRECAST CONCRETE STRINGERS AND SLABS SHALL BE DESIGNED AND FABRICATED AS PRECAST CONCRETE
 - PRECAST LAYOUT IS CONCEPTUAL ONLY. FINAL LAYOUT IS TO BE DETERMINED BY THE PRECAST SUPPLIER.
 - PRECAST COLUMNS INDICATED BY C. ARE:
 C1: 25" X 25" C2: 36" X 36"
 - COORD. VENT, DRAIN AND STAND PIPE LOCATIONS WITH PLUMBING DRAWINGS
 - HR FIRE RATED DECK:
 A. 5" DT FLANGE & RATED BACKER ROD + SEALANT
 B. WATERPROOFING MEMBRANE (SHEET OR SPRAY APPLIED, SEE ARCH)
 C. DRAINAGE MAT (SEE ARCH)
 D. RIGID INSULATION (SEE ARCH)
 E. 2 1/2" FIBER REINF. 5,000 PSI TOPPING SLAB WITH BROOM FINISH
 - INDICATES PRECAST WASH
 - INDICATES CIP TOPPING
 - REFERENCE ARCHITECTURAL DRAWINGS FOR PRECAST FINISH
 - REFERENCE DWG. S-4.2 FOR TP-JOINT DETAILING
 - PRECASTER NOTE: DT TO BE DELIVERED TO SITE WITH RADIUS EDGES

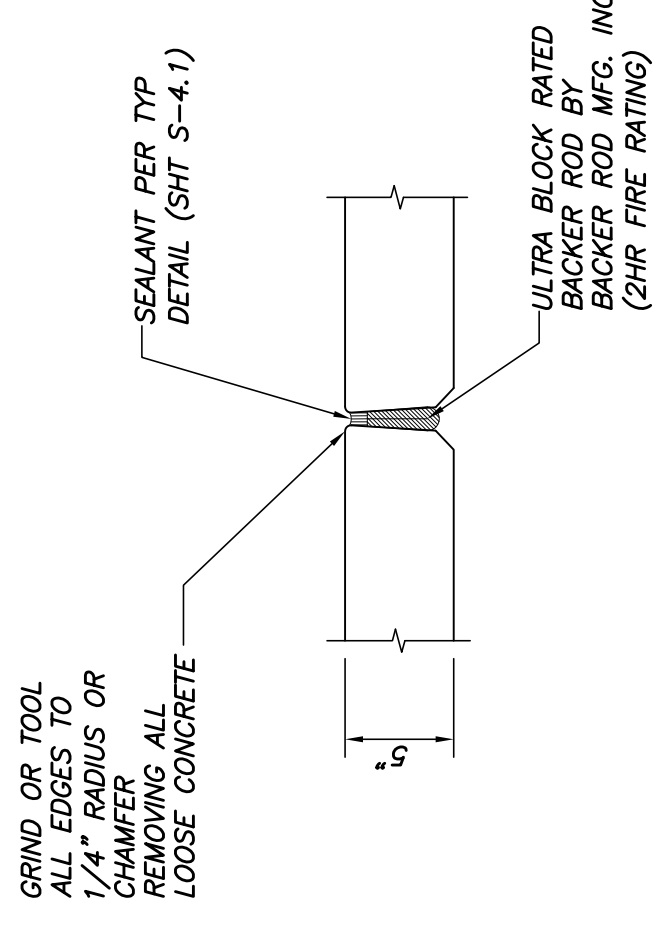

TYP FIRE RATED JOINT SEALANT DETAIL

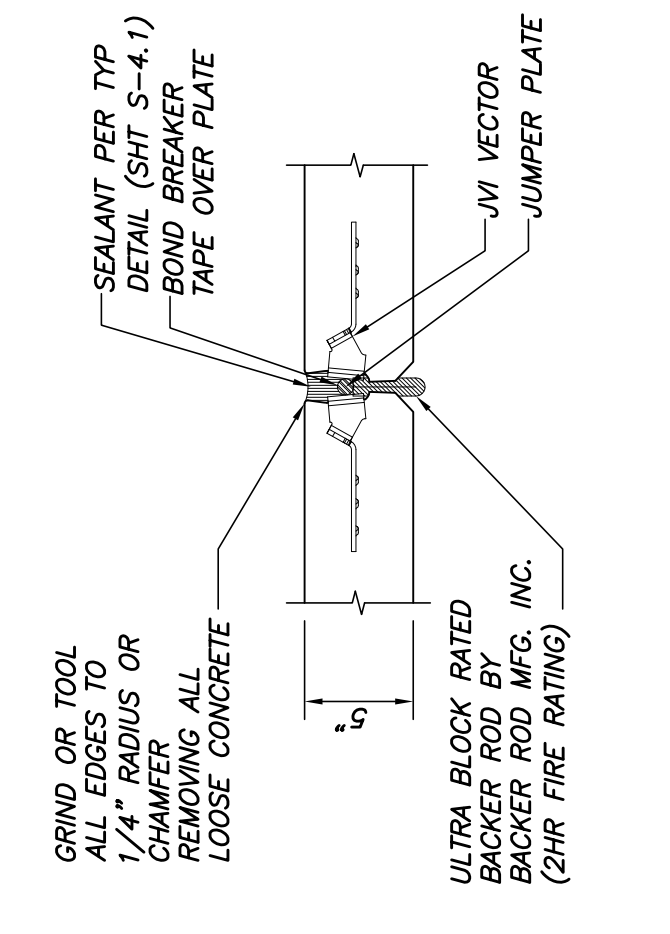

TYP FIRE RATED JOINT SEALANT DETAIL AT FLANGE CONNX

NOT FOR CONSTRUCTION
 REVISED PERMIT SET
 4/15/16