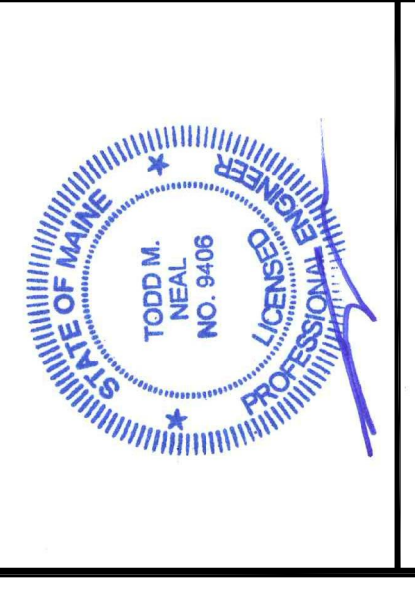


**THA ARCHITECTS, LLC**  
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 105 WILLOW BROOK AVENUE  
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midtown Portland

Somerset Street  
 Elm Street  
 Portland, ME


Building 2  
 STAIR FRAMING PLANS

Structural Engineer  
**BECKER**  
 STRUCTURAL ENGINEERS  
 75 York Street, Portland, Maine 04101  
 207.879.1838 • beckerstructural.com

MEP Engineer  
**McCabe & Associates**  
 FP Engineer  
**McCabe & Associates**


SCALE: AS NOTED  
 ISSUED / DRAWN BY \_\_\_\_\_  
 REVISED / REVISED BY \_\_\_\_\_  
 APRIL 15, 2016

JOB NO: 15001  
 SHEET NUMBER  
**S-1.6**

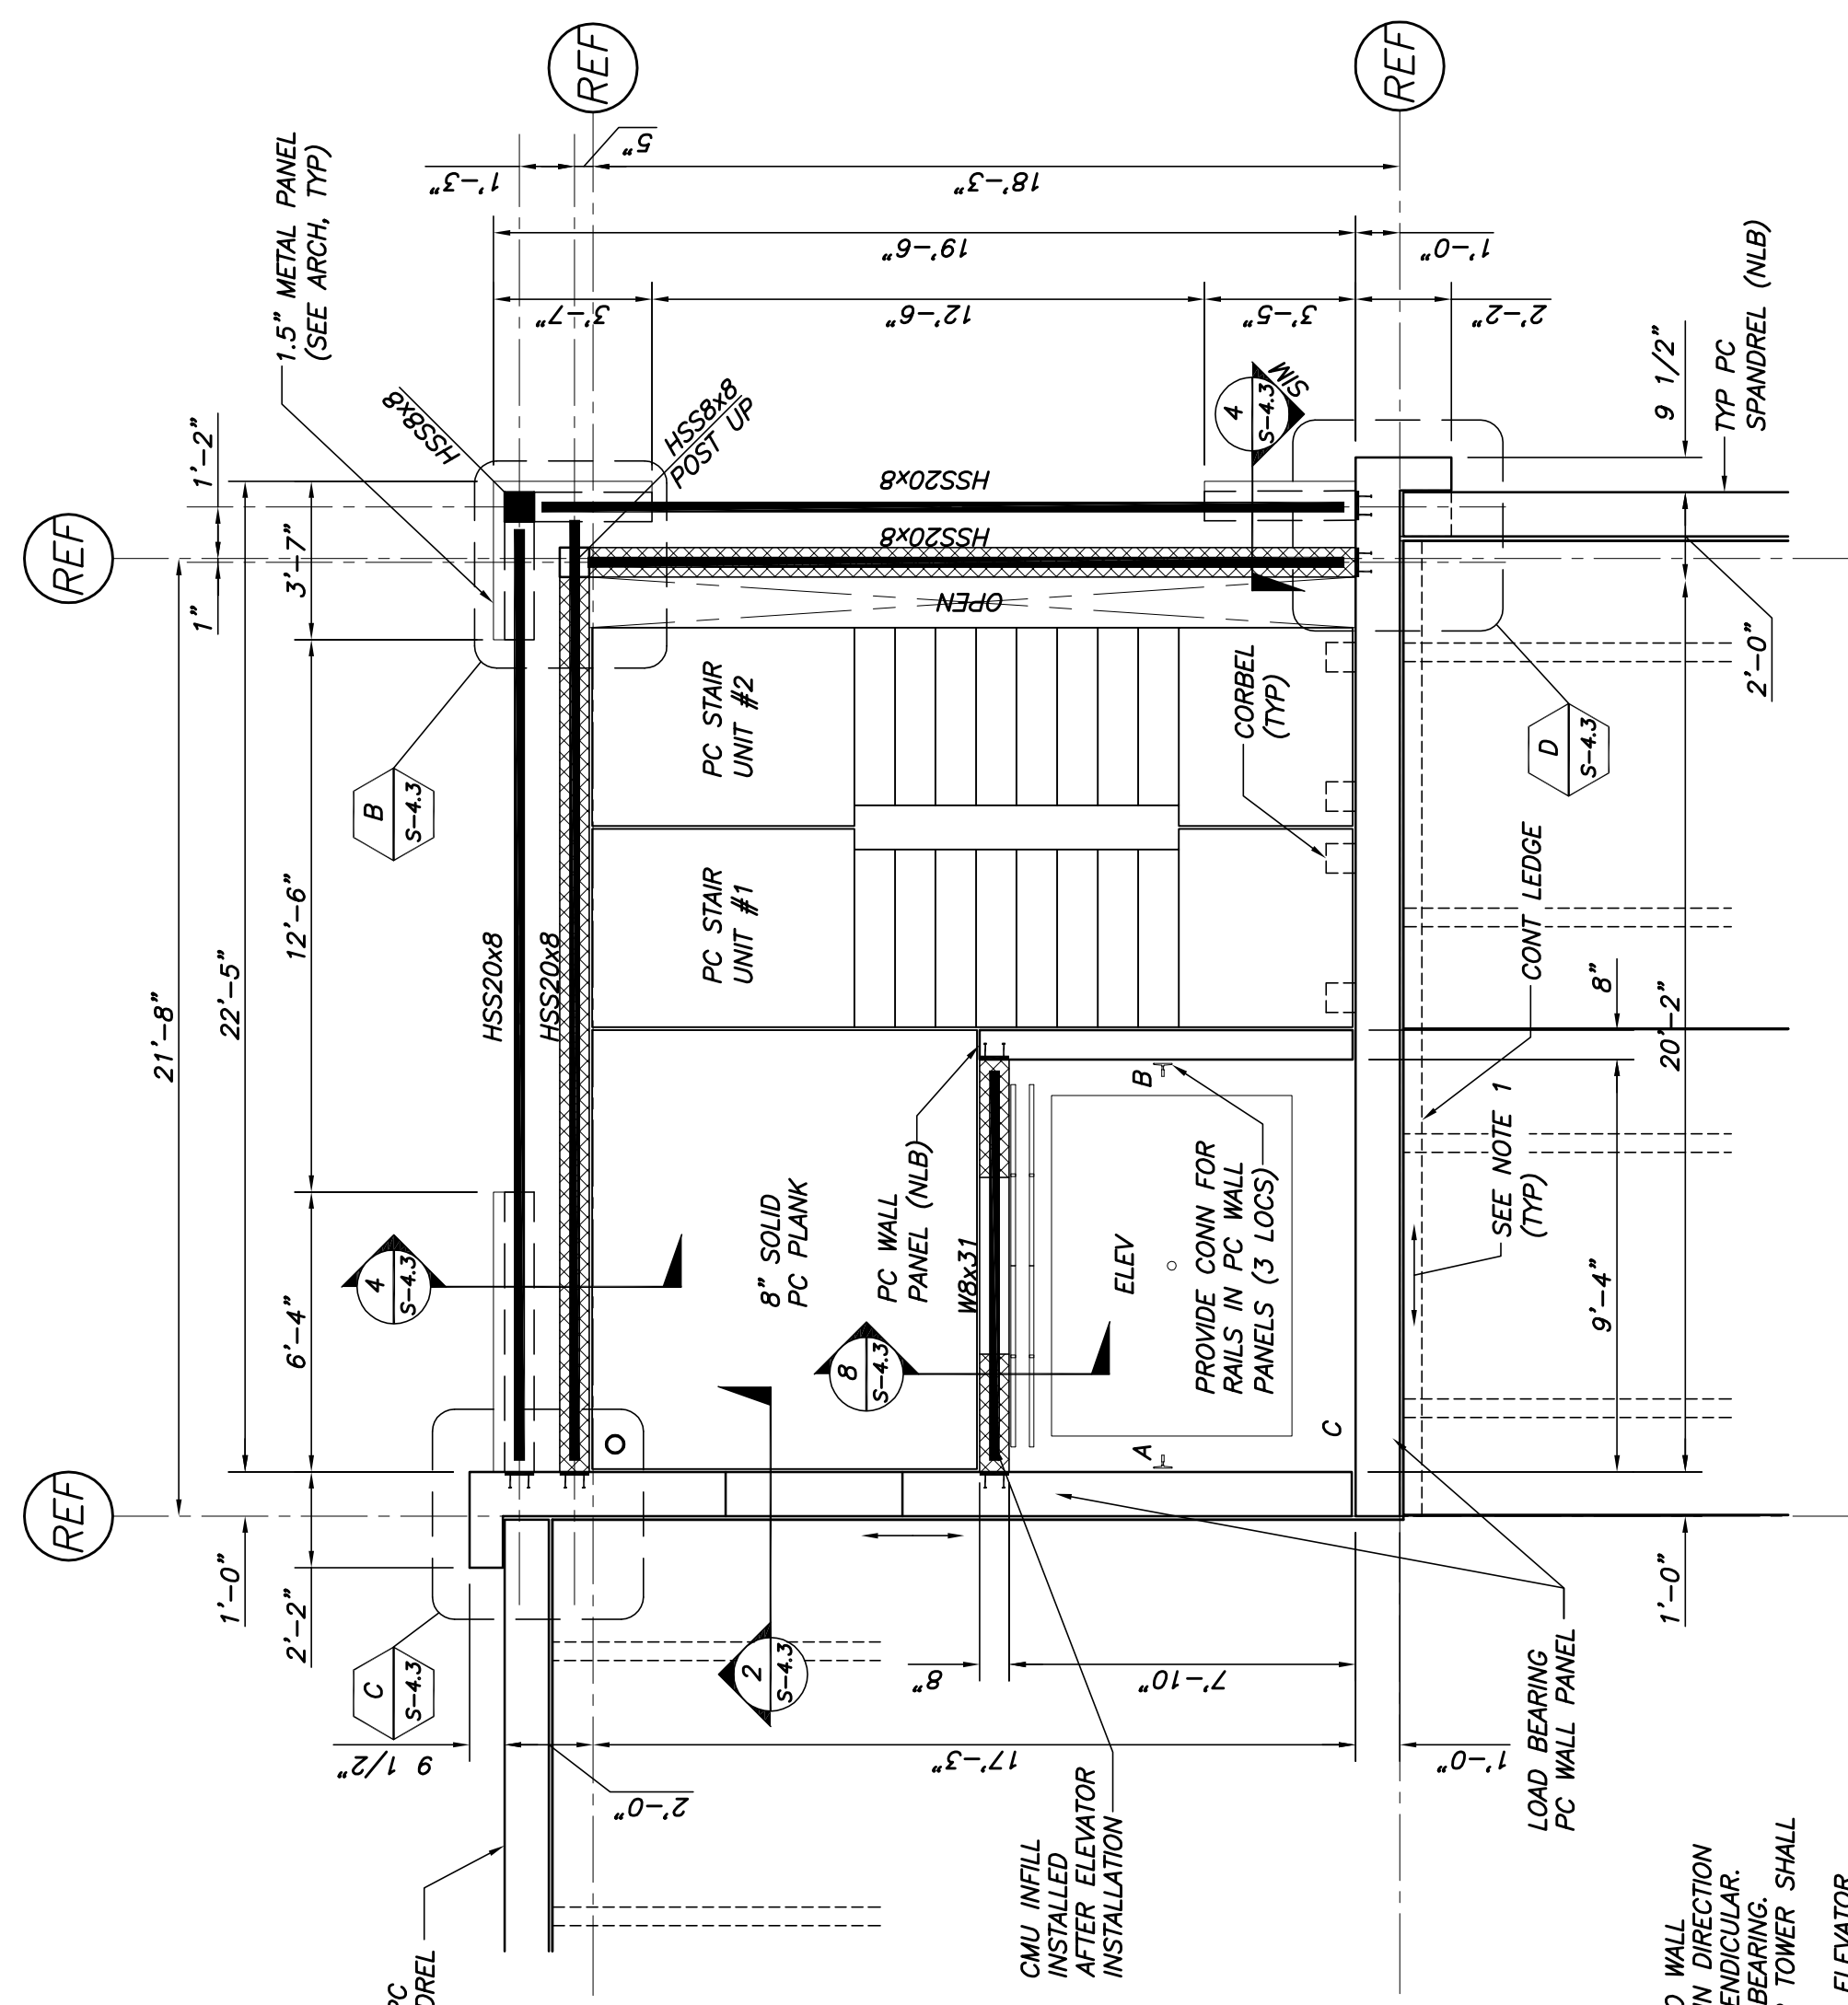


**STAIR/LOBBY LEVEL 8 PLAN**  
 1/4"=1'-0"  
 TOP OF STEEL EL 87'-0" U.N.O.

- NOTES:**
1. PROVIDE CONNECTION OF DTS TO WALL PANELS THAT ALLOW MOVEMENT IN DIRECTION OF ARROWS AND RESTRAIN PERPENDICULAR. PROVIDE SLIDE BEARINGS AT DT BEARING. ALL WALKING SURFACES IN STAIR TOWER SHALL HAVE LIGHT BROOM FINISH.
  2. ELEVATOR (REF ARCH DWGS AND ELEVATOR MANUFACTURER'S MANUALS).
  3. MODEL: ECOSPACE  
 CAPACITY: 3500 lbs  
 DIMENSIONS AS SHOWN  
 DETAILS INDICATES MOMENT CONNECTION. SEE DETAILS FOR CONNECTION OF 1/2" ROOF DECK  
 BP-X INDICATES COLUMN BASE PL, SEE DETAILS S4.0

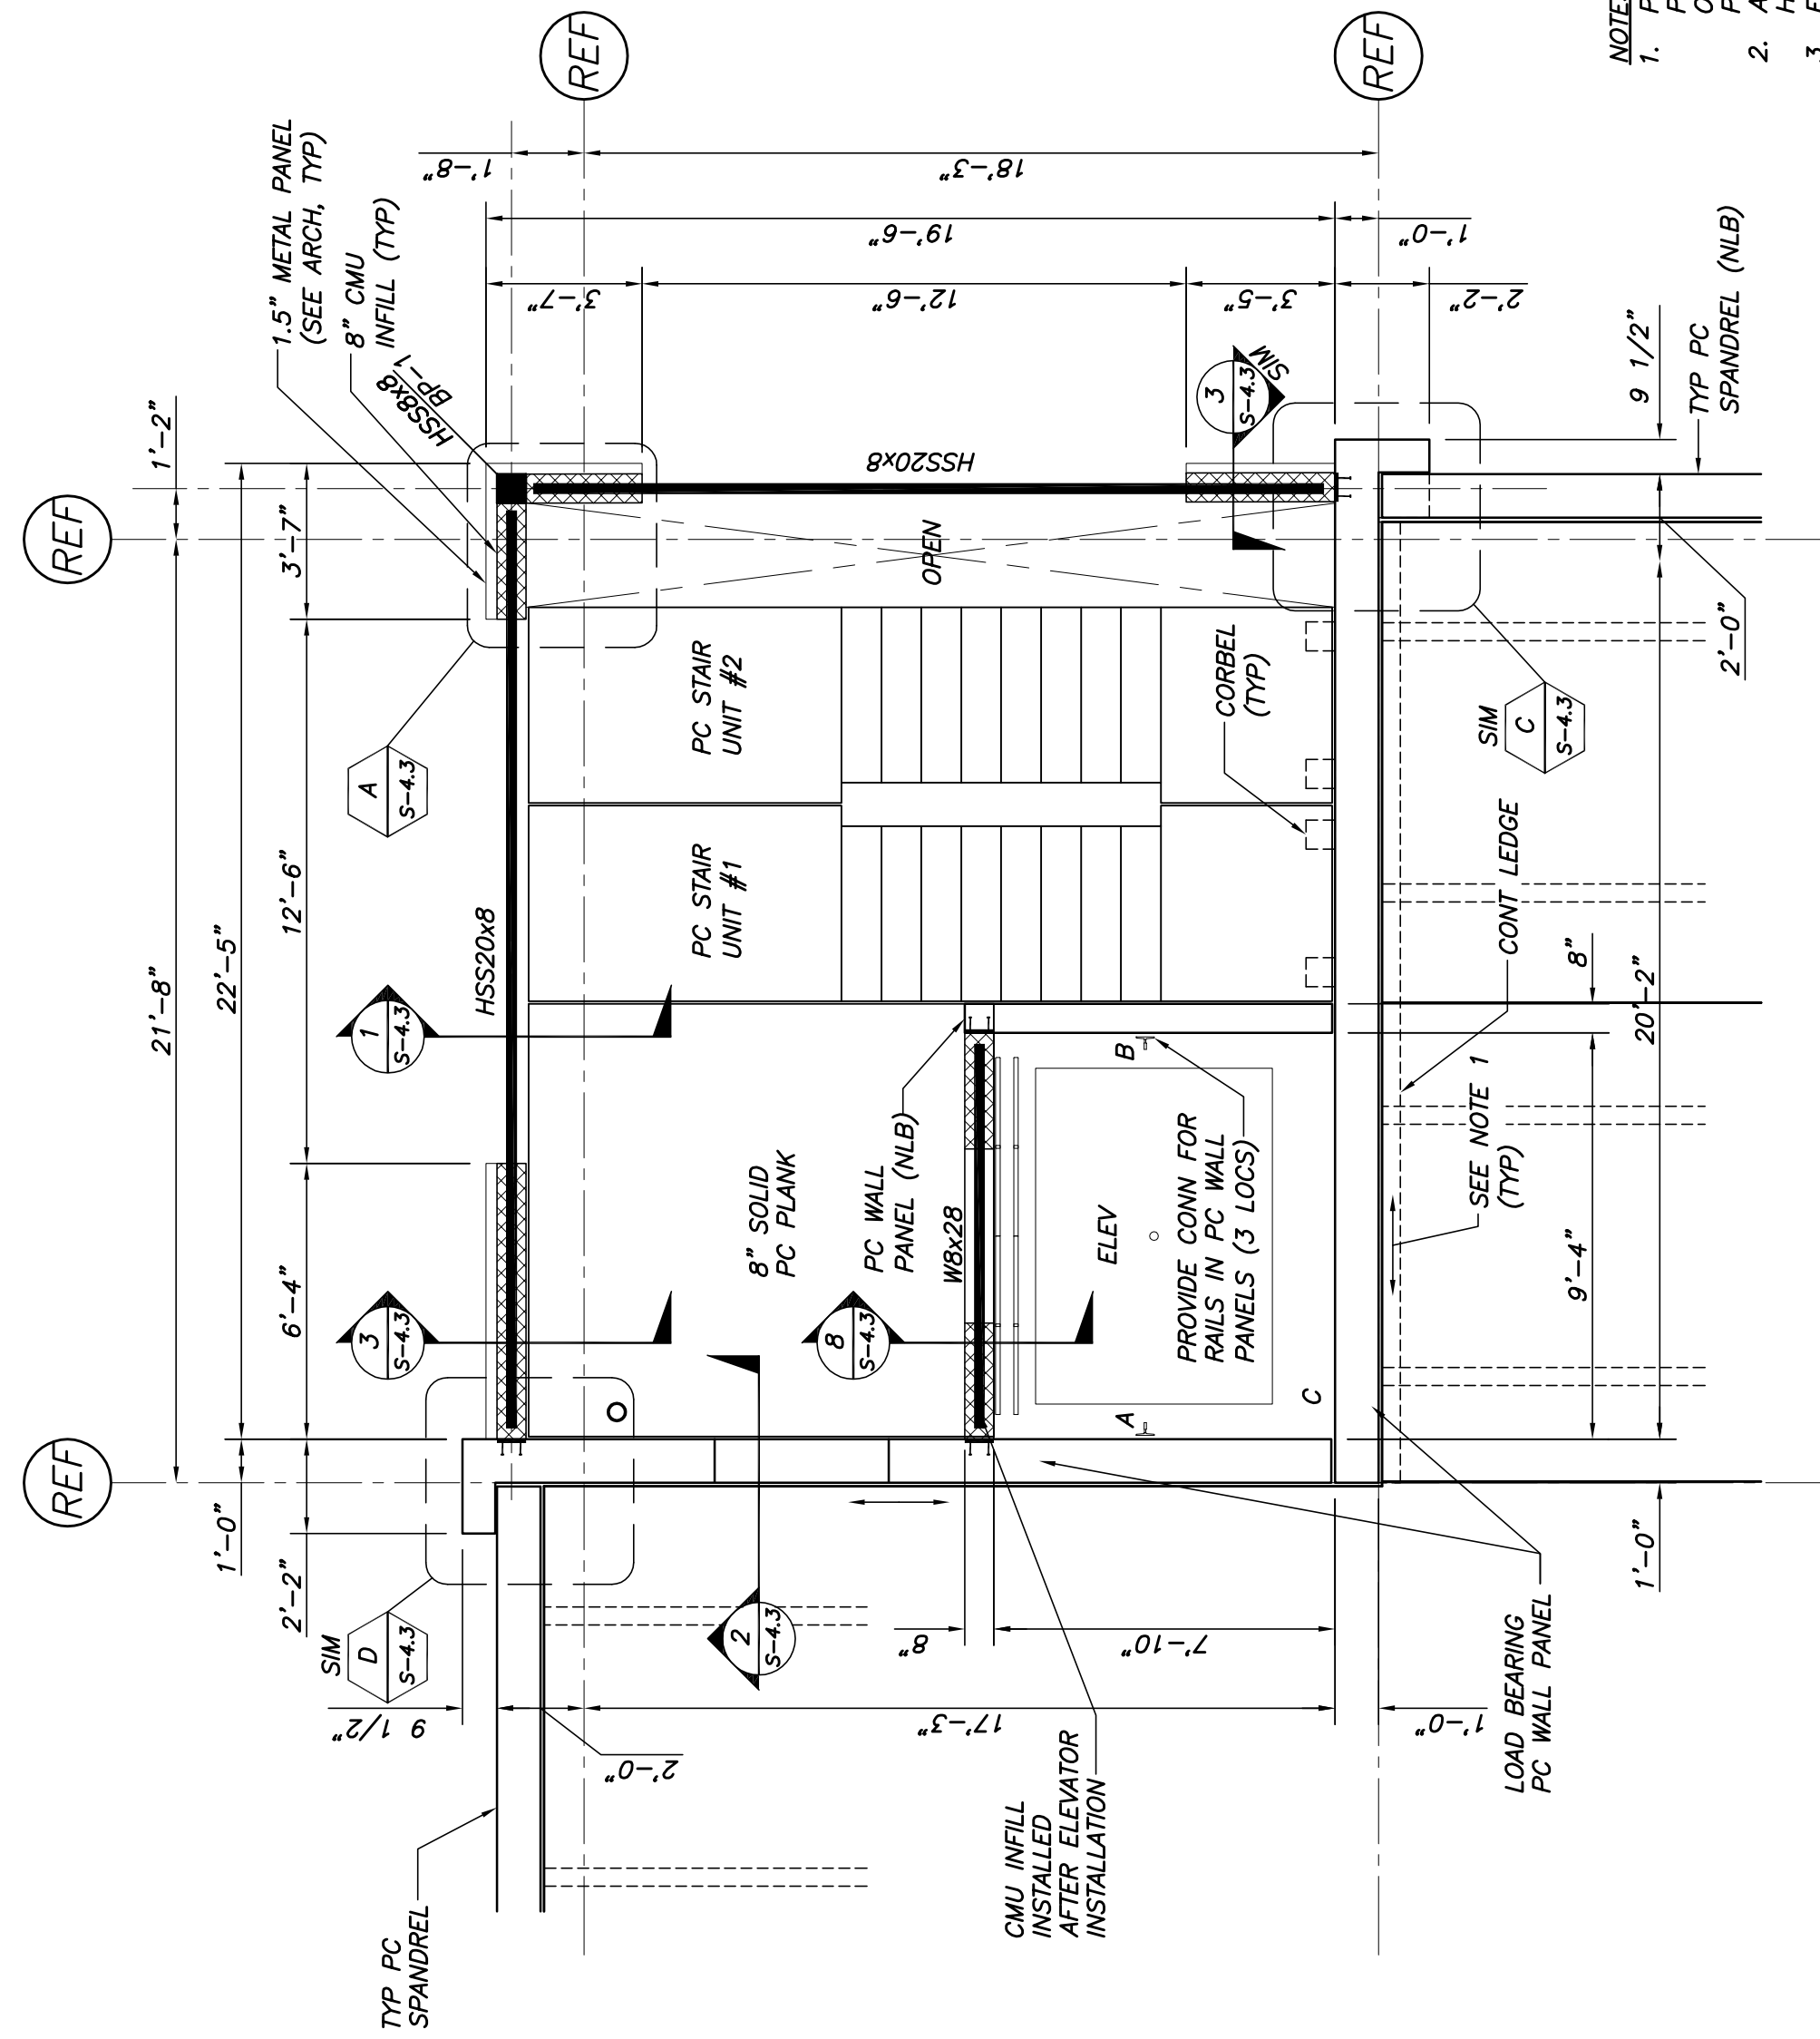


**TYP STAIR/LOBBY PLAN**  
 1/4"=1'-0"  
 TOP OF STEEL EL U.N.O.

- LEVEL 2: 84'-0"  
 LEVEL 3: 85'-8"  
 LEVEL 4: 87'-0"  
 LEVEL 5: 88'-0"  
 LEVEL 6: 89'-4"  
 LEVEL 7: 90'-8"

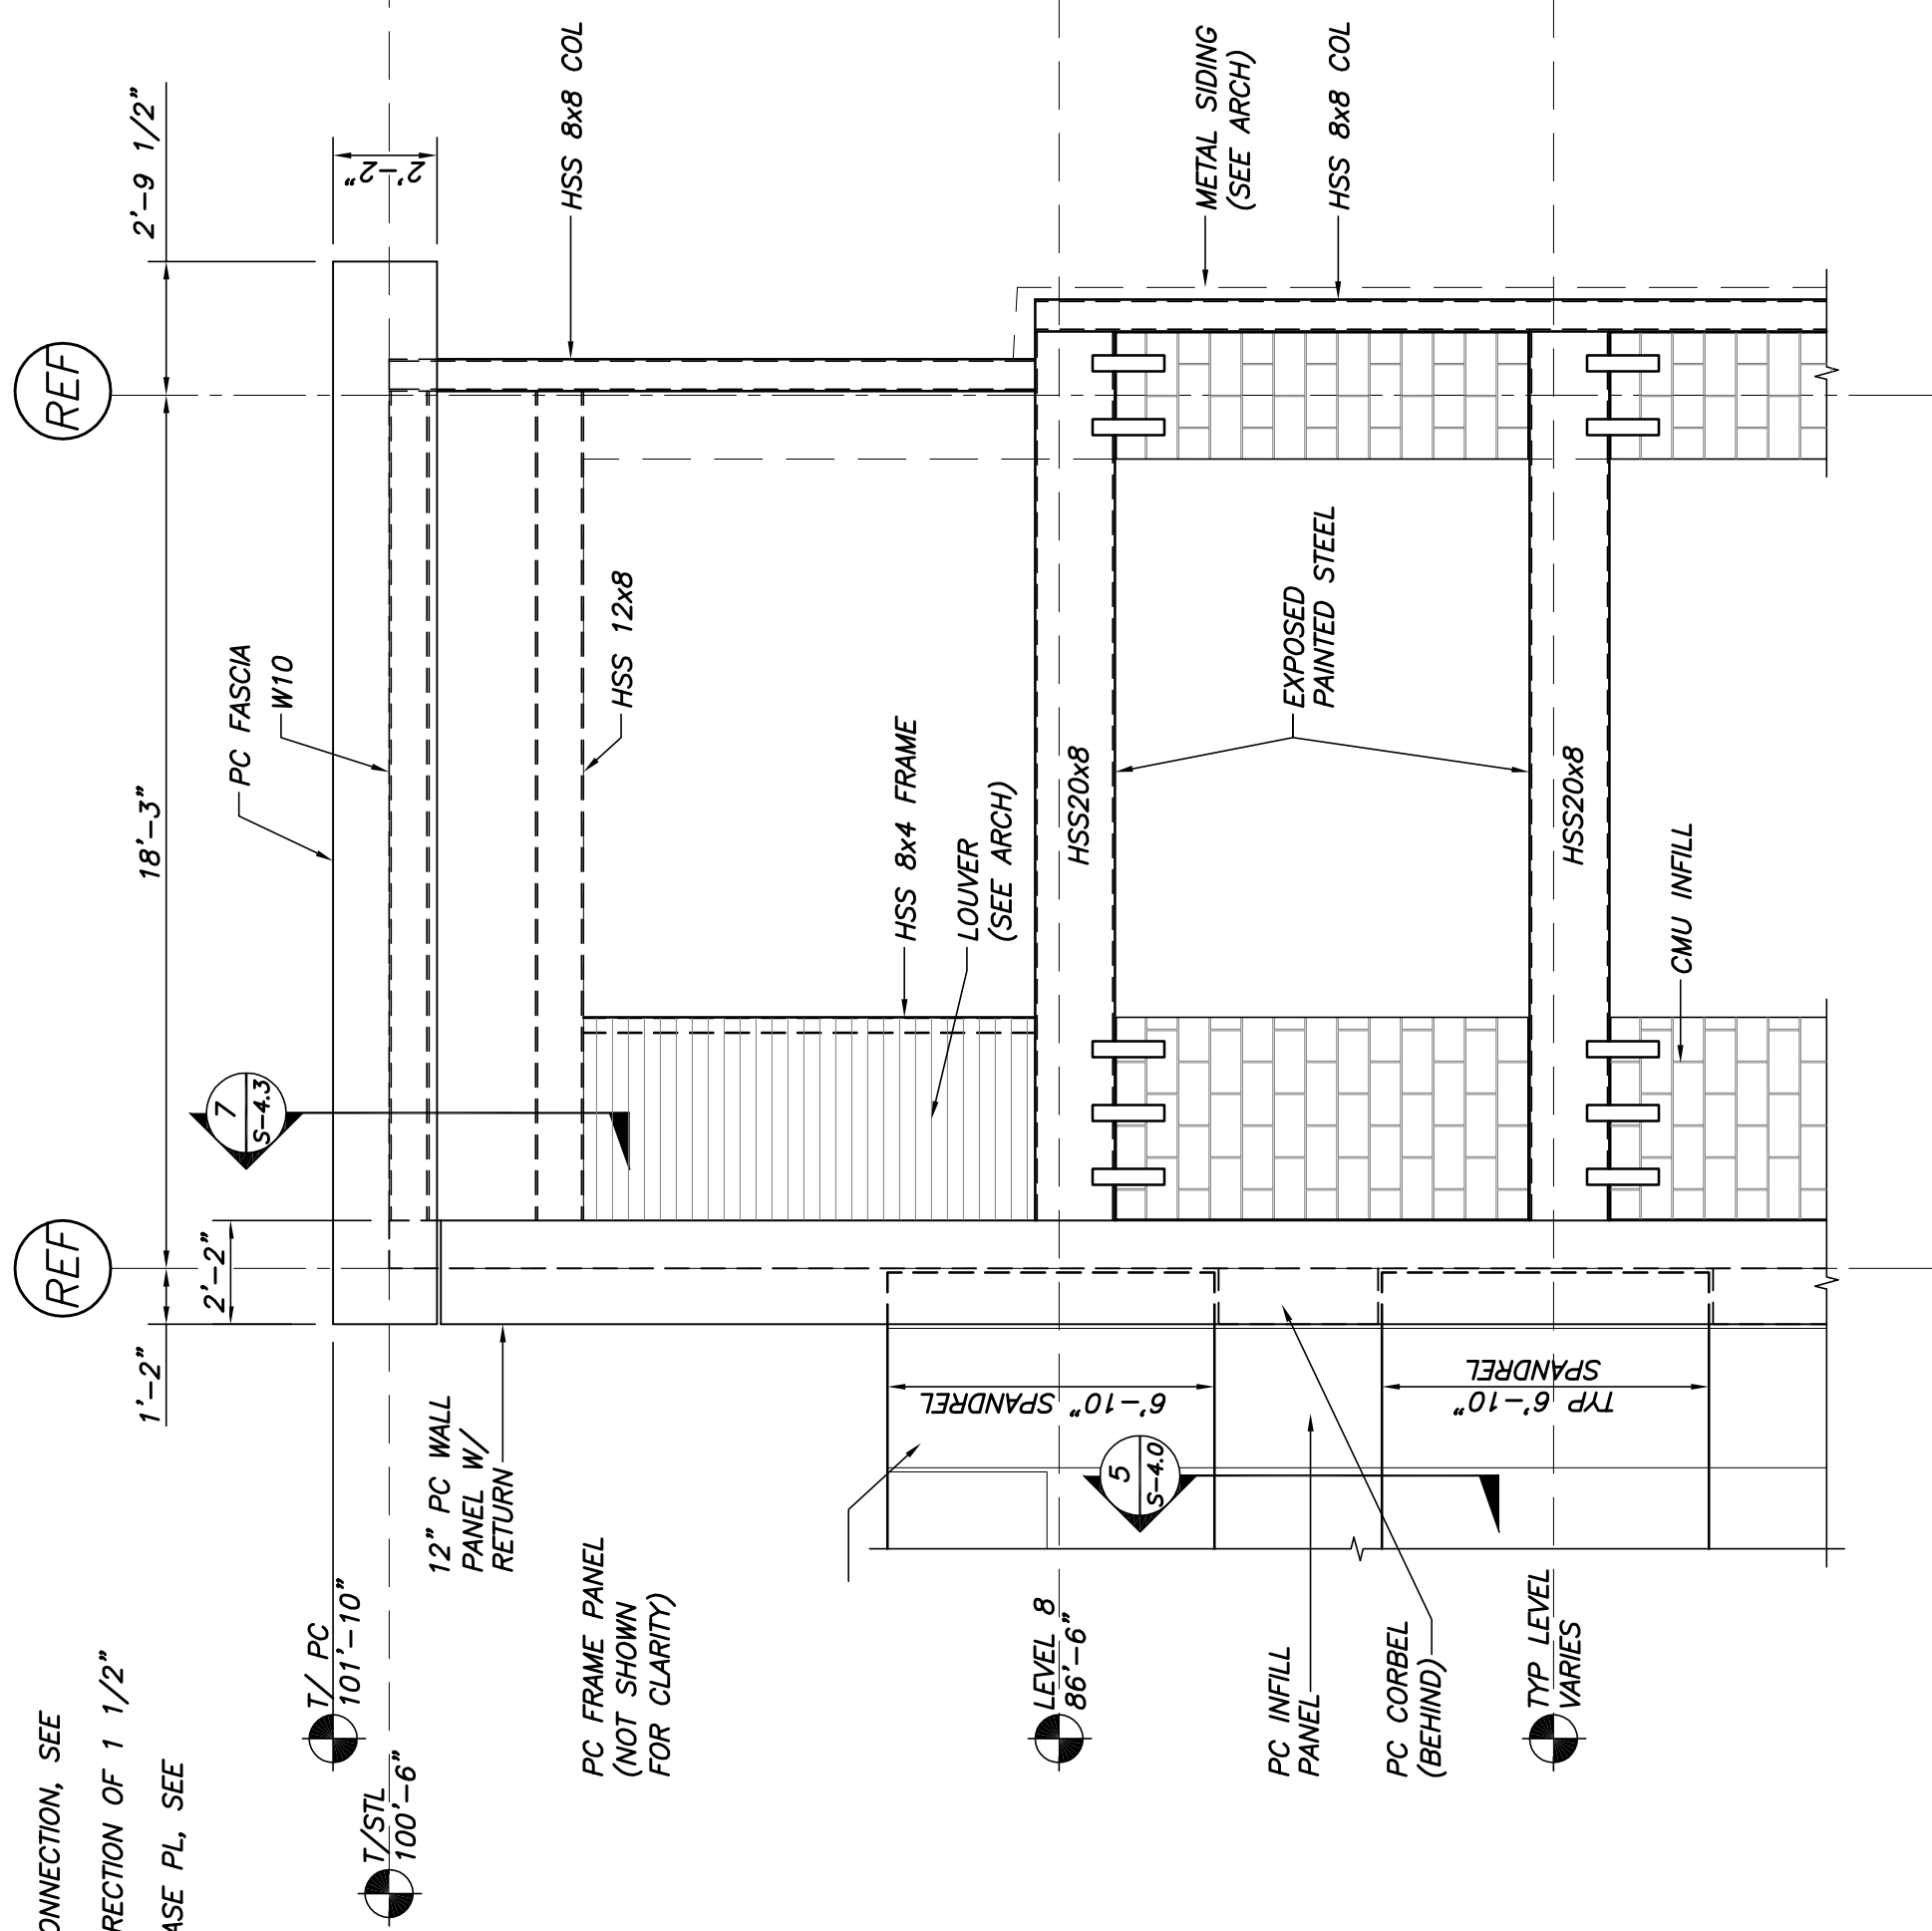

**TYP STAIR TOWER FRAMING ELEVATION**  
 1/4"=1'-0"

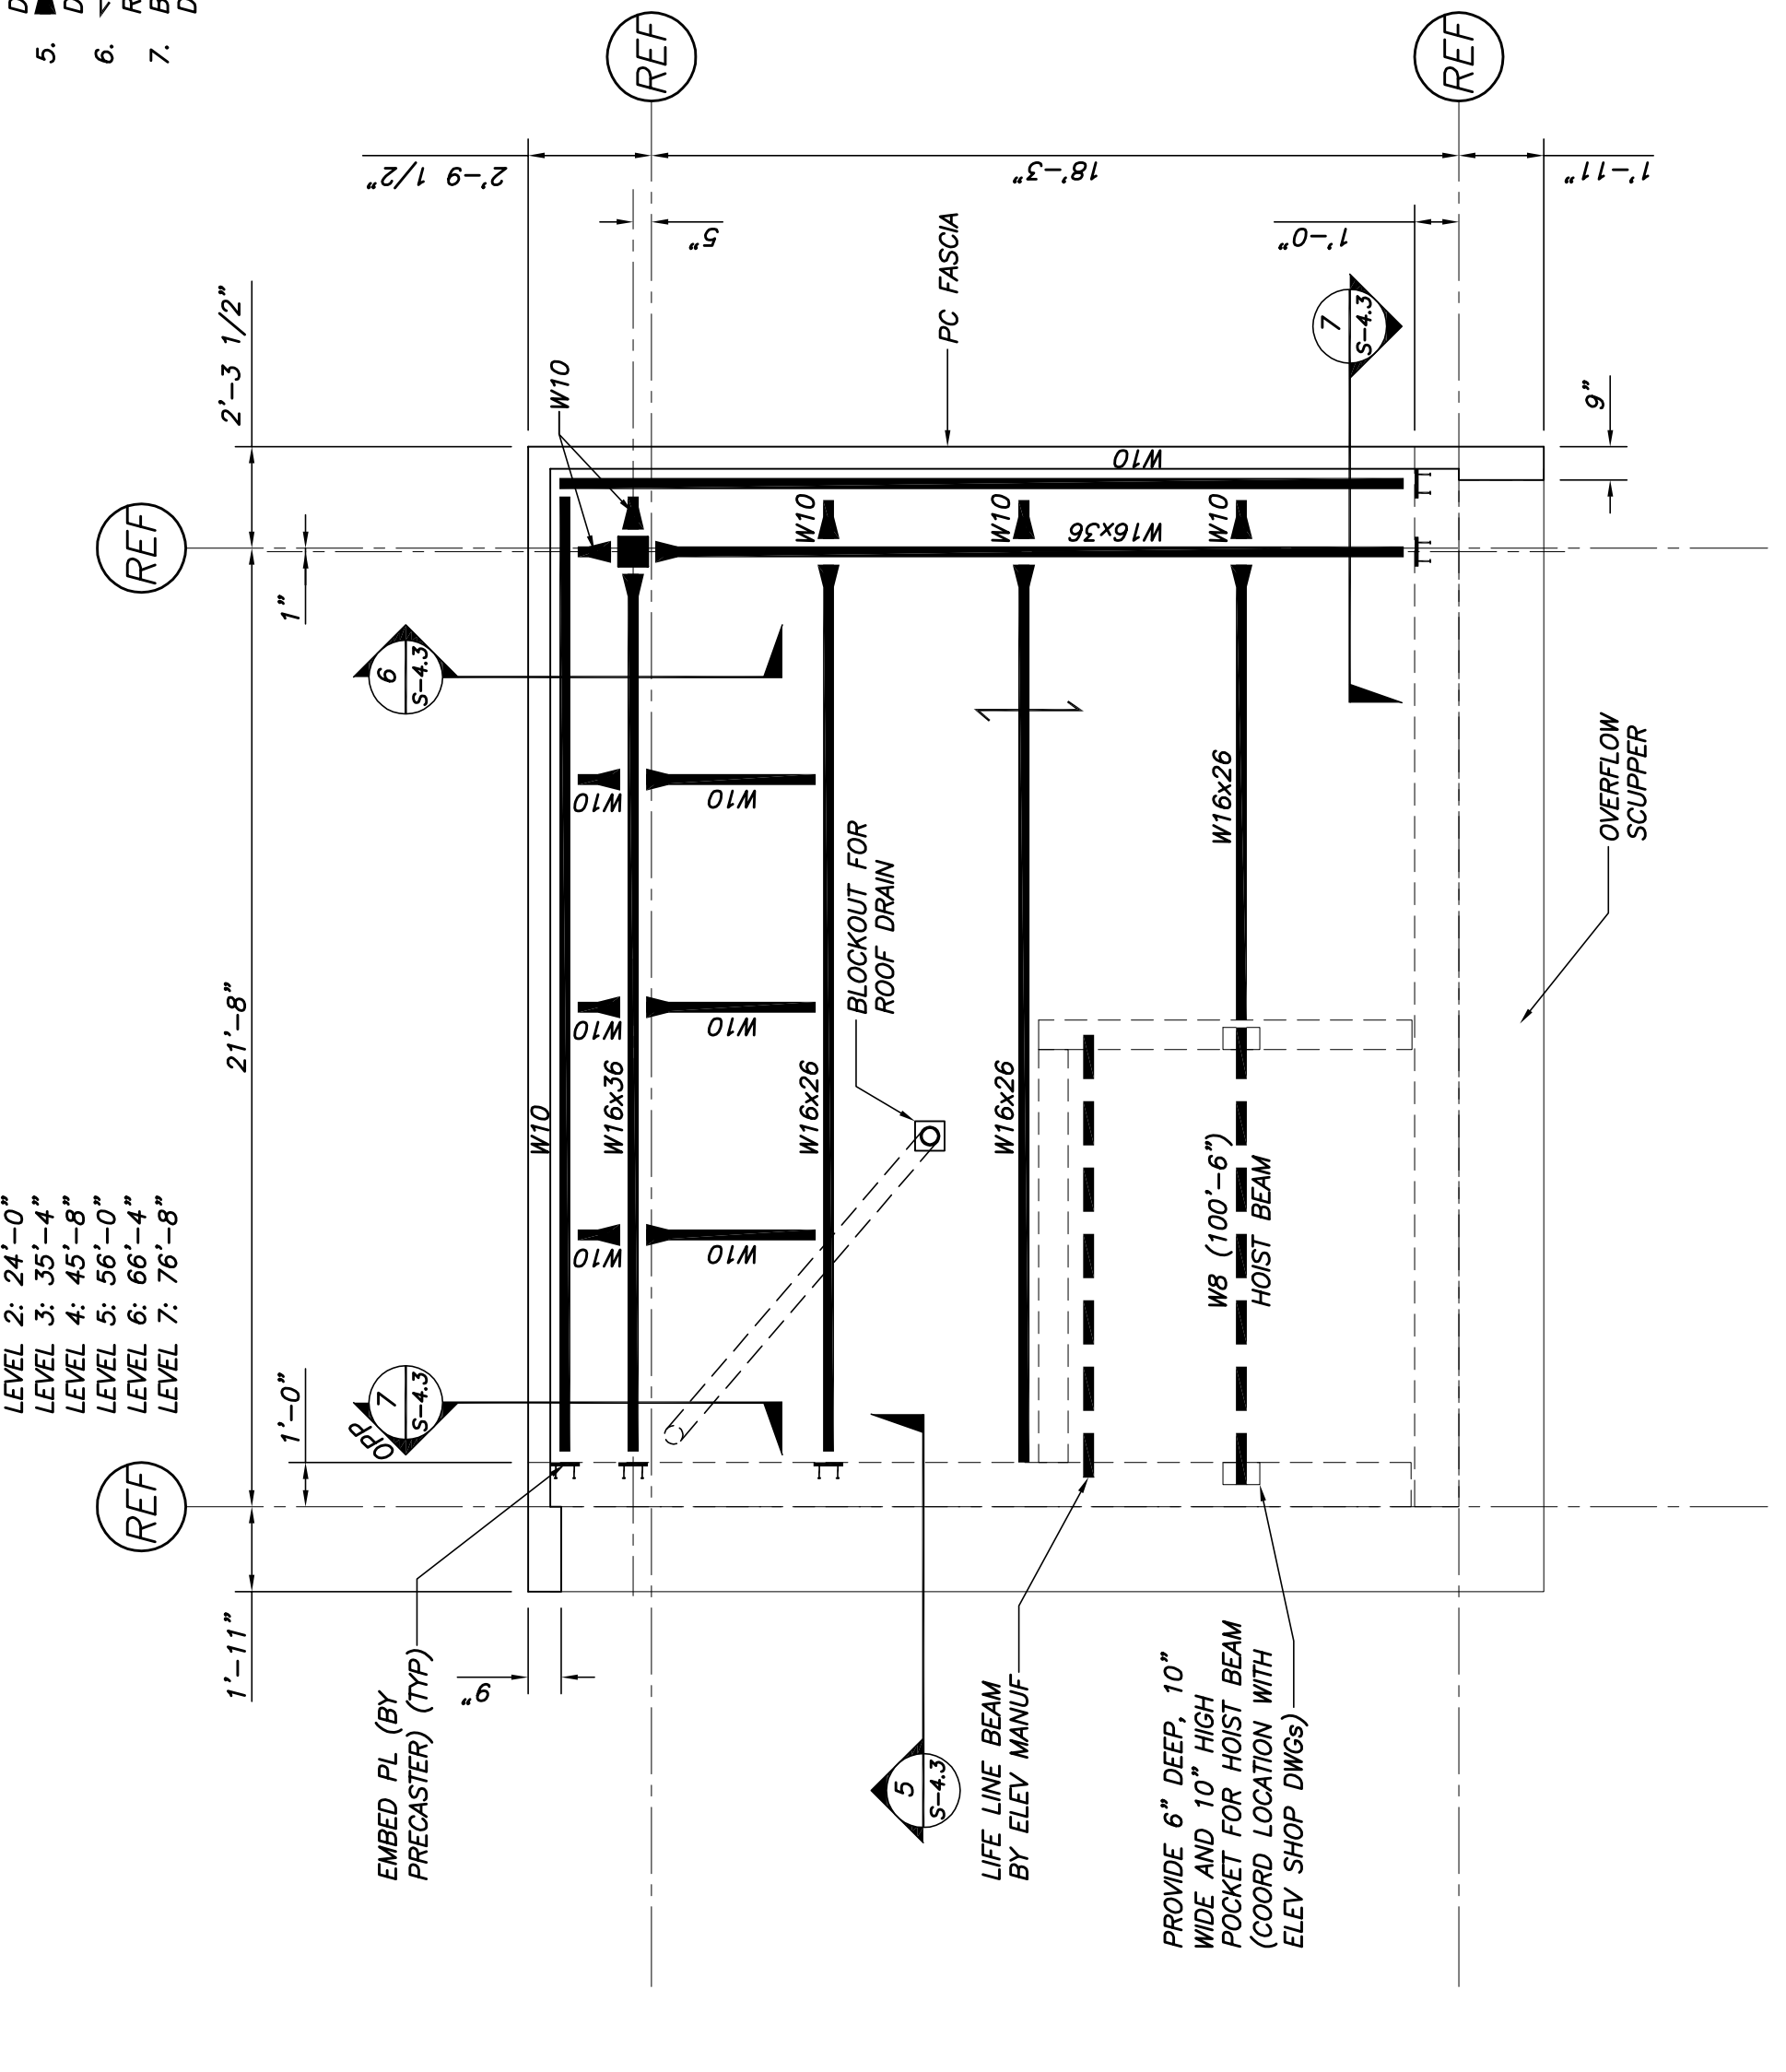

**STAIR TOWER ROOF PLAN**  
 1/4"=1'-0"  
 TOP OF STEEL EL 100'-6" U.N.O.

NOT FOR CONSTRUCTION  
 REVISED PERMIT SET  
 4/15/16