


NO	SCALE	REF.	NO	SCALE	REF.	NO	SCALE	REF.	NO	SCALE	REF.	NO	SCALE	REF.	
D1	1/8" = 1'-0"		D2	1/8" = 1'-0"		D3	1/8" = 1'-0"		D4	1/8" = 1'-0"		D5	1/8" = 1'-0"		
D6	1/8" = 1'-0"		D7	1/8" = 1'-0"		D8	1/8" = 1'-0"		D9	1/8" = 1'-0"					

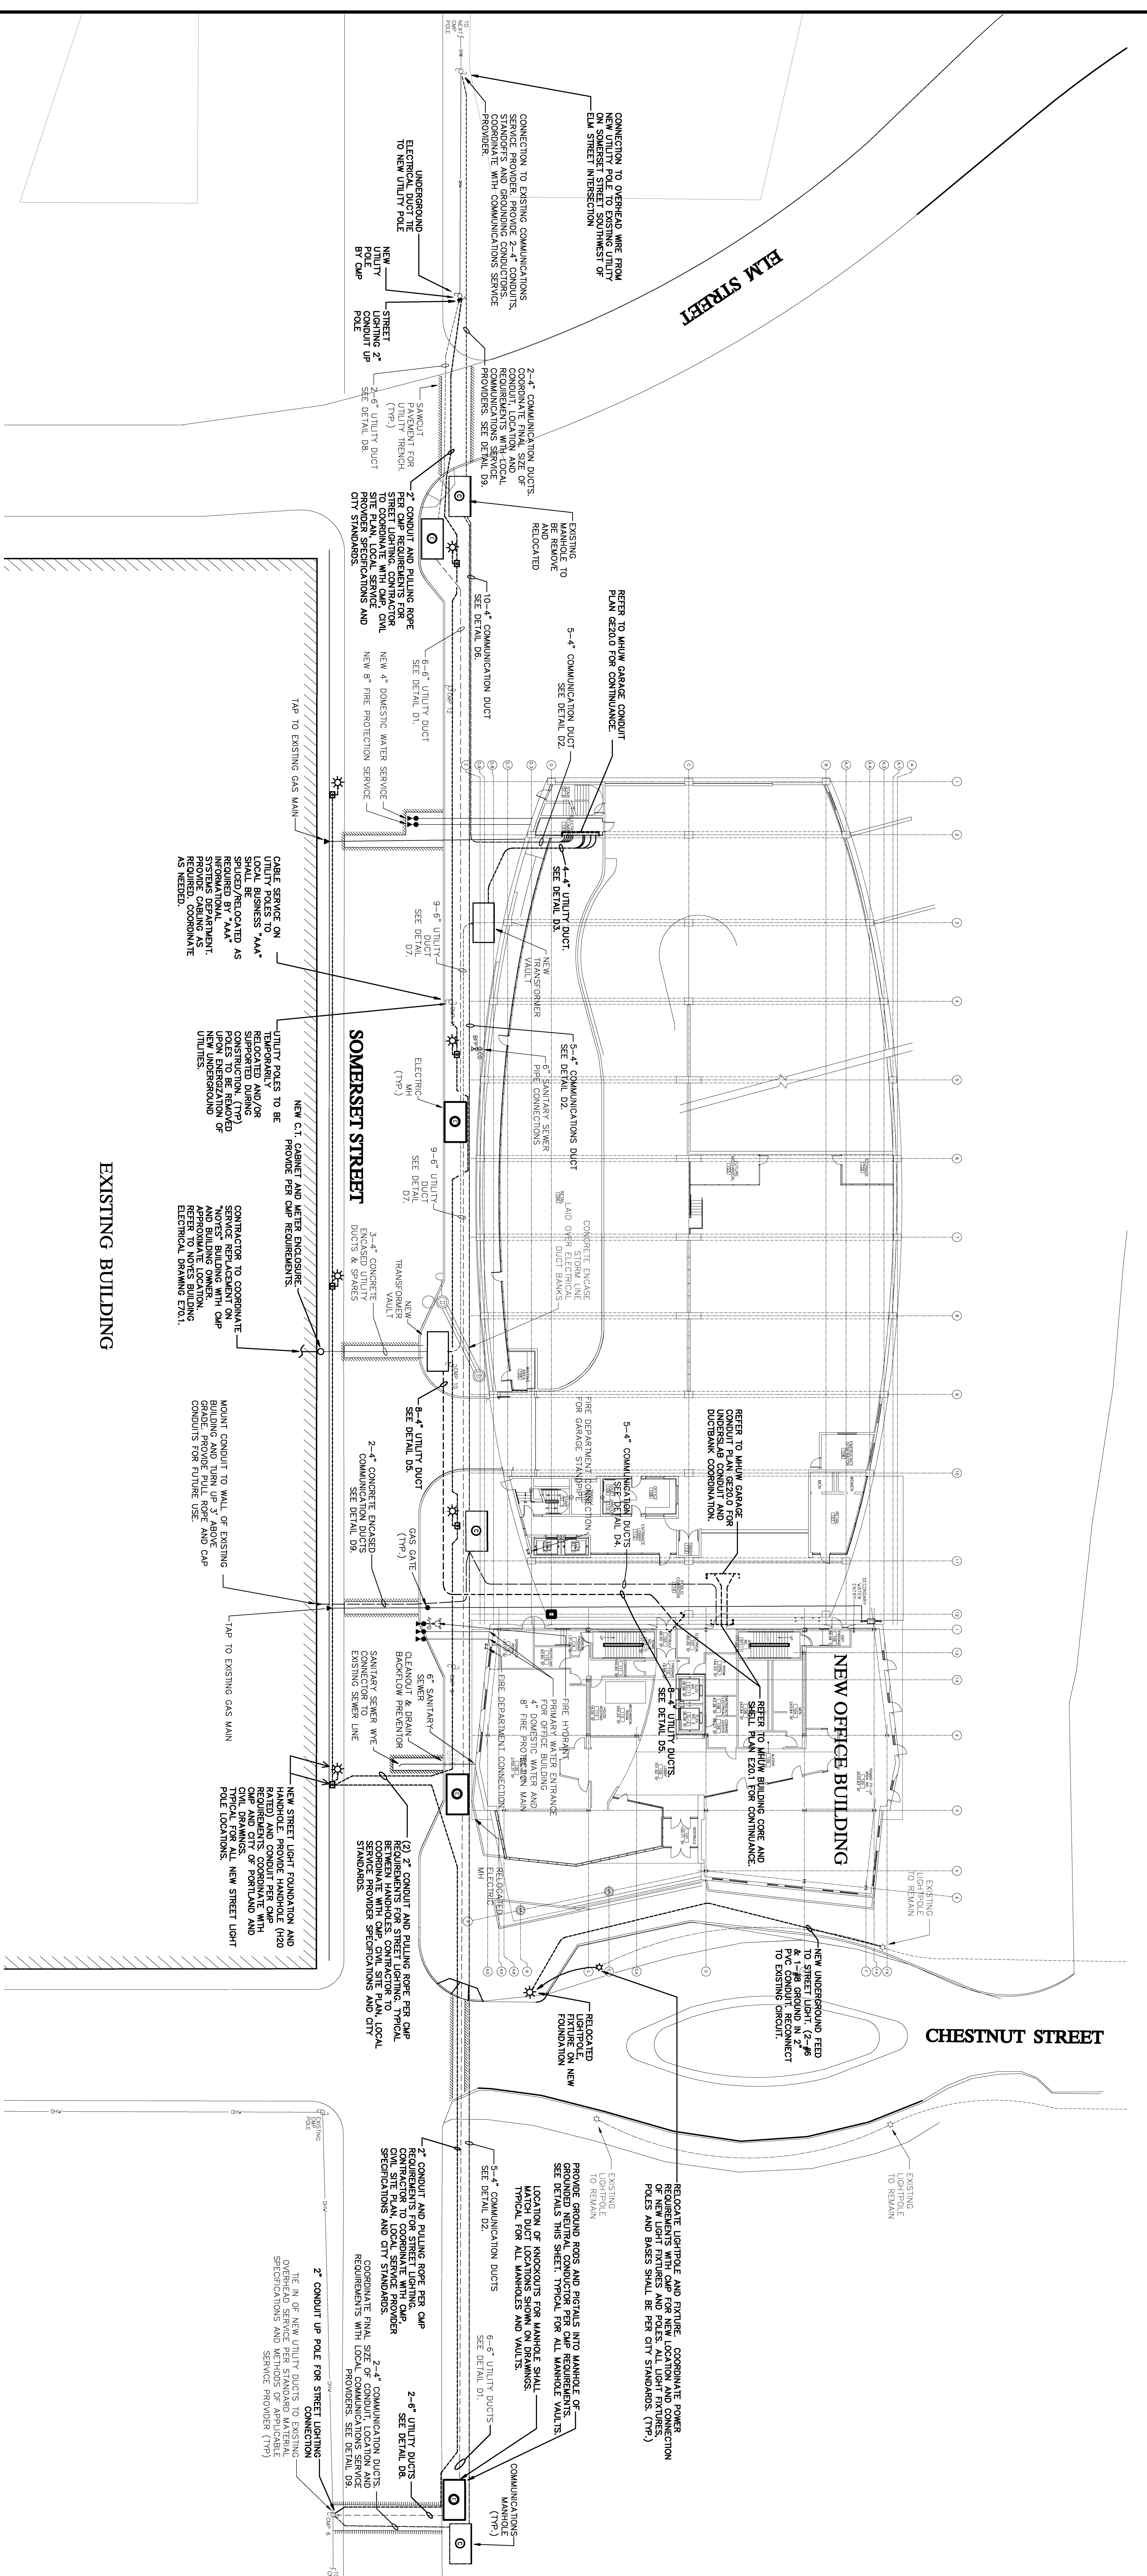

**SITE PLAN GENERAL NOTES**

1. COORDINATE UNDERGROUND CONDUITS WITH OTHER TRADES. COORDINATE WITH POWER ENGINEER REGARDING GROUND RODS, CABLES, AND CONNECTIONS INCLUDING CONNECTIONS TO EXISTING AND BUILDING STEEL FRAME TO FORMING OF CONCRETE.
2. ELECTRICAL WORK SHALL MEET "CIP" REQUIREMENTS FOR THE "30" PROVIDE NON-METALLIC CABLE RINGS INTERNAL TO MANHOLE.
3. TRANSFORMER WALLS SHALL MEET "CIP" REQUIREMENTS. PROVIDE NON-METALLIC CABLE RINGS.
4. COMMUNICATIONS MANHOLE SHALL MEET THROUGH COMMUNICATIONS' REQUIREMENTS FOR THE "30" PROVIDE NON-METALLIC CABLE RINGS.

**ELECTRICAL SITE PLAN**  
SCALE: 1" = 30'-0"

**COORDINATE INSTALLATION WITH CIVIL SITE PLANS.**

**CONSTRUCTION MANAGER**

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**Project Title**  
BAYCO LLC.  
BAYSIDE DEVELOPMENT  
PORTLAND, MAINE

**Project No.**  
08576

**Key Plan**  
30 Bay Street Building

**General Notes or Legends Here**

Work	Date	Description
-	1.07.09	SITE ENABLING PACKAGE
-	12-19-08	SITE ENABLING PACKAGE

**Drawing Title**  
Electrical Site Plan

**Drawing Status**

**Drawn By**  
VRI

**Checked By**  
CJB

**ES21.0**