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PROJECT
191 MARGINAL WAY
RETAIL CENTER

DRAWING
HIGH ROOF FRAMING
PLAN & TOP OF DOOR
FRAMING PLAN

191 MARGINAL WAY
PORTLAND, MAINE 04101



CWS PROJECT NUMBER: 15.063

REVISIONS

DRAWING NUMBER


S1.2A

SCALE: NOTED
DATE: 02/10/2017

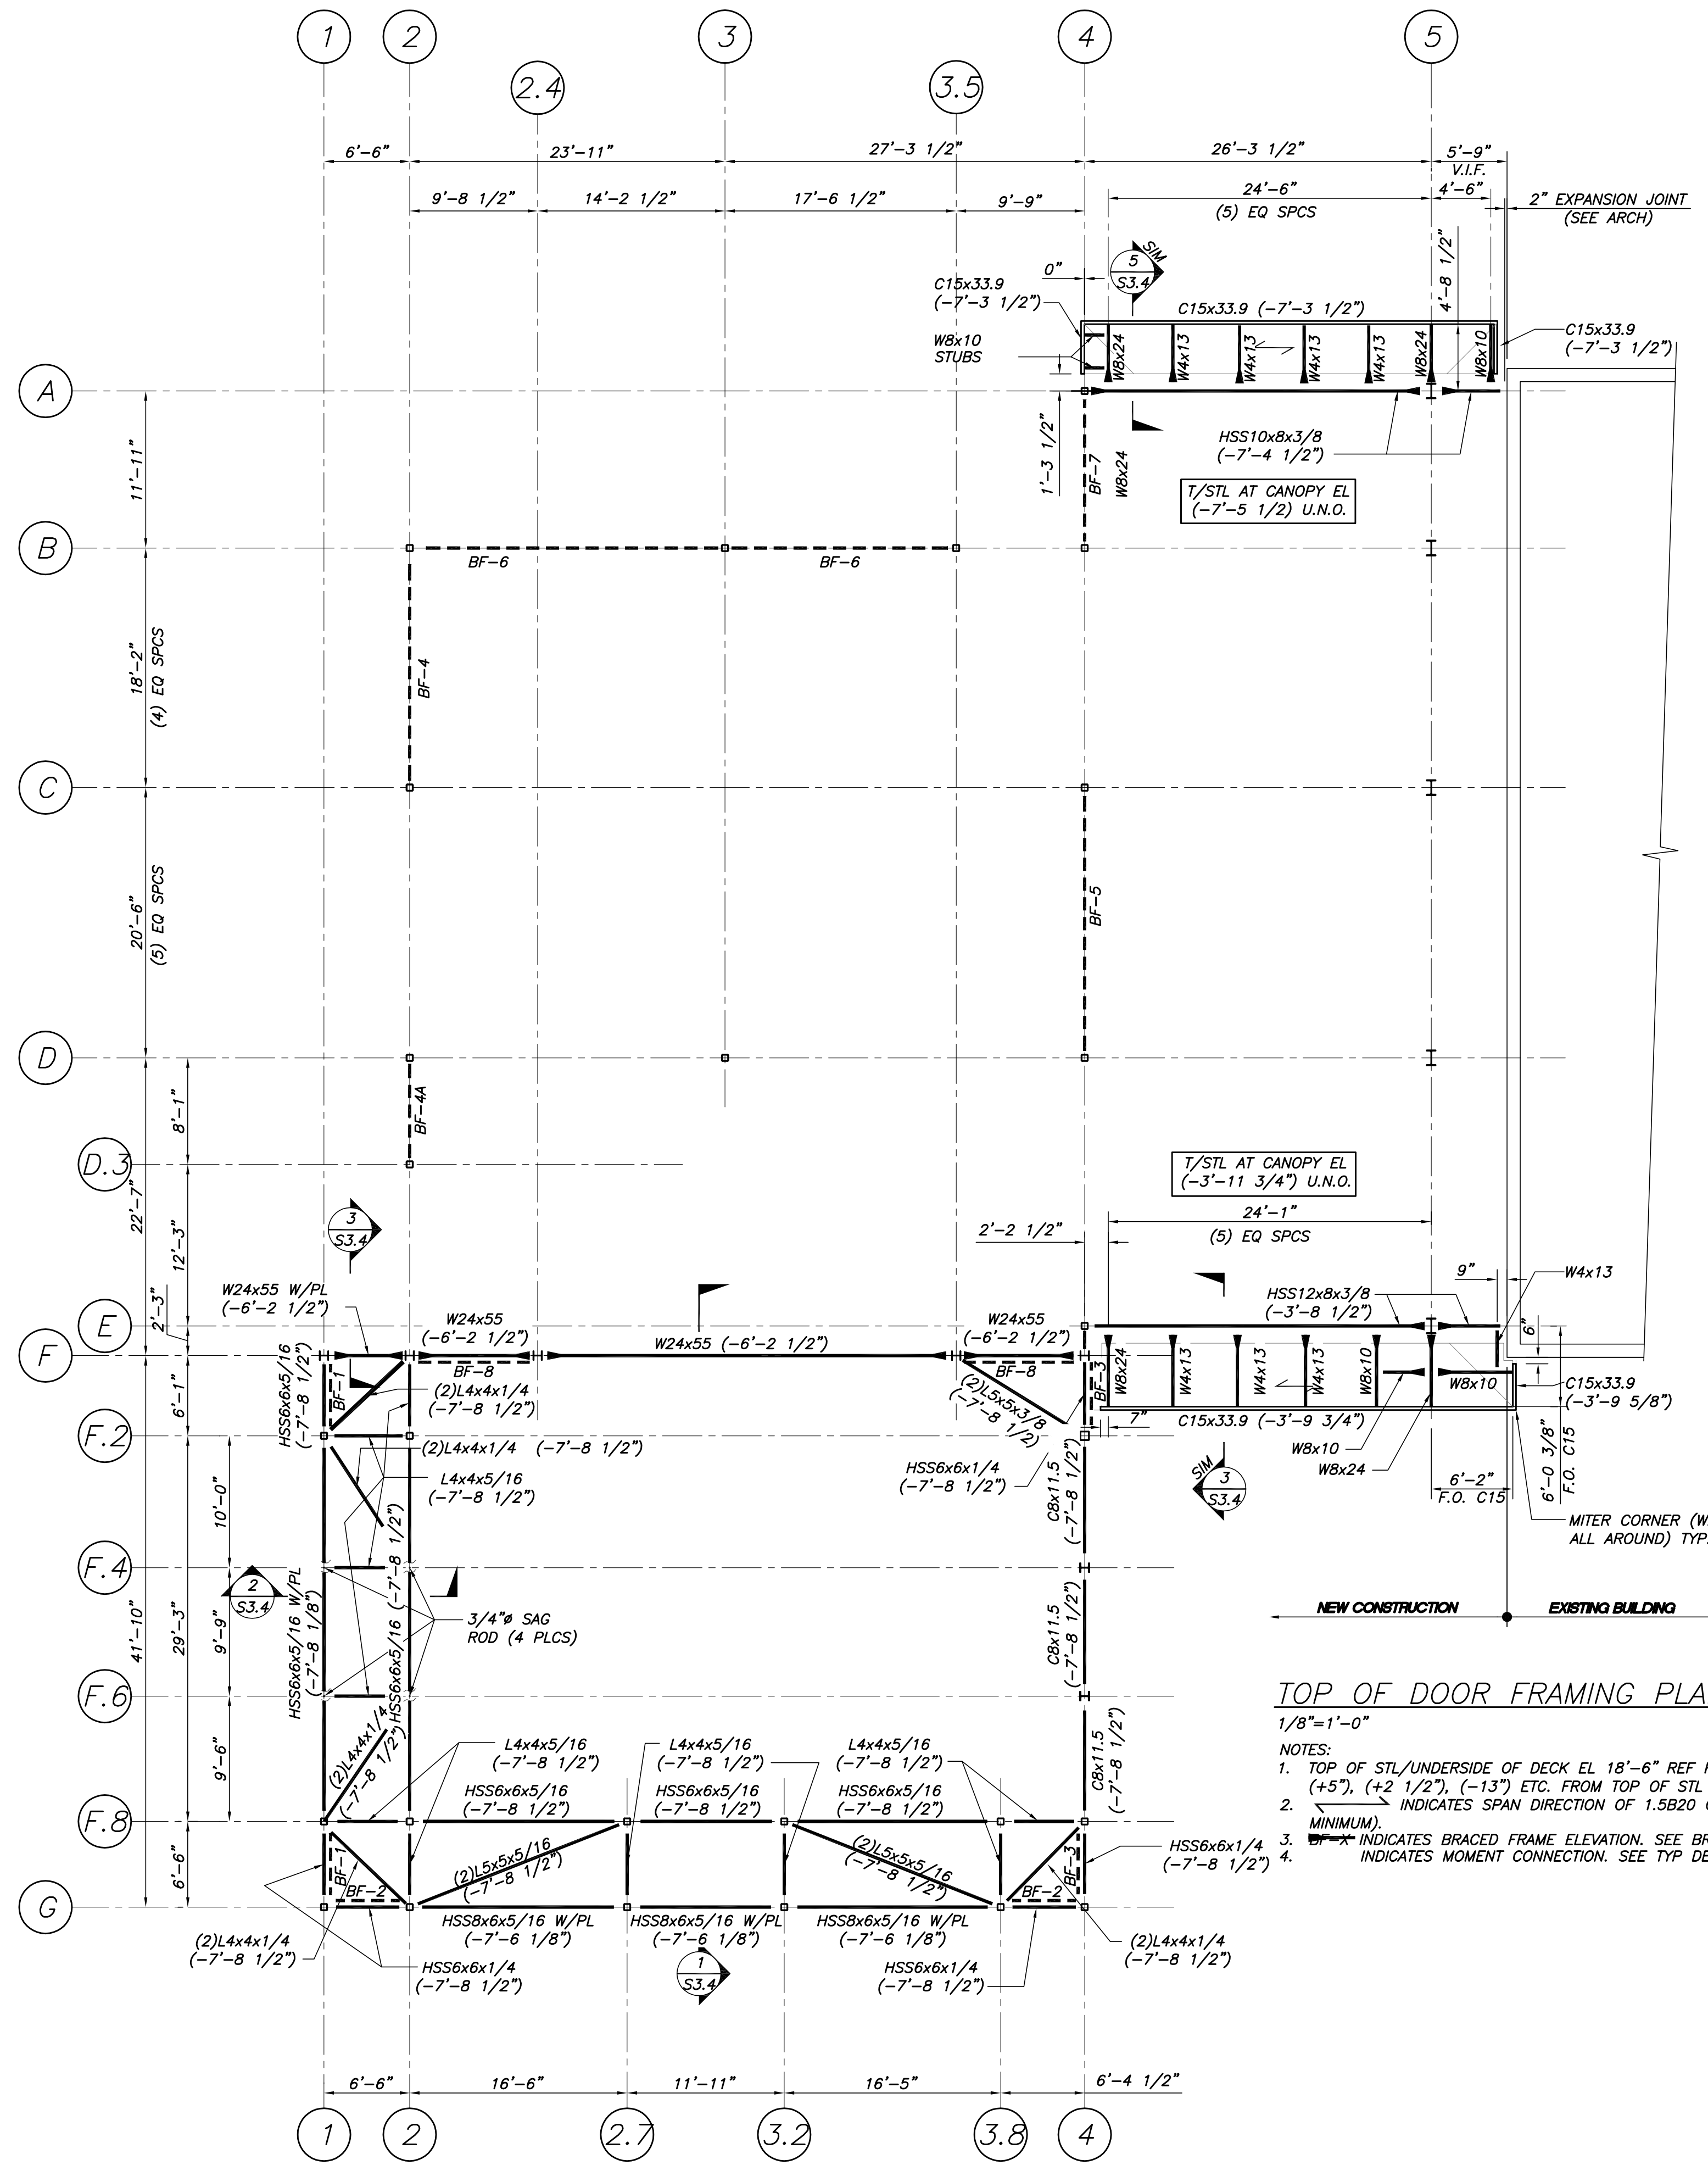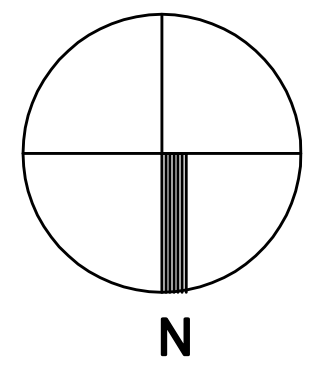

TOP OF DOOR FRAMING PLAN

- 1/8"=1'-0"
- NOTES:
1. TOP OF STL/UNDERSIDE OF DECK EL 18'-6" REF FROM F.F. ELEV (0'-0") U.N.O. BY (+5"), (+2 1/2"), (-13") ETC. FROM TOP OF STL EL.
 2. --- INDICATES SPAN DIRECTION OF 1.5B20 GALV STL ROOF DECK (3 SPAN MINIMUM).
 3. --- INDICATES BRACED FRAME ELEVATION. SEE BRACED FRAME ELEVATIONS DWG S1.3.
 4. --- INDICATES MOMENT CONNECTION. SEE TYP DETAILDWG S3.1.

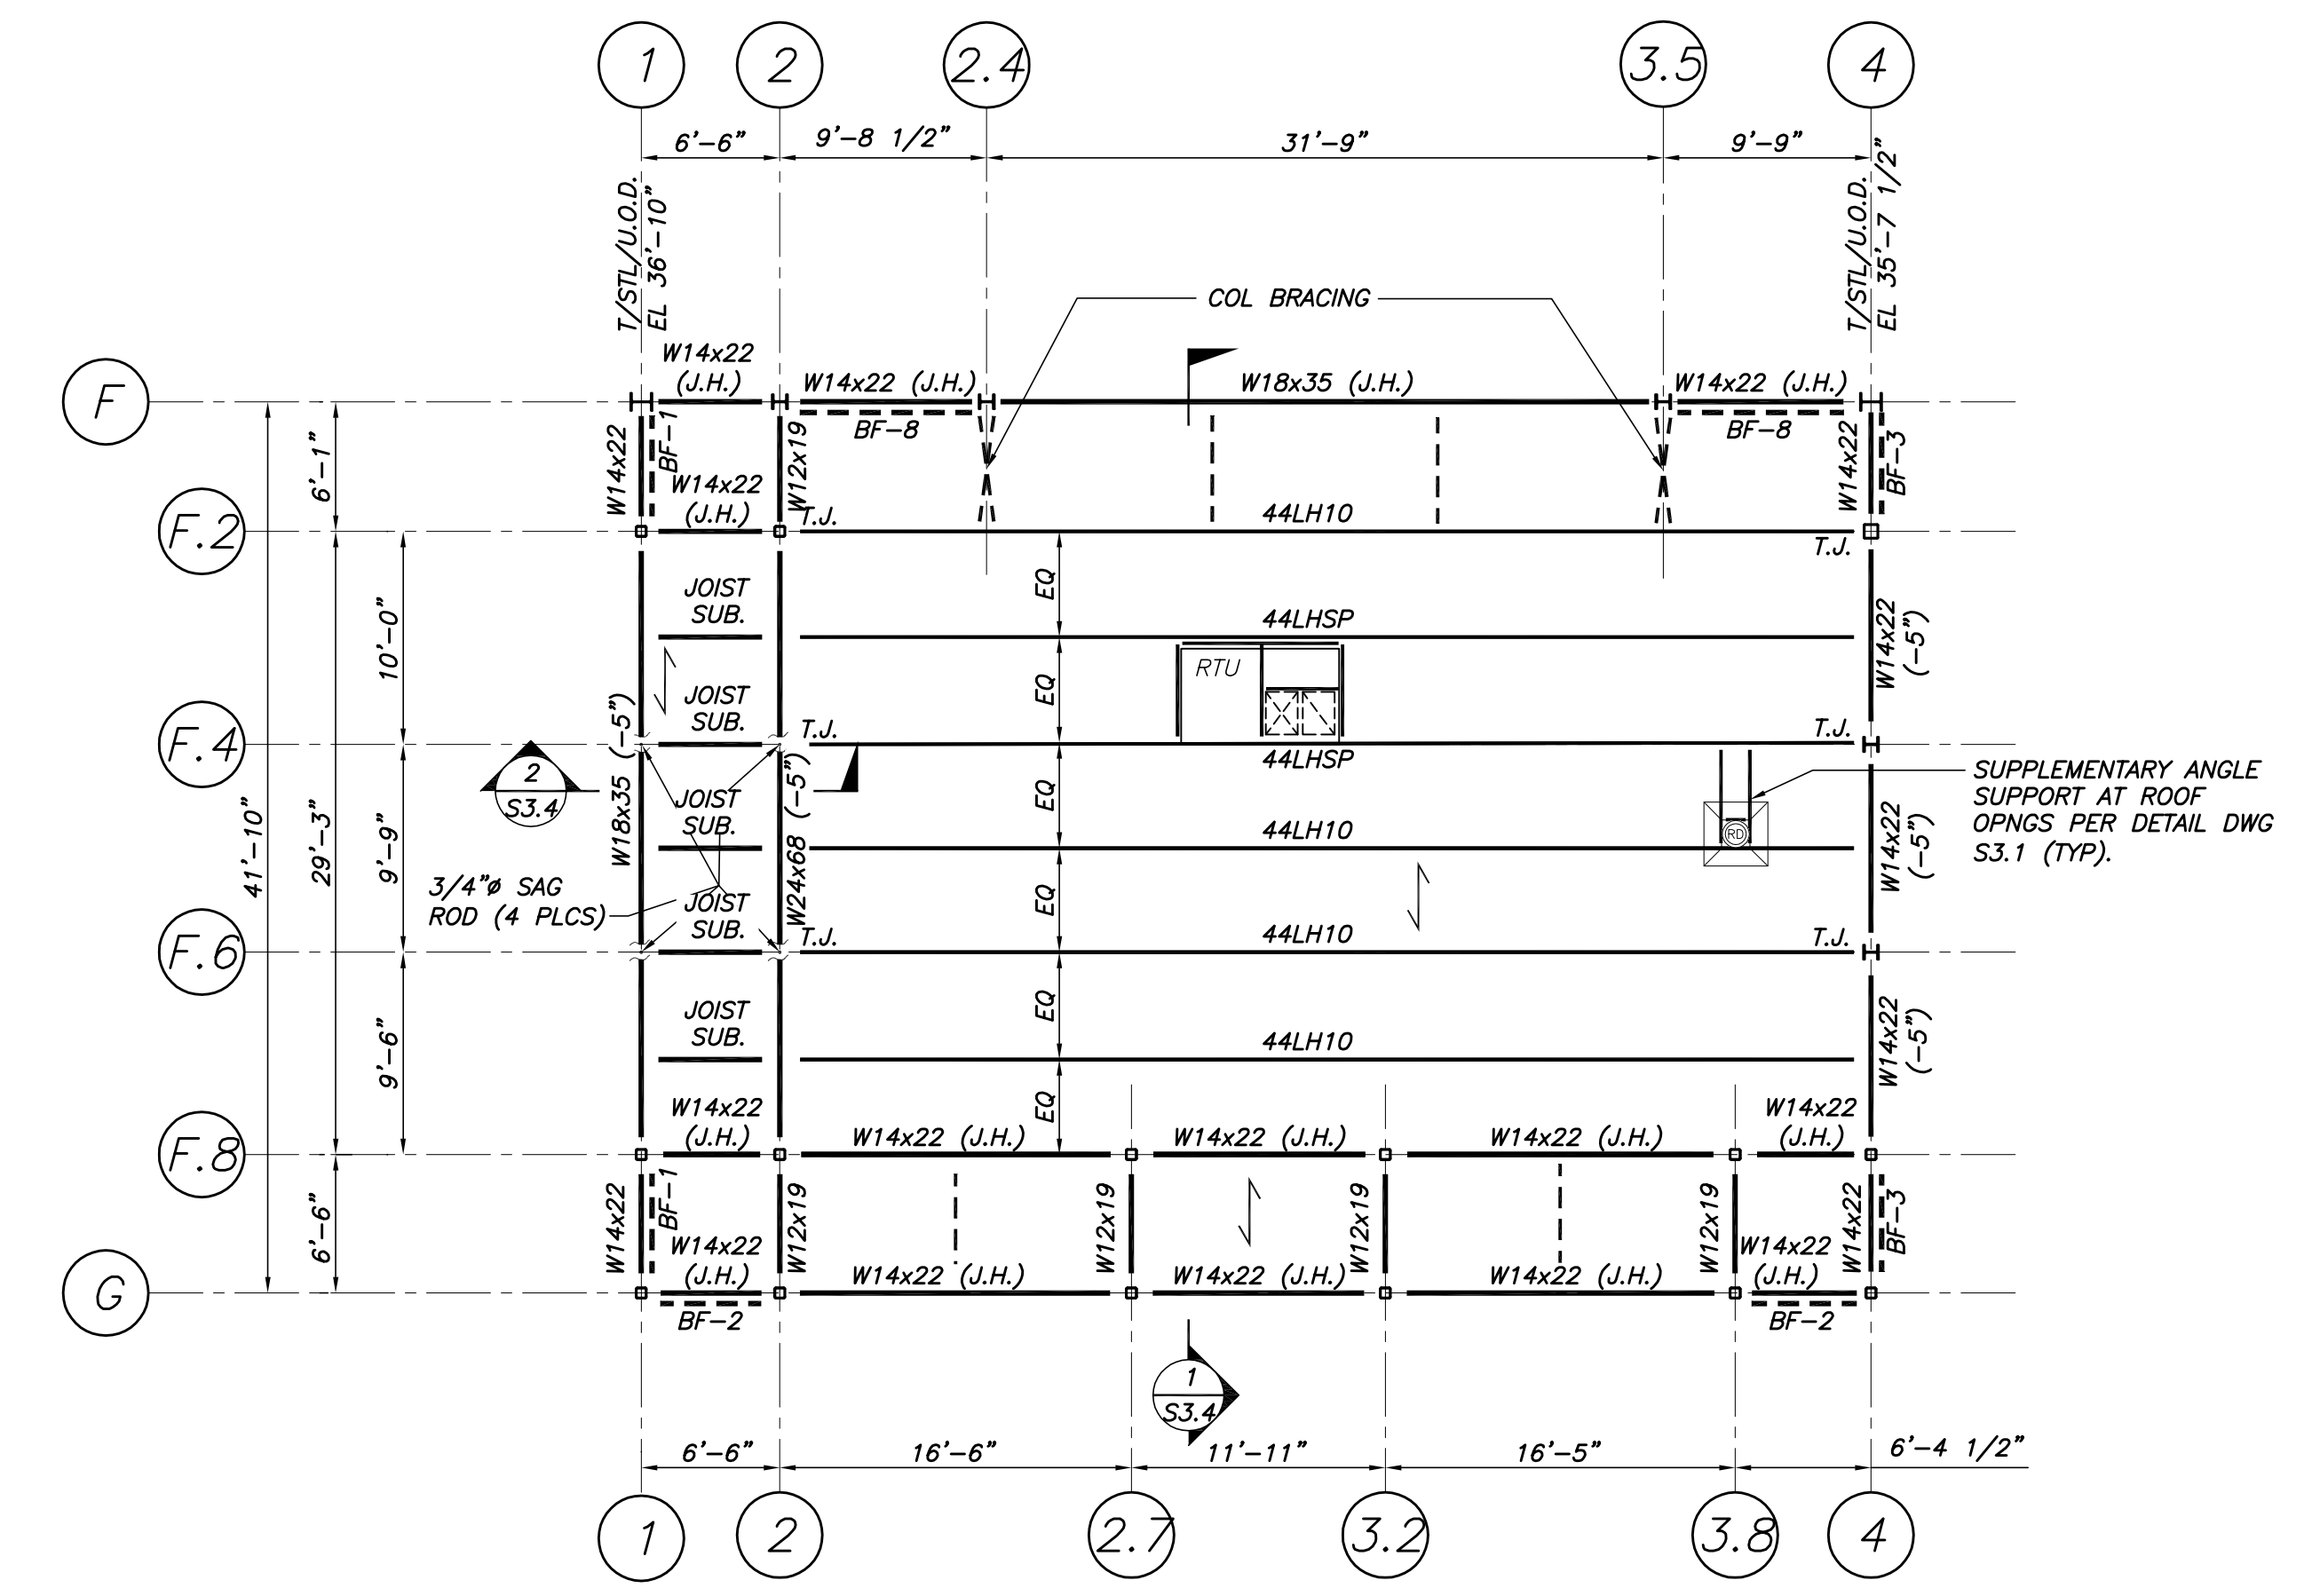

HIGH ROOF FRAMING PLAN

- 1/8"=1'-0"
- NOTES:
1. TOP OF STL/UNDERSIDE OF DECK EL 36'-10" REF FROM F.F. ELEV (0'-0") U.N.O. BY (+5"), (+2 1/2"), (-13") ETC. FROM TOP OF STL EL.
 2. JOIST BRIDGING REQUIRED PER STEEL JOIST INSTITUTE.
 3. --- INDICATES SPAN DIRECTION OF 1.5B20 GALV STL ROOF DECK (3 SPAN MINIMUM).
 4. J.H. INDICATES JOIST HEIGHT.
 5. T.J. INDICATES TIE JOIST.
 6. BF-X INDICATES BRACED FRAME ELEVATION. SEE BRACED FRAME ELEVATIONS DWG S1.3.
 7. --- INDICATES MOMENT CONNECTION. SEE TYP DETAILDWG S3.1.
 8. SP JOISTS TO BE DESIGNED BY AN ENGINEER LICENSED IN THE STATE OF MAINE PER THE LOADS INDICATED ON DWG S1.0 & AS INDICATED ON THIS PLAN. INCLUDE DEAD LOAD OF 15 PSF (DOWN), UPLIFT LOAD OF 30 PSF (UP) & 1,000 LBS POINT LOADS ANYWHERE ON SPAN OF ALL JOISTS SUPPORTING RTU'S.
 9. --- INDICATES STL ANGLE KICKER (SEE SECTIONS & DETAILS).