Form II P 04

## DISPLAY THIS CARD ON PRINCIPAL FRONTAGE OF WORK

**CITY OF PORTLAND** 

Please Read Application And Notes, If Any,

Permit Number: 041366

Autoried	L WELSTAIN I	
This is to certify thatrgina Way Propert	es Inica stefano siates	iffixed a live is the second
has permission to Commercial space w/ t	enant f	
AT 7.11 Marginal Wav		024 C001001
provided that the person or person the provisions of the Statutes the construction, maintenance at this department.	s of I ne and of the	epting this permit shall comply with a nces of the City of Portland regulatin tures, and of the application on file i
Apply to Public Works for street line and grade if nature of work requires such information.	N fication inspect in must go and with a permission procuble to this limit ding or to the the ding of the this limit ding of the this limit ding of the this limit ding of the	A certificate of occupancy must be
OTHER REQUIRED APPROVALS Fire Dept. Health Dept Appeal Board		M. S. J. L.
Other		Director - Building & Inspection Services
	ENALTY FOR REMOVING THIS	(.

City of Portland, Mai	ne - Building or Use	Permit Application	on   Perint No:	Issue Date:	CBL:
389 Congress Street, 041	01 Tel: (207) 874-870	3, <b>Fax:</b> (207) 874-87	716 04-1366		024 C001001
<b>Location of Construction:</b>	Owner Name:		Owner Address:		Phone:
211 Marginal Way	Marginal Way	Properties Inc	87 Sea Meadows L	∠n	781-237-3677
Business Name:	Contractor Name	2:	Contractor Address:		Phone
	Destefano and	Associates	2456 Lafayette Rd	Portsmouth	6037651638
Lessee/Buyer's Name	Phone:		Permit Type:		Zone:
			Alterations - Com	mercial	1 B 5
Past Use:	Proposed Use:		Permit Fee:	Cost of Work:	CEO District:
Commercial space			'		'
		Planet Dogret	DEPT:	A	PECTION:  Group 10 Type 5.1
Proposed Project Description:		0			•
Commercial space w/ tenar	of fit-up - Planet Day	rebut	Signature: 11)	My Sign	nature:
Space W tena.		). , ,	PEDESTRIAN ACTIV	TTIES DISTRIC	Γ (P.A.D.)
			Action: Approve	d Approved	w/Conditions Denied
			Signature:		Date:
Permit Taken By:	Date Applied For:		Zoning A	Approval	
dmm	09/1412004		8		
1. This permit application	does not preclude the	Special Zone or Revi	_l	Appeal	Historie Preservation
	ting applicable State and	Shoreland	evint S Variance		Not in District or Landma
<ol> <li>Building permits do not include plumbing, septic or electrical work.</li> <li>Building permits are void if work is not started within six (6) months of the date of issuance. False information may invalidate a building permit and stop all work</li> </ol>		Shoreland  Wetland  Flood Zone  New S	Miscelland	eous	Does Not Require Review
		Flood Zone	Condition	al Use	Requires Review
		Subdivision	Interpretat	ion	Approved
		Site Plan	Approved		Approved w/Conditions
		Maj Minor Mo	Denied		_ Denied
		late: 9 2	Date:		Date:
		,			
		CERTIFICAT	ION		
I hereby certify that I am the I have been authorized by the					

I hereby certify that I am the owner of record of the named property, or that the proposed work is authorized by the owner of record and that I have been authorized by the owner to make this application as his authorized agent and I agree to conform to all applicable laws of this jurisdiction. In addition, if a permit for work described in the application is issued, I certify that the code official's authorized representative shall have the authority to enter all areas covered by such permit at any reasonable hour to enforce the provision of the code(s) applicable to such permit.

SIGNATURE OF APPLICANT	ADDRESS	DATE	PHONE
RESPONSIBLE PERSON IN CHARGE OF WORK, TITLE		DATE	PHONE


City of Portland, Main	City of Portland, Maine - Building or Use Permit				CBL:
389 Congress Street, 0410	1 Tel: (207) 874-8703, <b>Fax:</b> (	207) 874-8710	6 04-1366	09/14/2004	024 C001001
Location of Construction:	Owner Name:		Owner Address:		Phone:
211 Marginal Way	Marginal Way Propert	ies Inc	87 Sea Meadows L	ın	781-237-3677
Business Name:	Contractor Name:		Contractor Address:		Phone
	Destefano and Associa	ites	2456 Lafayette Rd	Portsmouth	(603) 765-1638
Lessee/Buyer's Name	Phone:		Permit Type:		-
		_	Alterations - Com	mercial	
Proposed Use:		Propose	ed Project Description:		
Commercial space w/ tenant	fit-up	Comm	nercial space w/ tena	ant fit-up	
Dept: Zoning St	atus: Approved	Reviewer:	Marge Schmucka	1 Approval D	ate: 09/20/2004
Note:					Ok to Issue:
	atus: Approved	Reviewer:	Mike Nugent	Approval D	
	atus: Approved	Reviewer:	Mike Nugent	Approval D	
Dept: Building St	atus: Approved	Reviewer:	Mike Nugent	Approval D	ate: 10/12/2004
Dept: Building St Note:			Ü		ate: 10/12/2004 Ok to Issue: ☑
Dept: Building St Note:  Dept: Fire St	atus: Approved with Conditions		Mike Nugent  Lt. MacDougal	Approval D	ate: 10/12/2004 Ok to Issue: ✓ ate: 09/23/2004
Dept: Building St Note:	atus: Approved with Conditions		Ü		ate: 10/12/2004 Ok to Issue: ☑
Dept: Building St Note:  Dept: Fire St Note: reviewed under wron	atus: Approved with Conditions	s Reviewer:	Lt. MacDougal		ate: 10/12/2004 Ok to Issue: ✓ ate: 09/23/2004
Dept: Building St Note:  Dept: Fire St Note: reviewed under wron 1) code review for the struct	atus: Approved with Conditions	<b>Reviewer:</b> of the life safety	Lt. MacDougal		ate: 10/12/2004 Ok to Issue: ✓ ate: 09/23/2004

#### **Comments:**

9/24/2004-mjn: Need structurals for mezzanine extensions and guards, have egress questions......Left message with Owner, Architect and Builder





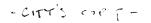

#### PLANET DOG 211 Marginal way PORTLAND, ME 04101

#### STRUCTURAL CALCULATIONS

OF

# MEZZANINE RENOVATIONS & NEW ENTRY


DATE: 10/8/2004

TOTAL SHEETS: 19

PERMITING SUBMISSION

PREPARED BY:

AV ENGINEEERING, LLC CUSTOM DESIGN & ENGINEERING POB 1254, WELLS, ME 04090

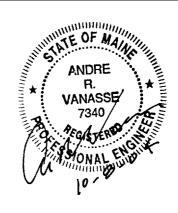

## PLANET DOG

## 211 MARGINAL WAY PORTLAND, ME 04101

#### **DESIGN LOADS**

#### I. LIVE LOADS:

ROOF SNOW LOADS: N/A (TENENT FITUP OF EXSITING STRUCTURE)

BASIC GROUND SNOW LOAD: PG= PSF

SNOW EXPOSURE FACTOR: CE= SNOW LOAD INPORTANCE FACTOR: IS= ROOF THERMAL FACTOR: CT=

FLOOR LOADS: (ASCE 7/02 & IBC 2000)

FIRST FLOOR: = 100 PSF (RETAIL)

CORRIDORS: = 100 PSF

**MEZZANINE:** 

OFFICES: 50 PSF CORRIDORS: 80 PSF

OTHER LOADS:

STAIRS: 100 PSF

RAILING: 50 PLF AND 200 # ANY LOCATION

ANY DIRECTION

INTERNAL PARTITIONS: 5 PSF MINIMUM

2. WIND LOADING: (ASCE 7/02)

BASIC WIND SPEED: V=100 MPH


WIND LOAD IMPORTANCE FACTOR: I=I.0 (CATEGORY 2-

NOTE: CAT I IBC 2000)

EXPOSURE: B

### PLANET DOG 211 MARGINAL WAY PORTLAND, ME 04101

## **MEZZANINE**

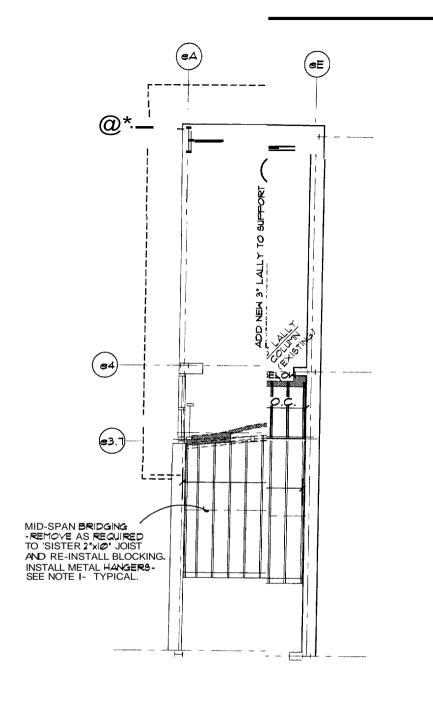

MEZZANINE FRAMING

251- 0820

(100)

Services

Engineering

ģ

Custom Desi

AV Engineering,

211 Marginal Way Portland, ME 04090

NOTE:

I. INSTALL METAL FACE MOUNT HANGERS AT ALL JOIST (SINGLE & DC

- 2. INSTALL 3" DIA. STEEL LALLY COLUMNS W/6"x.6"x.375" BASE 4 TO! (4) 7/6" DIA. HOLES FOR 3/8" DIA. ANCHORO. FIELD MEASURE Ed
- 3. REINFORCE MEZZANINE HALLS AND CONSTRUCT EXTENSIONS PER I BY ENGINEER.
- 4. ADD (3) 12 x 3" WOOD SCREWS EMRY 30" STAGGERED SOTH SIDE (3-2"x|2") AND AS DIRECTED BY ENGINEER.
- 5. ALL PLYWOOD DECKING TO BE APA RATED 3/4" THICK ADVANTEX., STATE, LOCAL CODES AND ORDINANCES.

  NEW PLYWOOD DECKING TO BE GLUED AND SCREWED PER CODE INSIGNS AND MORE SHOWN ON THESE PLANS
  EXISTING DECKING TO INSPECTED FOR CODE FASTENING AND ADDITION REFORE ANY CONSTRUCTIONS, ADDED TO NEH JOIST.

  BE THE DESIGNER WILL NOT BE RESPONSIBLE SANDING OR ORDINANCES AND/OR REVISIONS MADE

  SOPRAMINGS BY CLIENT/CONTRACTOR.

ED.

9-16-04 REVISED

9-21-04 9-29-04 10-08-04

Andre Vanasse, AV Engineering, LLC10/8/10/04 8:51 AMPIA

A.V. Engineering, LLC P.O. BOX 1254 Wells, Maine 04090

Planet Dog Job No:

SHEET: OF 9/16/2004

BY: ARV CHK BY:

MEMBER NUMBER:

UNIFORMLY LOADED [REF# - Page]

SIMPLE SPAN

EXILTING WIRDER.

[# \_ 1

LIVE LOAD= 62.00 PSF DEAD LOAD= 15.00 PSF

**DESIGN FORCES:** 

10.0 FT MEMB SPAC= 72.00 IN

MAX B.M.: 5775 FT-LBS **LBS** MAX V@ SUPPOF 2310

V@ DIST "d" :

LBS

**DEFLECTION LIMITATIONS:** 

MEMB SPAN=

[# - ]

LIVE LOADING: 360 (180 240 360 420 480) DEAD + LIVE LDNG 240 (120 180 240 300 360)

> K = 0.50(IF MC<16% USE .5; IF MC>16% USE 1.0)

SPAN LENGTH, L: 120.0 IN (USE CS PLUS 1/2 BL @ EACH SUPPORT)

SELECT SIZE CLASSIFICATION & SPECIES:

(ASSUME CI=1)

ASSUMED MEMBER SIZE:

SPECIES:S-P-F ACT. MEMB THICKNE: 4.5 GRADE: NO. 2 ACT. MEMBER WIDTH 11.25 TAB Fb= 875 PSI Cd= 1.00 [#3-6] TAB Ft= 425 PSI Cm= 1.00 [#4-18] TAB Fv= 70 PSI ct= 1.00 [#3-6] TAB Fcp= 425 PSI CI= 1.00 [#3-6] TAB Fc= 1100 PSI Fb CF= 1.00 [#4-18] TAB E= 1.40 X 10<sup>6</sup> P: Ft CF= 1.00 [#4-18] TAB Fg= 1410 PSI Fc CF= 1.00 [#4-18] cv= 1.00 [GLULAM ONLY] F'b= 875 PSI Cfu= 1.00 [#4-18] F't= 425 PSI Cr= 1.00 [#4-18] 1100 PSI F'c= cc= 1.00 [GLULAM ONLY] F'cp= 425 PSI Cf= 1.00 [#3-6] F'v= 70 PSI cp= 1.00 [#3-14] F'q= 1410 PSI Ch= 1.00 [#4-19] E'= 1.4 X 10<sup>6</sup> P: Ct= 1.00 [#3-20]

Cb=

1.00

MIN. MEMBER REQUIREMENTS:

34.4

179

REQ'D Sx= 79.2 IN^3 <= 94.92 IN<sup>3</sup> O.K. REQ'D |x=179.36 |N^4 <= 533.94 IN<sup>4</sup> O.K. REQ'D A= 49.5 iN^2 <= 50.63 IN^2 O.K. REQ'D BEARING=1.2078 IN <= 1.5 IN USE:

CHECK Cd:

CHECK CF:

IS ADEQUATE \*\*\*\*\*

NOTE: MEMBER MUST HAVE COMPRESSION FLANGE LATERIAL BRACED

LOADING => MALL ADDITIONAL INTERMOTIATE MOLEATOL SUPPORT ESTORME

a.Aus.

[#3-7]

1.5

A.V. Engineering, LLC Job No: Planet Dog P.O. BOX 1254 SHEET: OF Wells, Maine 04090 BY: ARV 9/16/2004 CHK BY: MEMBER NUMBER: UNIFORMLY LOADED [REF# - Page] SIMPLE SPAN . ENSTING 5015T-LIVE LOAD= 50.00 PSF DEAD LOAD= 15.00 PSF [# - ] **DESIGN FORCES:** MEMBSPAC= 16.00 IN MEMB SPAN= 11.9 FT FT-LBS MAX B.M.: 1534 MAX V@ SUPPOF LBS 516 V@ DIST "d": **LBS** [# - ] **DEFLECTION LIMITATIONS:** LIVE LOADING: 360 (180 240 360 420 480) DEAD + LIVE LDNG 240 (120 180 240 300 360) K= 0.50 (IFMC<16% USE.5; IFMC>16% USE 1.0) SPAN LENGTH, L: 142.8 IN (USE CS PLUS 1/2 BL @ EACH SUPPORT) SELECT SIZE CLASSIFICATION& SPECIES: (ASSUME CI=1) ASSUMED MEMBER SIZE: SPECIES:S-P-F ACT. MEMB THICKNE: 1.5 GRADE: NO. 2 ACT. MEMBER WIDTH 9.25 TAB Fb= 875 PSI Cd= 1.00 [#3-6] TAB Ft= 425 PSI Cm= 1.00 [#4-18] TAB Fv= 70 PSI Ct= [#3-6] 1.00 TAB Fcp= 425 PSI CI= 1.00 [#3-6] TABFc= 1100 PSI Fb CF= 1.00 [#4-18] TAB E= 1.40 X 10% P: Ft CF= 1.00 [#4-18] TAB Fg= 1410 PSI Fc CF= 1.00 [#4-18] cv= 1.00 [GLULAM ONLY] F'b= 1006 PSI Cfu= [#4-18] 1.00 F't= 425 PSI Cr= [#4-18] 1.15 F'c= 1100 PSI cc= 1.00 [GLULAM ONLY] F'cp= 425 PSI Cf= [#3-6] 1.00 F'v= 70 PSI 1.00 cp= [#3-14] 32.5 F'g= 1410 PSI Ch= 1.00 [#4-19] E'= 1.4 X 10<sup>6</sup> P: 54.2 Ct= 1.00 [#3-20] Cb= 1.00 [#3-7] MIN. MEMBER REQUIREMENTS: REQ'D Sx= 18.295 IN^3 <= 21.39 IN<sup>3</sup> O.K. REQ'D Ix=54.166 IN^4 <= 98.93 IN<sup>4</sup> O.K. REQ'D A= 11.05 IN^2 <= 13.88 IN<sup>2</sup> O.K. REQ'D BEARING= 0.8089 IN <= 1.5 IN USE: 1.5 CHECK Cd: **CHECK CF:** 

\*\*\*\*\*\* IS ADEQUATE \*\*\*\*\*\*

NOTE: MEMBER MUST HAVE COMPRESSION FLANGE LATERIAL BRACED.


NOTE:

EXILTING TOIST O.K. W/O PROPOSED

PARTITIONS - MIET "SISTER" EXISTING
TOIST OR PROVINE INTERMEDIATE SUPPORT
WALLS AS NOTED IN PLANS FOR

#### NOTICE:

1.) ALL CONSTRUCTION TO CONFORM TO ALL APPLICATE NATIONAL, STATE, LOCAL CODES AND ORDINANCES 2.) ALL DIMENSIONS AND WORK SHOWN ON THESE PLAY AND ANY APPLICABLE SPECIFICATIONS PLIES BY CLIENTICONTRACTOR BEFORE ANY CONSTRUCTIC OTHERWISE THE DESIGNER WILL NOT BE RESPONSIBLE FOR ANY ERRORS OR ORTHSHOLD. THE DESIGNER AS NO RESPONSIBILITY FOR CHANGES AND/OR REVISION TO PLANS/DRAWNIGS BY CLIENT/CONTRACTOR.

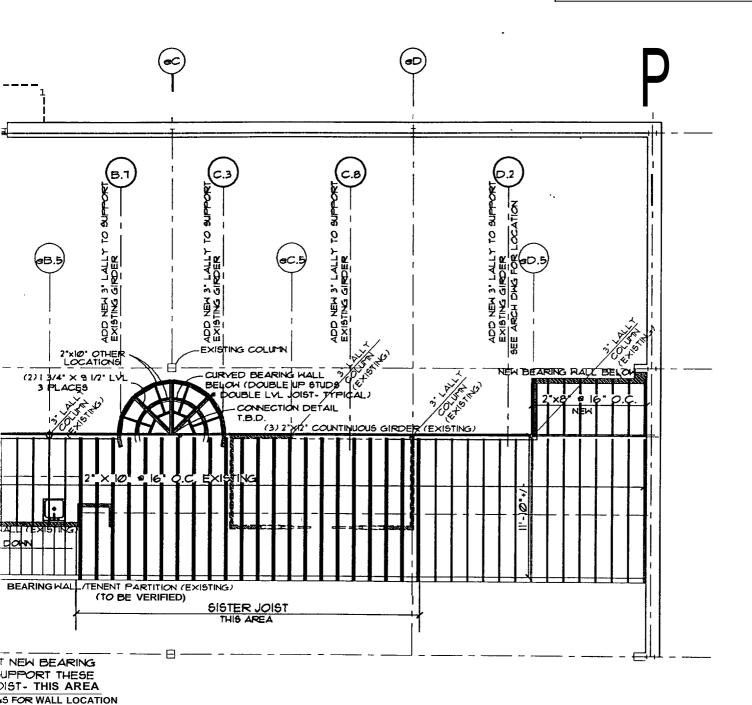

ANINE FRAMING PLAN

SCALE 1/8" = 1'-0"

A.V. fngincering, LLC PO Box 1254 Wells, ME 04090

HALF CIRCLE MEZZANINE EXTENSION	
P. A. S.	4(150)=600#+1-
PLAN VIEW  W=315*1	WALL HEIGHT < 10 W= 10'X 15 1 1= 195 /LF. T.W. 2 4'
(2) 13/4" × 9"/2" LYL SOLID BLOCKING	LL= 30 PSF DL=20 PSF TL=70 PSF T.A≈ 4.5 SF W= 4.5(70)
-300 TOUBLE    DOUBLE   18"+1-	= 315# 1

SCALE: NOME

SECTION @ RADIUSED DECK

108 PLANET DOG


A.V. Engineering, LLC PO Box 1254 Wells, ME 04090 SCALE

## DETERMINE IF LYL'S ARE ADEQUATE TO CAMPY LOAY:

#### DETERMINE REACTION & A:

( = MB=0

600(54) + 315(26) = 36R1

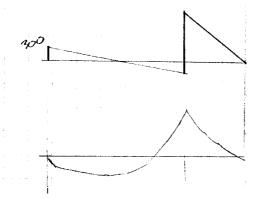

Rz: 315+600 -1215 =-300#1

$$M_{\text{max}} = 18(600^{\text{#}}) + 315(10^{\text{#}})$$

$$= 13,900^{\text{#}} - 12$$

$$= 1163^{1-\text{II}} < 13,863^{\text{*}}$$

BY INSPECTION 31/2 × 91/2" LVL ADEQUATE AS LATED OUT IN CAD DWG S-Z

JOE PLANET DOG

A.V. Engineering, LLC PO Box 1254 Wells, ME 04090

	SCALE
2/2×4/2 Lx.	GSWILD DOUBLE STUDS AT ALL LYL LOCATIONS - TYPICAL
	and the state of t
Source 20 2 2 2 2 2 2 2 2 2 2 2 2 2 2 2 2 2 2	(2) 1/2" \$ THREAMEN ROWS BEVEL WASHENS NUTS
HHUS410 SIMPSON HANGER	ANCHOR COLUMN TO EXISTING B/V GIRDER of ANCHOR COLUMN TO SLAB TO PUBLIST 1,200* UPLIFT FOLLE

PLAN VIEW

MOTE: 2×10" NOT SITOWN


FOR CLANITY - SEE

STINUTURAL SIT S-2


FOR INFORMATION NOT SITOWN

## PLANET DOG 211 MARGINAL WAY PORTLAND, ME 04101

## ENTRY RENOVATIONS

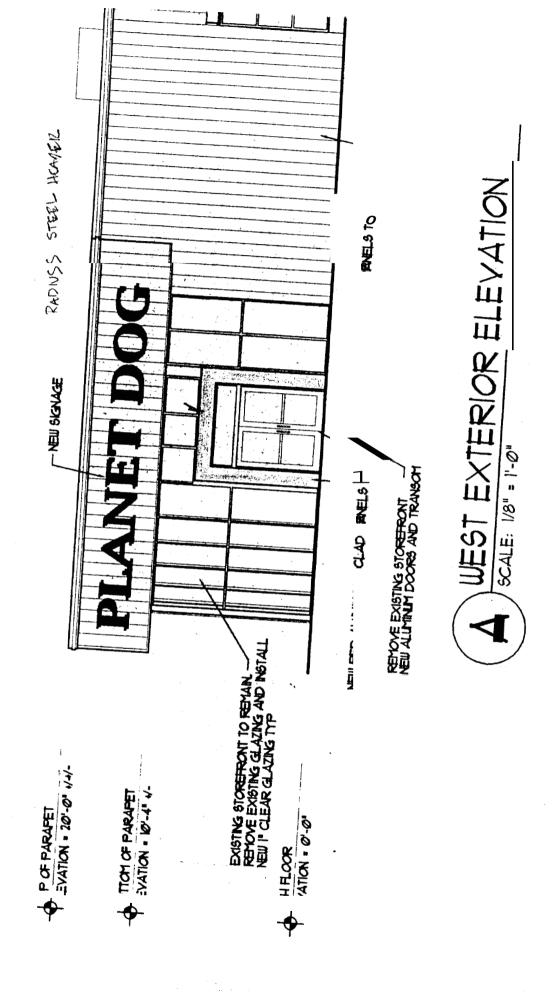

ت. ٠٠٠

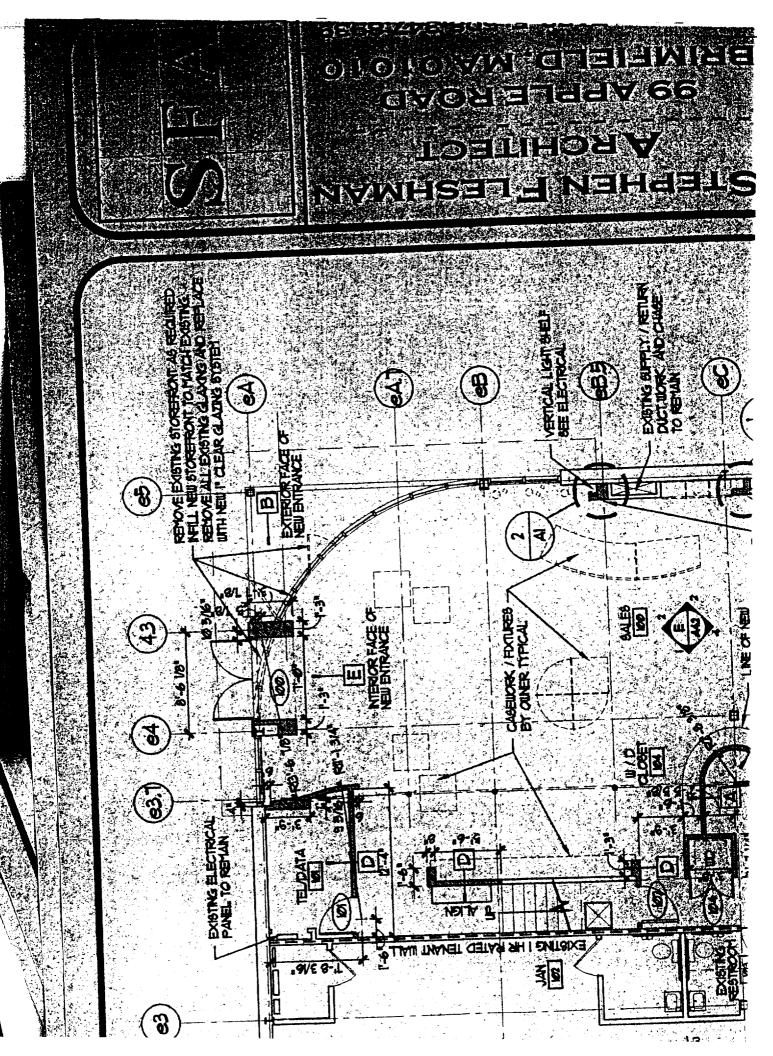

A.V. fngincering, LLC PO Box 1254 Wells, ME 04090

JOB_FLANET_DOG	
SHEET NO	- OF
CALCULATEDBYAV	- DATE 9-27
CHECKED BY	- DATE

#### DETERMINE LOMING ON NOW MOMENT FRAME;

APPROX. HEIGHT OF FRAME: 29-6"
APPROX. POINT LOM C TOP OF FRAME:
WIRDLA LOM ALONG FRAME:
CONCENTRATES LOND

**SCALE** 

3 x 5 x (-20,3) = 3 x + 914 = 1219 = 7 1300 F ESTIMATE LOADS E

-914

IBC 2000 TABLE 1609.6.2.1(1) BIMS: 100 MPH = 1/3

EFFECTIVE WIM AND 2 50 SF

20HE 5

16.1 PSF

-20.3 BF

I=1,0

HT ADJUSTMENT FROM 1.0

(16.1)(4.5) = 72.45 PLF (-20.3)(4.5) = - 91.35 PLF

 $M_A = 914(5') + 305(10') = 7620^{\frac{1}{2}}$ MOMENT COUPLE =  $\frac{7620}{2.5} = 3048^{\frac{1}{2}}$ 

JOB PLANET DOG

A.V. Engineering, LLC PO Box 1254 Wells, ME 04090

SHEET NO	OF
CALCULATED BY	DATE 9-27
CHECKED BY	DATE

SCAL


#### DETERMINE LOMING ON NEW MOMENT FRAME;

APPROX. HEIGHT OF FRAME: 29-6"

APPROX. POINT HOM @ TOP OF FRAME: 21300 #

WIRDLIN LOM ALONG FRAME: -92 PLF, 73 PLF

CONCENTRATED LOAD & 1300 # AT EXISTING COLUMN

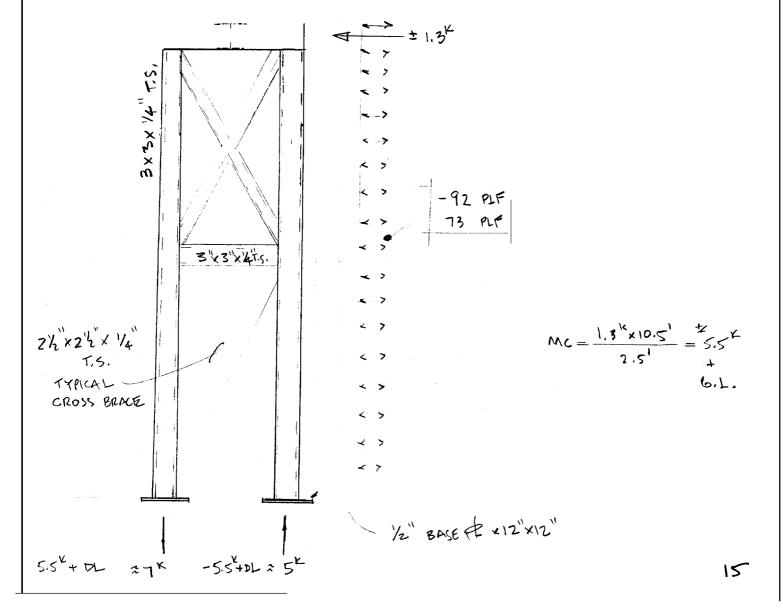

A.V. fngineering, LLC PO Box 1254 Wells, ME 04090

1	SCALE	
e e	FIELD ATTACH IND BEAM : 1/4 PL (4.3) TO EXISTANG COLUMN & NEW MOMENT FRAME  SHOP FABRICATE  WEX W/ 1/4" PL WELDEN TO	
	TOP FLANGE	
	MOMENT	
	FRAME -	_
	SHOP DRAWING	<i>,</i> S
EXISTIML	PEQUIRÉD 655 CV 2	
W	SEE SK-2 SK-3	
COLUMN		
REIMFORCE		
WITH 3/B"THICK		
PLATES BOTH		
FLANGES-	70	
FIELD WELDING		
Rean-sat		
T.B.V.		
· · · · · · · · · · · · · · · · · · ·		
1 · · · · · · · · · · · · · · · · · · ·		ı
	#5 e 12" V 1-3" W X 3-8"	•
	#5@12"H EACH SIDE FON WALL	
	TO FROST	
	DEPTH	
	PARTIAL ELEVATION AT	
	STORE ENTRY	

A.V. Engineering, LLC PO Box 1254 Wells, ME 04090 JOB PLANET DOG

SHEET NO. SK-3 OF DATE 9-27

CHECKED BY DATE DATE

SCALE NONE

		WOX T.B.D.  W/3/8" RX T.B.D.  (NO TO BE FIELD BOLTEM,  PL TD BE FIELD WELDEM)	SHOP WELDED SHEAR TAB (1/2) A
NOTE: O SHOP FARMICATE ENTIRE MOMENT FRAME			MOMMENT FRAME
NOTE: O SHOP FARMICATE ENTIRE MOMENT FRAME		WBX	
NOTE: O SHOP FARAMENT FRAME  ENTIRE MOMENT FRAME			£ 7.5
NOTE: O SHOP FARAMENT FRAME  ENTIRE MOMENT FRAME		15. The state of t	
ENTIRE MOMENT FRAME		X X	
ENTIRE MOMENT FRAME			
ENTIRE MOMENT FRAME	NOTE: SHOP FARMIC	ATE A VILLE OF THE STATE OF THE	
	ENTIRE MOME	WT FRAME	

N.T.S.

PLANET DOG SK-Z A.V. Engineering, LLC SHEET NO CALCULATED BY\_\_\_\_ PO Box 1254 9-27 Wells, NE 04090 1/4"×4"×10" # TUBE STEEL = SO KSI CONCILCTE = 3,500 PSI SHOP INELDING OHLY FIELD BOLTED CONNECTIONS USING A307 THREADEN RUD A325 BOLTS 3/16 ½"×12"×12" A307 THREAMET #5@12"V ROD - B PLACES 450 12" H 3-8" (PER ARCH) PARTIAL DETAIL 2"x2"x1/4" FLAT PE AT MOMEUT FRAME \$ 2 MUTS - TTACAL

EACH ROD

18

### PLANET DOG 211 MARGINAL WAY PORTLAND, ME 04101

## **MISCELLANUOUS**

99 APPLE ROAD BRIMFIELD, MA 01010 PHONE: 508.347.7188 FAX: 508.347.8939 Fleshman@SF-Arch.com

#### STEPHEN FLESHMAN ARCHITECT



To: Mr. Mike Nugent From: Stephen Fleshman, AIA

Chief of Inspection - Portland, ME Stephen Fleshman Architect

Fax: 207.874.8716 Date: 10.11.04

Phone: 207.874.8700 Pages: 1

Re: Planet Dog - 211 Marginal Way CC: John DeStefano

☑ Urgent ☐ For Review ☐ Please Comment ☐ Please Reply ☑ Your Us

As requested, during our conversation on Friday October 8th, please find the information regarding the building classification for the Planet Dog project at 211 Marginal Way.

Existing building use - Mercantile

Square Footage - 3 existing tenant spaces totaling 7100 sq ft

The *UPS* Store - 2100 sq A approx. Simply Formal - 1900 sq ft approx.

Planet Dog - 3100 sq ft

Construction type - typical of type 2C with the exception of an existing wood framed mezzanine in the Planet Dog tenant space. Since the mezzanine exists the construction type needs to be classified as SB

Allowable area under 5B Mercantile = 4800 sq ft
Area modification = Street Frontage 75% exposed

75% - 25% = 50%

50%x2=%100 increase / 4800

Total allowable area -4800 + 4800 = 9600 sq ft

Based upon the above information the existing building will comply with the area requirements even under the lower construction classification 5B.

I hope the above information addresses your questions regarding the construction classification of the project. If you have any further questions please feel free to contact me.

99 APPLE ROAD BRIMFIELD, MA 01010 PHONE: 508.347.7188 FAX: 508.347.8939 Fleshman@SF-Arch.com

#### STEPHEN FLESHMAN ARCHITECT



To:	John DeStefano		From;	Stephen Fleshman, Al	A
	DeStefano Associates, Inc			Stephen Fleshman Arc	chitect
Fax:	603,430,0346		Date:	09.24.04	
Phone:	603.430 0339		Pages:	1	
Re:	Planet Dog				
Urgent	☐ For Review	☐ Please Com	ment	☐ Plææ Reply	☑ Your Use

John,

I have contacted Backer Structural Engineers of Portland, ME — the structural engineer of record for the renovations to 211 Marginal Way in January of 2003. The roof structure was modified to receive 3 new roof top units. Two of which were install over the tenant spaces that are currently occupied. The third unit was for the tenant space which Planet Dog will occupy. Dan Burn from Becker advised me that the steel design was based upon a 700 lb roof top unit. I have since contacted Kathy Mooney from Portland Air and she advised me that the unit that will be installed on the roof will be approximately 360 lbs. This unit will only serve the mezzanine level and is much smaller than a unit that would serve the entire space as the original steel modifications design was based upon

I hope this provides the information that you need If you have any further questions please feel free to contact me

Regards

Stephen Fleshman, AIA

## PLANET DOG

211 MARGINAL WAY PORTLAND, ME 04101

#### STRUCTURAL CALCULATIONS

**OF** 

#### MEZZANINE UPGRADES NEW ENTRY

#### PROGRESS SET

DATE: 9-30-04

TOTAL SHEETS:

PREPARED BY:

AV ENGINEERING, LLC CUSTOM DESIGN & ENGINEERING POB 1254, WELLS, ME 04090

## PLANET DOG

## 211 MARGINAL WAY PORTLAND, ME 04101

#### DESIGN LOADS

#### I. LIVE LOADS:

ROOF SNOW LOADS: N/A (TENENT FITUP OF EXSITING STRUCTURE)

BASIC GROUND SNOW LOAD: PG= PSF

SNOW EXPOSURE FACTOR: CE= SNOW LOAD INPORTANCE FACTOR: IS=

ROOF THERMAL FACTOR: CT=

FLOOR LOADS: (ASCE 7/02 & IBC 2000)

FIRST FLOOR: = 100 PSF (RETAIL)

CORRIDORS: - 100 PSF

**MEZZANINE**:

OFFICES: 50 PSF CORRIDORS: 80 PSF

OTHER LOADS:

STAIRS: 100 PSF

RAILING: 50 PLF AND 200 # ANY LOCATION

ANY DIRECTION

INTERNAL PARTITIONS: 5 PSF MINIMUM

2. WIND LOADING: (ASCE 7/02)

BASIC WIND SPEED: V=100 MPH


WIND LOAD IMPORTANCE FACTOR: I=1.0 (CATEGORY 2-

NOTE: CAT I IBC 2000)

EXPOSURE: B

## PLANET DOG 211 MARGINAL WAY PORTLAND, ME 04101

**MEZZANINE** 

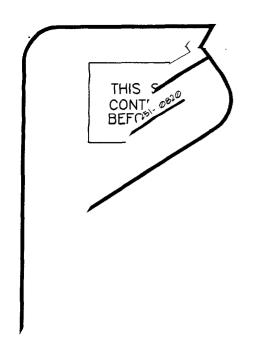

A.V. Engineering, LLC Job No: Planet Dog P.O. BOX 1254 SHEET: OF Wells, Maine 04090 9/16/2004 BY: ARV CHK BY: MEMBER NUMBER: **UNIFORMLY LOADED** [REF # - Page] SIMPLE SPAN · EXILTING GIRDER. LIVE LOAD= 62.00 PSF DEAD LOAD= 15.00 PSF **DESIGN FORCES:** [# - ] MEMB SPAC= MEMB SPAN= 10.0 FT 72.00 IN MAX B.M.: FT-LBS 5775 MAX V@ SUPPOF 2310 **LBS LBS** V@ DIST " d : **[# - 1 DEFLECTION LIMITATIONS:** LIVE LOADING: 360 (180 240 360 420 480) DEAD + LIVE LDNG K = 0.50(IF MC<16% USE .5; IF MC>16% USE 1.0> SPAN LENGTH, L: 120.0 IN (USE CS PLUS 1/2 BL @ EACH SUPPORT) SELECT SIZE CLASSIFICATION & SPECIES: (ASSUME CI=1) ASSUMED MEMBER SIZE: SPECIES: S-P-F ACT. MEMB THICKNE: 4.5 GRADE: NO. 2 ACT. MEMBER WIDTH 11.25 TAB Fb= 875 PSI Cd= 1.00 [#3-6] TAB Ft= 425 PSI Cm= 1.00 [#4-18] TAB Fv= 70 PSI 1.00 [#3-6] ct= TAB Fcp= 425 PSI CI= 1.00 [#3-6] TAB Fc= 1100 PSI Fb CF= 1.00 [#4-18] TAB **E**≖ 1.40 X 10% P Ft CF= 1.00 [#4-18] TAB Fq= 1410 PSI Fc CF= 1.00 [#4-18] cv= 1.00 [GLULAM ONLY] F'b= 875 PSI Cfu= 1.00 [#4-18] F't= 425 PSI Cr= 1.00 [#4-18] F'c= 1100 PSI cc= 1.00 [GLULAM ONLY] F'cp= 425 PSI Cf= 1.00 [#3-6] F'v= 70 PSI cp= 1.00 [#3-14] 1410 PSI 34.4 F'g= Ch= 1.00 [#4-19] 179 1.4 X 10<sup>6</sup> P: E'= Ct= 1.00 [#3-20] Cb= 1.00 [#3-7] MIN. MEMBER REQUIREMENTS: REQ'D Sx= 79.2 IN^3 <= 94.92 IN^3 O.K. REQ'D |x= 179.36 |N^4 <= 533.94 IN^4 O.K. REQ'D A= 49.5 IN^2 <= 50.63 IN<sup>2</sup> O.K. REQ'D BEARING=1.2078 IN <= 1.5 IN USE: 1.5

CHECK Cd: CHECK CF:

\*\*\*\*\*\* IS ADEQUATE \*\*\*\*\*\*

NOTE: MEMBER MUST HAVE COMPRESSION FLANGE LATERIAL BRACED.

MEED TO PROVIDE INTERMENTATE
SUPPORT COLOURS AS INDICATE
IN PLANTS.

A.V. Engineering, LLC P.O. BOX 1254 Wells, Maine 04090	Job No: Planet Dog SHEET: OF BY: ARV 9/16/2004 CHK BY:
	JNIFORMLY LOADED [REF# • Page]
LIVE LOAD= 50.00 PSF DEAD LOAD= 15.00 PSF	SIMPLE SPAN - ENSTING SOUT-
DESIGN FORCES:  MEMB SPAN= 11.9 FT ME  MAX B.M.: 1534 FT-LBS  MAX V@ SUPPOF 516 LBS  V@ DIST "d" : LBS	
DEFLECTION LIMITATIONS:	[# - ]
	180 240 360 420 480) 120 180 240 300 360)
K= 0.50 (	IF MC<16% USE .5; IF MC>16% USE 1.0)
SPAN LENGTH, L: 142.8 IN (	USE CS PLUS 1/2 BL@ EACH SUPPORT)
SELECT SIZE CLASSIFICATION & SPEC	IES: (ASSUME CI=1) ASSUMED MEMBER SIZE:
SPECIES: S-P-F A	ACT. MEMB THICKNE: 1.5 ACT. MEMBER WIDTH 9.25
TAB Fb= 875 PSI  TAB Ft= 425 PSI  TAB Fc= 70 PSI  TAB Fc= 425 PSI  TAB Fc= 1100 PSI  TAB E= 1.40 X 10^6 P:  TAB Fg= 1410 PSI  F'b= 1006 PSI  Ft= 425 PSI  F'c= 1100 PSI  F'c= 1100 PSI  F'c= 425 PSI  F'c= 140 PSI  Signature 1410 PSI  F'y= 70 PSI  Signature 1410 PSI  E'= 1.4 X 10^6 P:  MIN. MEMBER REQUIREMENTS:  REQ'D Sx= 18.295 IN^3 <=  REQ'D Ix= 54.166 IN^4 <=  REQ'D A= 11.05 IN^2 <=  REQ'D BEARING= 0.8089 IN <=	Cd= 1.00 [#3-6]  Cm= 1.00 [#4-18]  Ct= 1.00 [#3-6]  Cl= 1.00 [#3-6]  Fb CF= 1.00 [#4-18]  Ft CF= 1.00 [#4-18]  Fc CF= 1.00 [#4-18]  cv= 1.00 [GLULAM ONLY]  Cfu= 1.00 [#4-18]  cc= 1.00 [GLULAM ONLY]  Cf= 1.15 [#4-18]  cc= 1.00 [GLULAM ONLY]  Cf= 1.00 [#3-6]  cp= 1.00 [#3-14]  Ch= 1.00 [#3-14]  Ch= 1.00 [#3-20]  Cb= 1.00 [#3-7]  21.39 IN^3 O.K.  98.93 IN^4 O.K.  13.88 IN^2 O.K.  1.5 IN USE: 1.5
CHECK Cd: CHECK CF:  ******* IS ADEQUA	ΔTF ******
IS ADEQU	

NOTE: MEMBER MUST HAVE COMPRESSION FLANGE LATERIAL BRACED.

NOTE: EYLTING JOIST O.K. W/O PROPOSED

PARTITIONS. MET "SISTER!" EXISTING


TOIST OIZ PROVINE INTERMEDIATE SUPPORT

WALLS AS NOTED IN PLANS ENL

DRUPPOSED REMOVATIONS.

#### NOTICE:

1.) ALL CONSTRUCTION TO CONFORM TO ALL APPLICATE NATIONAL, STATE, LOCAL CODES AND OPPOINANCES
2.) ALL DIPPENSIONS AND MORE SHOWN ON THESE PLAND ANY APPLICABLE SPECIFICATIONS MUST BE VESTY CLIENT/CONTRACTOR BEFORE ANY CONSTRUCTION OTHERWISE THE DESIGNER HILL NOT BE RESPONSIBLE FOR ANY EPROPES OR OTHISSION. THE DESIGNER AS NO RESPONSIBILITY FOR CHANGES AND/OR REYISION OF PLANS/DRAWNISS BY CLIENT/CONTRACTOR.

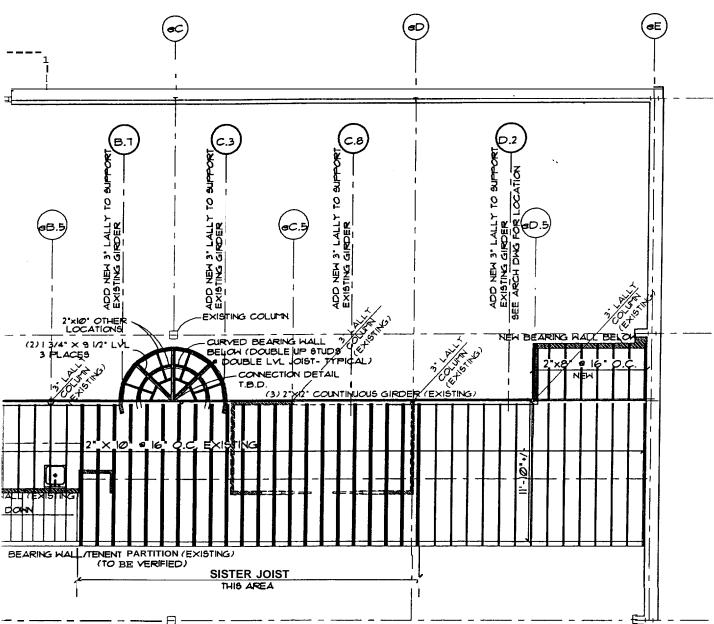

T NEW BEARING \*UPPORT THESE DIST- THIS AREA \*S FOR WALL LOCATION

#### ANINE FRAMING PLAN

SCALE 1/8" = 1'-0"

SHEET NO. A.V. Engineering, LLC 9-28-04 CALCULATED BY. PO Box 1254 Wells, ME 04090 CHECKED BY SCALE HALF. CIRCLE MEZEANINE EXTENSION P. 4 (150) = 600# WALL HEIGHT < 10 W= 10x15 1=195/LF1 T.W. 24 PLAN YIEW W=315 # LL= 50 PSF DL=20 PSF TL= 70 P.F SOLID (2) 13/4" × 91/2" LYL BLOCKING T.A & 455 SF W: 4.5(70) -300 T = 315# L 36" +1-18 DOUBLE R=1,215# 16 6A6E 6" MTL STUDS SECTION @ RADIUSED DECK

JOB PLANET DOG

SCALE: NOME

A.V. Engineering, LLC PO Box 1254 Wells, ME 04090		SHEET NO.	OF
		CALCULATED BY	DATE 9-28-04
		CHECKED BY	DATE
		SCALE	
DETERMI	NE IF LYL'S ARE	ADEOVATE TO	LAT
FBD'	B A A B A R. R.		
	G= MB=		
	ZMB-		= 1215 # 1
	100		315+600-1215 300# L 300# L
			= 13,900"=12 = 1163 1-# < 13,863" /= 1,215 # < 6,318# 
	BY INSPECTION : AS LATED OUT IN		PEQUATE


JOB PLANET DOG


JOB PLANET DOG SHEET NO A.V. fnginecring, LLC 9-28 CALCULATED BY\_ **PO Box** 1254 CHECKED BY Wells, ME 04090 65W16 DOUBLE STUDS AT ALL LYL LOCATIONS - TYPICAL (2) 1/2 \$
THREADED RODS BEVEL WASHERS ANCHOR COLUMN TO EVASTING B/V GIRDER & ANCHOR COLUMN TO HHUS410 SLAB TO PUSIST 1,200 SIMPSON HANGER UPLIFT FOLLE PLAN VIEW 2×10 NOTE: MOT SHOWN FOR CLAMITY - SEE STANCTURAL SHT S-Z

FOR INFORMATION NOT SHOWN

#### PLANET DOG 211 MARGINAL WAY PORTLAND, ME 04101

## ENTRY RENOVATIONS

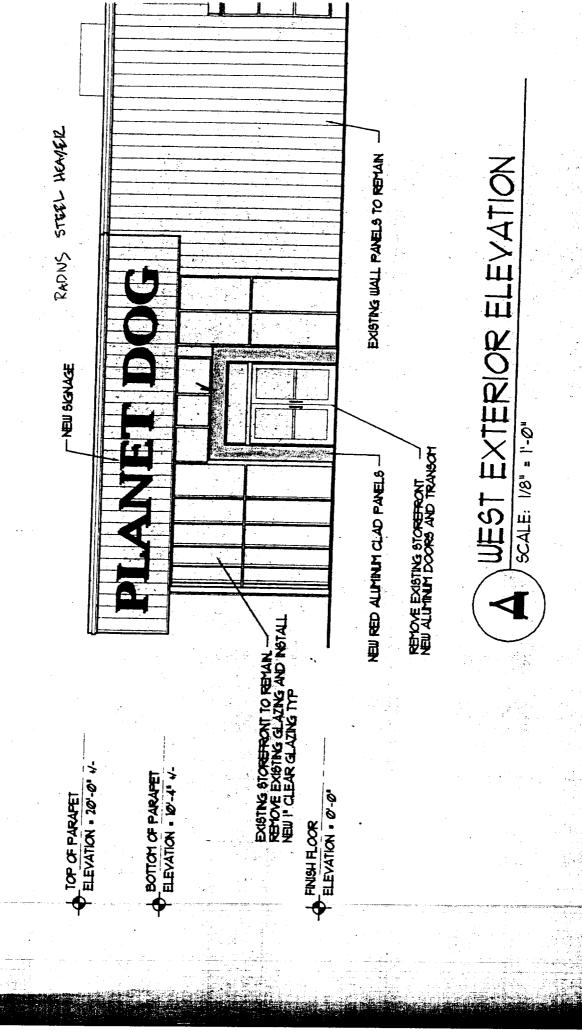

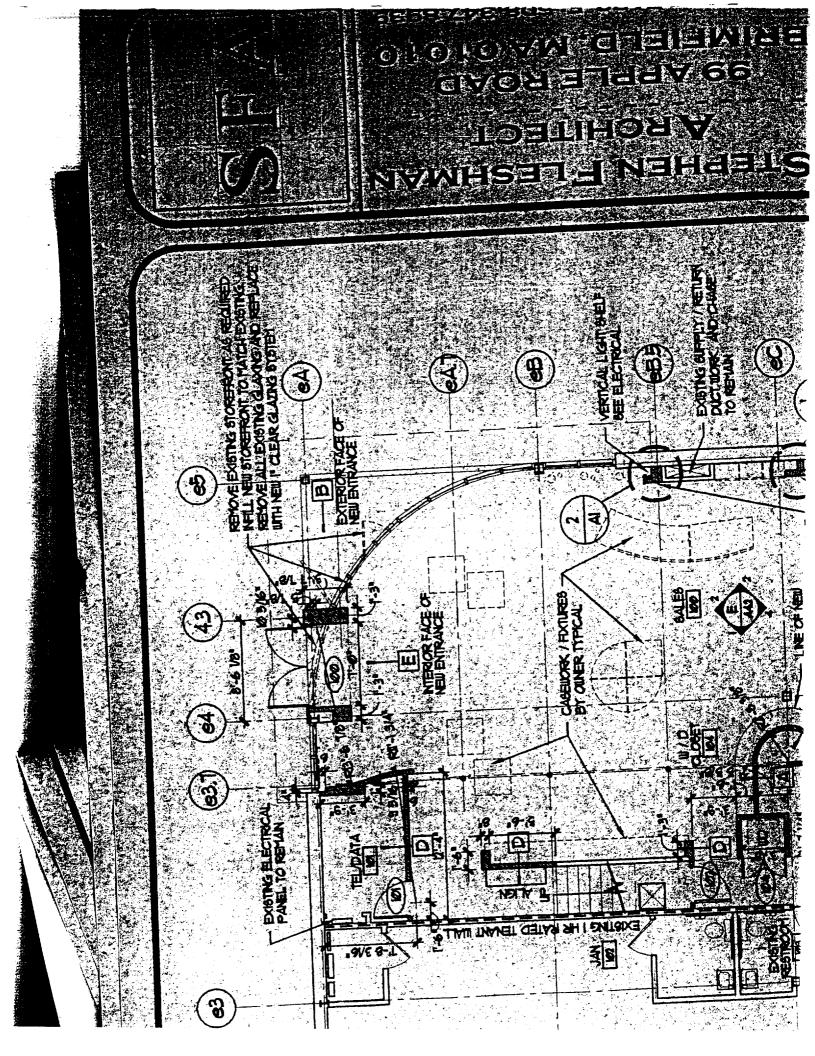

A.V. Engineering, LLC PO Box 1254 Wells, ME 04090

JOB PLANET DOG	
SHEET NO	OF
CALCULATEDBY AV	DATE 9-27
CHECKED 8Y	DATE

#### DETERMINE LONING ON NOW MOMENT FRAME;

APPROX. HEIGHT OF FRAME: 29-6"
APPROX. POINT HOM C TOP OF FRAME:
WIFOUM LOND ALONG FRAME:
CONCENTRATED LOND

SCALE

3 x 5 x (-20.3) = 3 x + 914 = 1219# -7 1300# ESTIMATE LOAIS @

MOMENT COUPLE = 7620 = 3040#

IBC 2000 TABLE 1609.6.2.1(2) BWS : 100 MPH = 15 EFFECTIVE WIND AND 2 SO SF 204E 5 16.1 PSF -20,3 BF I=1,0 HT ADJUSTMENT FROM 1.0 (16.1)(4.5) = 72.45 PLF (-20,3)(4.5) = - 91.35 PLF Mq = 914(5")+ 305(10")= 7620#-1

AV. Engineering, LLC PO Box 1254 Wells, ME 04090

JOB PLANET DOG	
SHEET NO	_ OF
CALCULATED BY	DATE 9-27
CHECKED BY	DATE

#### DETERMINE LOMING ON NEW MOMENT FRAME;


SCALE

APPROX. HEIGHT OF FRAME: 24-6"

APPROX. POINT HOM C TOP OF FRAME: 1300 #

WIRDLIN LOM ALONG FRAME: -92 PLF, 73 PLF

CONCENTRATED LOND & 1300 # AT EXISTING COLUMN

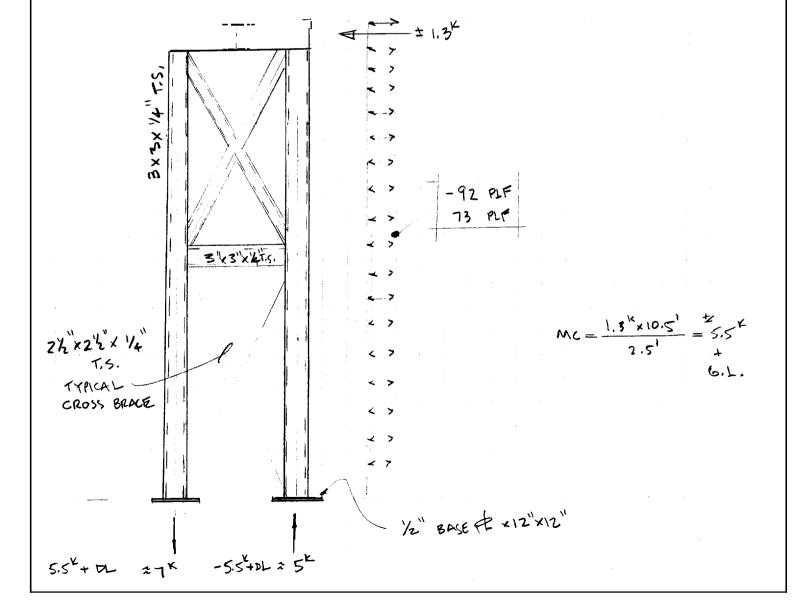

A.V. Engineering, LLC PO Box 1254 Wells, ME 04090 SCALE FIELD ATTACH W8 BEAM = 1/4" # TO EXISTING COLUMN & NEW MOMENT FRAME SHOP FABRICATE W/4" # WELDED TO WBX NEW TOP FLANGE MOMENT FRAME -SHOP PRAMMUS REQUIRED SEE SK-1 EXISTIML 5K-3 W COLUMN REINFORCE MITH 3/8" THICK PLATES BOTH FLANGES -FIELD WELDING RE01 - 505 DETAIL T.B.V. 45 @ 12" H FON WALL EACH SIDE TO FROST DEPTH PARTIAL ELEVATION AT STORE ENTRY

PLANET DOG

A.V. fingineering, LLC PO Box 1254 Wells, ME 04090

Trus, III. 01050	SCALE/
	1/4"x4"x10" te
Tube strel = 50 KS1	
CONCRETE = 3,500 PSI	
SHOP WELDING ONLY	
THEORY FOLLING	
CONNECTIONS USING  A307 THREAMED 1209 = 4	
A 325 BOLTS -	
· · · · · · · · · · · · · · · · · · ·	X X X X X X X X X X X X X X X X X X X
F	· · · · · · · · · · · · · · · · · · ·
	X X
	* * * * * * * * * * * * * * * * * * *
TTP 3/16 V 4" #	
1/2 /½	(12'x12"
3.7	E PE ON GROT !
	1.4
3/4 \$ x 18" LONG	
A307 THILEMACT	#5@12"Y
POO - B PLACES	#Se Iz" H BOTH SIDES
	3-8"
(PER	ARCH)
	PARTIAL DETAIL
2"×2"×1/4" FLAT	P AT MONAGUET ED ANS
\$ 2 MUTS - T	PICAL
EACH ROD	

PLANET DOB A.V. fngineering, LLC 9-27 CALCULATEDBY PO Box 1254 CHECKED BY Wells, ME 04090 NONE WOX T.B.D. W/36" RXTBD. SHOP WELDES ( WB TO BE FIELD BOLTEN, SHEAR TAB ( 1/2) AL TO BE FIELD WELDER) COMNECTION AT MOMMENT FRAME WBX NOTE: O SHOP FARMICATE ENTIRE MOMENT FRAME OSEE SK-1 FOR OTHER INFORMATION DETAIL OF TOP PORTION OF

#### PLANET DOG 211 MARGINAL WAY PORTLAND, ME 04101

### **MISCELLANUOUS**

City of Portland, Maine - Building or Use Permit			Permit No:	Date Applied For:	CBL:	
<b>889</b> Congress Street, 04101 Tel: (207) 874-8703, <b>Fax:</b> (207) 874-8716			04-1366	09/14/2004	024 C001001	
ocation of Construction:	Owner Name:		O	wner Address:		Phone:
211 Marginal Way	Marginal Way Propert	ies Inc	8	7 Sea Meadows L	n	781-237-3677
Business Name:	Contractor Name:		Co	Contractor Address:		Phone
	Destefano and Associa	ates	2	456 Lafayette Rd	Portsmouth	(603) 765-1638
.essee/Buyer's Name	Phone:			ermit Type:		
			A	Alterations - Comr	nercial	
'roposed Use:	•	Pr	oposed ]	Project Description:		
Commercial space w/ tenant fit-up		C	Comme	rcial space w/ tena	nt fit-up	
Dept: Zoning Status: Approved Reviewer: Marge Schmuckal Approval Date: 09/20/2004						
<b>Dept:</b> Zoning <b>Status:</b> A	pproved	Revie	wer:	Marge Schmucka	l Approval D	ate: 09/20/2004
Dept: Zoning Status: A Note:	pproved	Revie	ewer:	Marge Schmucka	Approval D	ate: 09/20/2004 Ok to Issue: ✓
	pproved	Revie	ewer:	Marge Schmucka	l Approval D	
Note:					••	Ok to Issue:
Note:  Dept: Building Status: Pe				Marge Schmucka	Approval D	Ok to Issue:
Note:					••	Ok to Issue:
Note:  Dept: Building Status: Pe					••	Ok to Issue:
Note:  Dept: Building Status: Po	ending	Revie	ewer:	Mike Nugent	Approval Da	Ok to Issue:
Note:  Dept: Building Status: Ponte:  Dept: Fire Status: A	ending pproved with Condition	Revie	ewer:		••	Ok to Issue:  Ok to Issue:  Ok to Issue:  Ok to Issue:  O9/23/2004
Note:  Dept: Building Status: Ponote:  Dept: Fire Status: A Note: reviewed under wrong edition	ending  pproved with Condition n of codes	Revie	ewer:	Mike Nugent  Lt. MacDougal	Approval Da	Ok to Issue:
Note:  Dept: Building Status: Ponte:  Dept: Fire Status: A	ending  pproved with Condition n of codes	Revie	ewer:	Mike Nugent  Lt. MacDougal	Approval Da	Ok to Issue:  Ok to Issue:  Ok to Issue:  Ok to Issue:  O9/23/2004
Note:  Dept: Building Status: Ponote:  Dept: Fire Status: A Note: reviewed under wrong edition	pproved with Condition n of codes be NFPA 2000 edition	Reviens Revie	ewer:	Mike Nugent  Lt. MacDougal	Approval Da	Ok to Issue:  Ok to Issue:  Ok to Issue:  Ok to Issue:  O9/23/2004

#### **Comments:**

09/24/2004-mjn: Need structurals for mezzanine extensions and guards, have egress questions......Left message with Owner, Architect and Builder

#### All Purpose Building Permit Application

If you or the property owner owes real estate or personal property faxes or user charges on any property with

the Ony, payment arrangements must be made before permits a arry kind are accepted.
Location/Address of Construction: 211 Marginal Way
Total Square Footage of Proposed Structure  Existing 40524 Marginal Wantweeter
Tax Assessor's Chart, Block & Lot Owner: Tod Tarnum Telephone:  Chart# Block# Lot# 555 (Washington St 781  Wellester IM and 02482 237-3677
Lessee / Name (If Applicable)  Plant Dog Rotall LC  De Steton Hassociated Work: \$50,000  Just Lasay He Ed Fee: \$ 546 / Do
Current use: Vacant Inc 75 cx 0
Approximately how long has It been vacant: 8 month
Proposeduse: Retail Project description: F, top for Manet Log Retail
Contractor's name, address & telephone: DESTONE & ASSOCIATES  Who should we contact when the permit is ready Toky Toky
Mailing address: 2256 Calare He Toad
We will contact you by phone when the permit is ready. You must come in and pick up the permit and review the requirements before starting any work, with a Plan Reviewer. A stop work order will be issued and a \$100.00 fee if any work starts before the permit is picked up. PHONE:
THE REQUIRED INFORMATION IS NOT INCLUDED IN THE SUBMISSIONS THE PERMIT WILL BE AUTOMATICALLY DENIED AT THE DISCRETION OF THE BUILDING/PLANNING DEPARTMENT, WE MAY REQUIRE ADDITIONAL NFORMATION IN ORDER TO APROVE THIS PERMIT.

I hereby certify M I am the Owner of record of the named property, at that the owner of record authorizes the proposed work and that I have been authorized by the owner to make this application as his/ner authorized agent. I agree to conform to all applicable laws of this jurisdiction. In addition, if a permit for work described in this application is issued, I certify that the Code Official's authorized representative shall have the authority to enter all areas covered by this permit at any reasonable hour to enforce the provisions of the codes applicable to this permit.

Signature of applicant:	PHOTINE	Date:	9/3/04
		·	

This is NOT a permit you may not commence ANY work until the permit is issued.

If you are in a Historic District you may be subject to additional permitting and feeswith the Planning Department on the 4th floor of City Hail

99 APPLE ROAD BRIMFIELD. MA 01010

To:

PHONE: 508.347.7188 FAX: 508.347.8939 Fleshman@SF-Arch com

#### STEPHEN FLESHMAN ARCHITECT

DATE:



9.15.04

Stephen Fleshman Architect

### TRANSMITTAL

**DESTFANO ASSOCIATES** 

ATTN:	JOHN <b>D</b> E	STEFANO	PROJEC RE:	TNo. 04-002
WE ARE SI	ENDING:	Attached	Under separate cover v	ria
Shop Drawi	ngs prints	specifications	Plans samples	Copy of letter
	TE NO.	DESCRIPTION		
	9.15.04 9.14.04	Accessibility Certific PDF Files on CD - A	eate <b>and</b> Certificate of Design, A1, A2, <b>and</b> A3	gn
For Your Roll  For Your Roll  For Your Use  As Requeste	Review Review Review Review	wed as Noted S wed as Submitted R	esubmit copies for review ubmit copies for distribution eturn corrected <b>prints</b> or <b>Your</b> Review/ Comments	We are sending the original by mail  Prints Returned After Loan to US  FORBIDSDUE
REMARKS			ate I will fax once I get info	o from <b>Andy.</b> It does not
copy:	Steve		Signed:	Sull Sull



CITY OF PORTLAND
BUILDING CODE CERTIFICATE
389 Congress St., Room 315
Portland, Maine 04101

34/

"7	7	``	
- 1	١.	J	

Inspector of Buildings City of Portland, Maine Department of Planning & Urban Development Division of Housing & Community Service

FROM:

Styphial Fleshman

RE:

Certificate of Design

DATE:

SEPT 15 2004

These plans and / or specifications covering construction work on:

PLANET DOG TENANT FIT UP At 211 MARGINAL WAY

Have been designed and drawn up by the undersigned, a Maine registered Architect / Engineer according to the BOCA National Building Code / 1999 (Fourteenth Edition)

STEPHEN R. CT FLESHMAN No. 2421

\$50,000.00 or more in new construction, repair expansion, addition, or modification for Building or Structures, shall be propared by a registered design Professional.

Signature:

Title: Principa

Firm: Stephen Fleishmon Architect

Address: 99 Applie Let Brimbield Min 01010




CTTY OF PORTLAND BUILDING CODE CERTIFICATE 389 Congress St., Reom 315 Portland, Maine 04101 3

#### ACCESSIBILITY CERTIFICATE

Designer: Stephen Hishman Architect
Address of Project: 211 MARGINA) WAY
Nature of Project: TENANT Fit up of Existing
Retail Space
,

The technical submissions covering the proposed construction work as described above have been designed in compliance with applicable referenced standards found in the Maine Human Rights Law and Federal Americans with Disability Act.

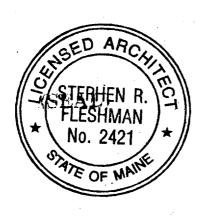

Signature: Synt H
Title: Principal
Firm: Shephen Fleshman Arch, heet
Address: 99 Apple lons
Brinfield, Ma 01010
Phone: 508.347.7188



CITY OF PORTLAND BUILDING CODE CERTIFICATE 389 Congress St., Room 315 Portland, Maine 04101

Inspector of Buildings City of Portland, Maine TO: Department of Planning & Urban Development Division of Housing & Community Service FROM DESIGNER: DATE Job Name: Address of Construction: THE BOCA NATIONAL BUILDING CODE / 1999 (FOURTEENTH EDITION) Construction project was designed according to the building code criteria listed below Building Code and Year BOCA 19 / NEPA 10: 97 Use Group Classification(s) M Type of Construction \_ Structural Systams Barthquake Loads Roof Snow Load Peak velocity-related acceleration, Av \_\_\_\_\_ Ground Snow Load (Pg) Peak acceleration, As .. \_\_ If Ps >10 pst, Plat Roof snow load, Pf "Selecula hexard exponure group \_\_\_If Pg > LD psf, snow exposure factor, Ce Seismic performance.caregory If Pg >10 pet, roof thermal factor \_\_\_\_Soil profile type \_\_If Pg >10 pef, snow load importance factor, I Basic structured system /seismic-resisting system Sloped Rmof Snowlead Pr Response mudification factor, R, and deflection amplification factor, Cd, The documents must account for Drift snow load, unbalanced snow load and Silding snow loads as required. Wind Londs - (PEL ASCE 7-02) Basen upon Design Condition Internal Prossure Coefficient 100 MAH (Basic Wind Speed SASKA UPW B. Wind Exposure Category beisign compliants Wind Design Pressure 1.0 Wind Importance Pactor \* Existing Structural systems to Remain in place (NO west) Provent is Tenant fit up only



## Application for Construction Permit

SHADED AREAS ARE FOR OFFICE USE ONLY (8/04)

Department of Public Safety State Fire Marshal's Office 52 State House Station Augusta, Maine 04333-0052

Tel: 207-626-3870 Fax: 207-287-6251

Project Name: Phanet Rog Tenant Fit UP			
Street Location: 211 Marginal Way	Town Location: Portions		
County: Combrelano	Number of Stories:		
New Building: Renovation:	Addition: Cocupancy Change:		
Sprinkler System: Yes Supervised: Yes W	Square Footage: 3935 6205 S		
Date of Construction start-up: Oct 1 2004  Disc Included:	Estimated Project Cost: \$5000 Construction Permit Fee: 100.00		
Occupancy Clas	sification		
Apartments Nursing Home	Educational		
Hotel / Motel Industrial Rooming & Lodging Residential Care Leve	Daycare Detention		
Congregate Housing Residential Cere Leve			
Hospital	0  ≥300≤1000  ≤300  Other		
Limited Care Mercantile A			
Construction	Type )		
Fire Resistive: Type I (443), (332)	Unprotected Ordinary: Type III (200)		
Protected Non-Combustible: Type II (222), (111) Unprotected Non-Combustible: Type II (000)	Heavy Timber: Type IV (2HH)  Protected Wood Frame: Type V (111)		
Protected Ordinary: Type III (211)	Unprotected Wood Frame: Type V (000)		
Addresse	s )		
Owner's Name: Plant Dog Tele	phone: 207.761.1515 Fax: 207.761.2525		
Mailing Address: 322 Fore Street			
Town: Post I muo State: M	Zip Code: <u>04/01</u>		
Design Professional: Stephen Fleshman Telep	hone: 508.347.7188 Fax: 506.347.8939		
Maine Registration Number: 2421	E-mail: A-Eshman @ SF-Arch.com		
Mailing Address: 99 Apple Low 13	A		
Town: Brimfield " State: M.	Zip Code:		
	hone: 603.430.0339 Fax: 603.430.0346		
Mailing Address: 2456 Lafagette Rd			
Town: Portsmouth Astale: 1	Zip Code: <u>0380</u>		
Signature of Applicant: Shall H			
Preliminary Approval: Date:	Approved By:		
Construction Permit: Date: 9/17/04	Approved By: All Many		
Approval Letter: Date:	Approved By:		
CLOS PATERIANS LOCALIDADES AND ASSESSMENT OF THE PATERIAL			
LOG# DATE PLANS REVIEW FEE PATE FEE CHE	CK# PLAN REVIEWER DATE PERMIT #		



# Application for Barrier-Free Permit

State Fire Marshal's Office 52 State House Station Augusta, Maine 0433340052

> Tel: 207-626-3870 Fax: 20**7-2**87-6251

SHADED AREAS ARE FOR OFFICE USE ONLY (8-25-04)



Project Name: Plant Do Street Location: 211 Margin County: Com hereland	IN WAY TOV	vn Location: PoeHmnn Zip Code: 04101		
New Building:  Project Cost:  50,000	Renovation: ///	Change of Use:		
Mailing Address: 99 Apple 20 Town: Beimfield Maine Registration Number: 242 Design rulessional's Si	State: <u>MA</u>			
Approved for Permit: Date: 9/17/09 Plan Reviewer: 1.10.0/				
LOG# PATE PLANS REVIEW FEE 9/17/04 75.00	REGENES CHECK#	PLAN REVIEWER DATE PERMIT # PERMIT #		