

NOTES:


- 1. THIS IS A SCHEMATIC DESIGN FOR CONCEPT ONLY. FINAL CIRCUITRY AND INSTALLATION WILL BE THE RESPONSIBILITY OF THE INSTALLER. SUBMIT FINAL ELECTRIC DRAWINGS TO ARCHITECT PRIOR TO INSTALLATION FOR APPROVAL.
- 2. ALL BEDROOM RECEPTACLES TO BE ARC FAULT PROTECTED.
- 3. GROUND FAULT CIRCUIT INTERUPTOR RECEPTACLES ONLY IN KITCHENS, BATHROOMS AND LAUNDRY ROOMS
- 4. 20 AMP CIRCUITS MINIMUM.
- 5. 12 GAUGE WIRE MINIMUM.


STOPPED TO MEET RATING OF WALL.


- 6. ALL RECEPTACLES AND TELEPHONE JACKS TO BE INSTALLED AT 12" O.C. FROM THE FLOOR UNLESS OTHERWISE NOTED.7. OUTLETS IN DEMISING WALLS OF UNITS SHALL BE FIRE
- 8. INSTALL (2) TYPE "CC" FIXTURES IN ATTIC. INSTALL SWITCH AT ACCESS POINT.
- 9. INSTALL (2) 200 DEG. FIXED TEMP. HEAT DETECTORS IN ATTIC.
- 10. IN ACCESSIBLE UNITS (ANDERSON BUILDING 2, AND 17 NORTH STREET WESTBROOK) SWITCHES, CONTROLS, AND OUTLETS ARE TO BE MOUNTED NO HIGHER THAN 42".

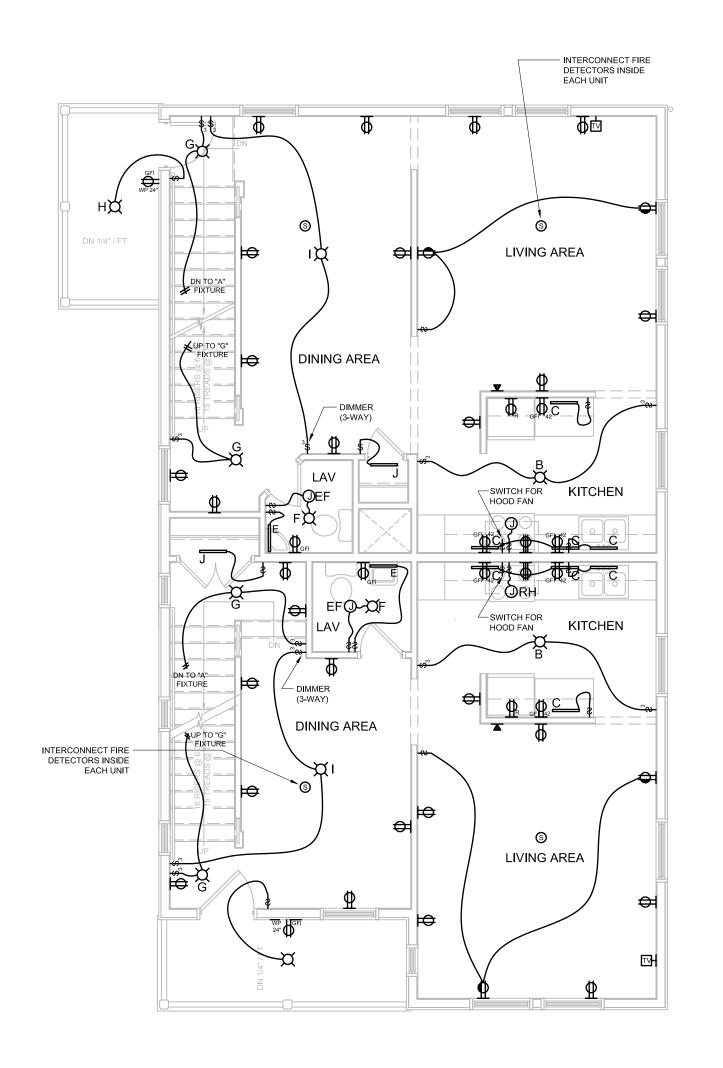

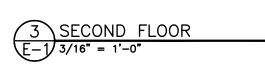

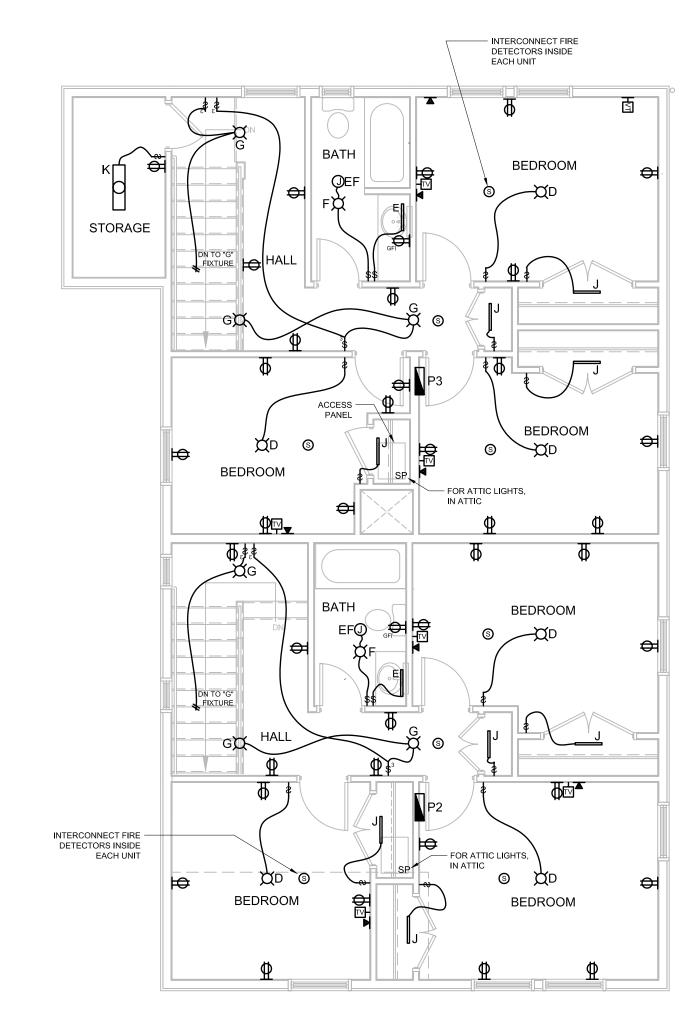

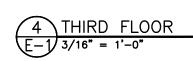

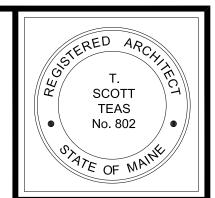

© 2005 TFH ARCHITECTS



ANDERSON STREET - BUILDING 3

PEOPLE'S REGIONAL OPPORTUNITY PROGRA
PORTLAND, MAINE

TFH ARCHITECTS
100 COMMERCIAL STREET
PORTLAND MAINE 04101
TELEPHONE 207 775 6141

CONSULTANTS:


ARCHITECTURE PLANNING

REVISIONS:

DATE:	01/14/05
PROJECT No.	0406
DRAWN BY:	SA
CHECKED BY:	DAM
SCALE:	AS NOTED

SHEET TITLE:
ELECTRICAL
FLOOR PLANS

E1.1

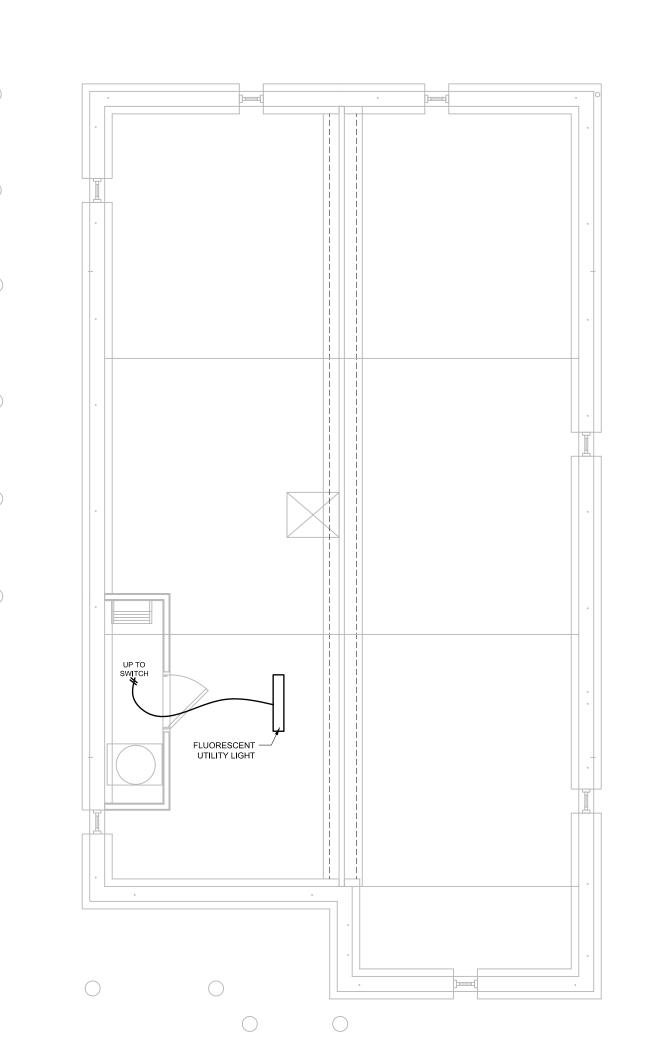

1 BASEMENT E-1 3/16" = 1'-0"

