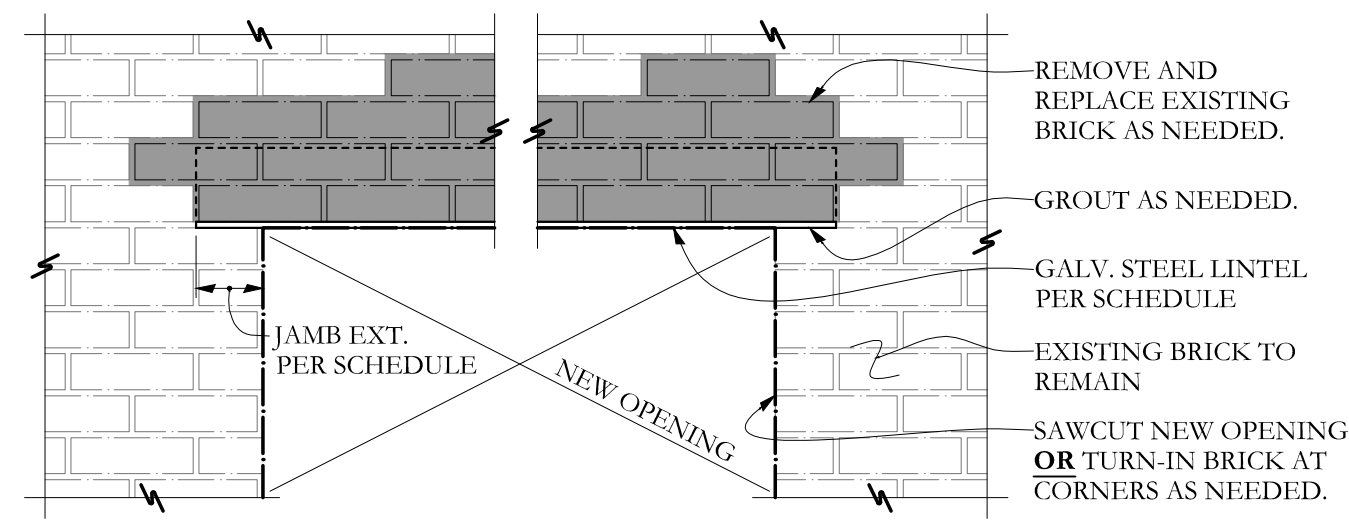


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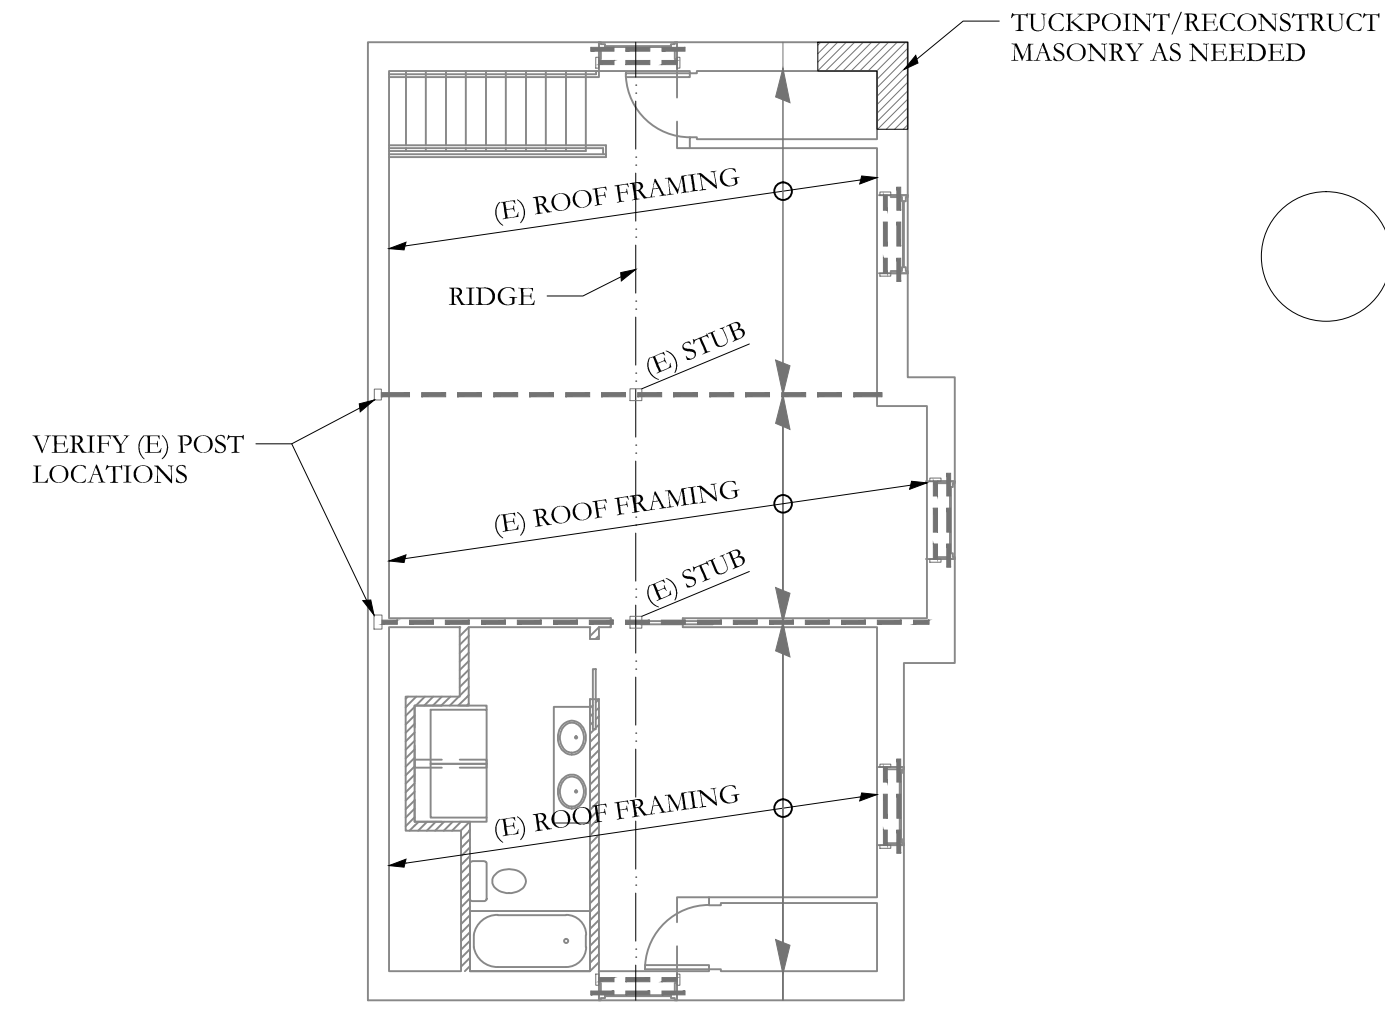
OPENING SIZE*	LINTEL PER 4" WYTHE	JAMB EXTENSION
LESS THAN 4'-0"	L3 1/2x3 1/2x1/4	4"
4'-1" TO 5'-4"	L5x3 1/2x1/4	4"
5'-5" TO 6'-6"	L6x3 1/2x1/4	8"

* FOR OPENINGS GREATER THAN LISTED, SEE PLAN.
 ** ALL TEMPORARY SHORING BY G.C. -TYP.

NEW LINTEL INSTALLATION IN EXISTING BRICK
 NO SCALE


FRAMING PLAN SYMBOLS KEY	
□	WOOD POST
○	STEEL COLUMN
(X)	NUMBER OF WOOD STUDS IN POST BELOW
A	COLUMN ABOVE THIS LEVEL
C	COLUMN CONTINUOUS THROUGH THIS LEVEL
→	JOIST BEARING
→	CONTINUOUS JOIST WITH INTERMEDIATE BEARING
→	FLUSH FRAMED JOIST BEARING WITH HANGER
→	WOOD STUD BEARING WALL BELOW
—	SHEAR WALL
"A" T	NUMBER OF TRIM STUDS UNDER HEADER
"A" K	NUMBER OF KING STUDS ADJACENT TO HEADER

LEGEND	
---	DROPPED BEAM
—	FLUSH BEAM




HIGH ROOF FRAMING PLAN

SCALE 1/8"=1'-0"
 NOTES:
 1. SEE SHEET S1.0 FOR GENERAL STRUCTURAL NOTES
 2. NEW FLOOR SHEATHING SHALL BE 3/4" T&G SHEATHING. SEE GEN NOTES FOR MORE INFO.
 3. NEW WALL SHEATHING TO BE 7/16". SEE GEN NOTES FOR MORE INFO.
 4. ALL NEW WOOD COLUMNS IN 2x6 WALLS SHALL BE (3) 2x6 AND IN 2x4 WALLS SHALL BE (3) 2x4 U.N.O.
 5. ALL HEADERS ARE DROPPED U.N.O.

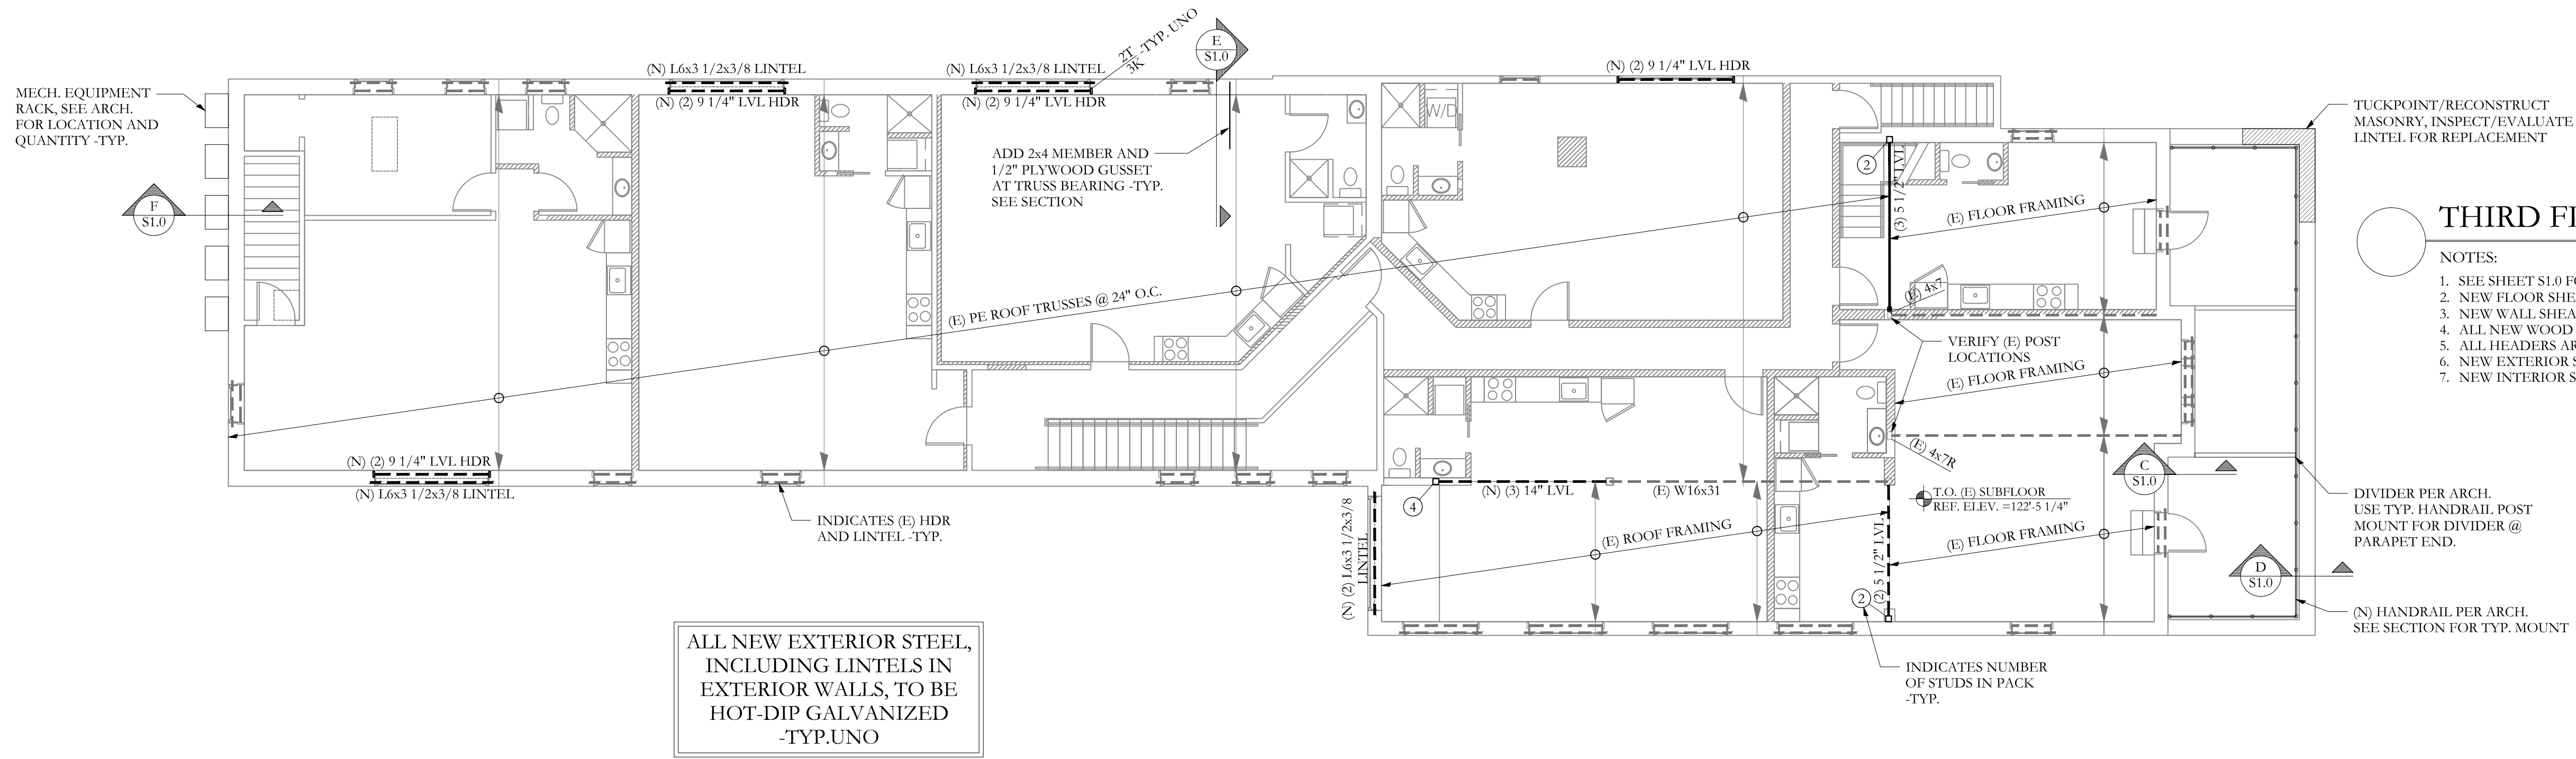


THIRD FLOOR/LOW ROOF FRAMING PLAN

SCALE 1/8"=1'-0"
 NOTES:
 1. SEE SHEET S1.0 FOR GENERAL STRUCTURAL NOTES
 2. NEW FLOOR SHEATHING SHALL BE 3/4" T&G SHEATHING. SEE GEN NOTES FOR MORE INFO.
 3. NEW WALL SHEATHING TO BE 7/16". SEE GEN NOTES FOR MORE INFO.
 4. ALL NEW WOOD COLUMNS IN 2x6 WALLS SHALL BE (3) 2x6 AND IN 2x4 WALLS SHALL BE (3) 2x4 U.N.O.
 5. ALL HEADERS ARE DROPPED U.N.O.
 6. NEW EXTERIOR STEEL TO BE GALVANIZED -TYP. UNO
 7. NEW INTERIOR STEEL TO HAVE (1) COAT OF SHOP PRIMER -TYP. UNO

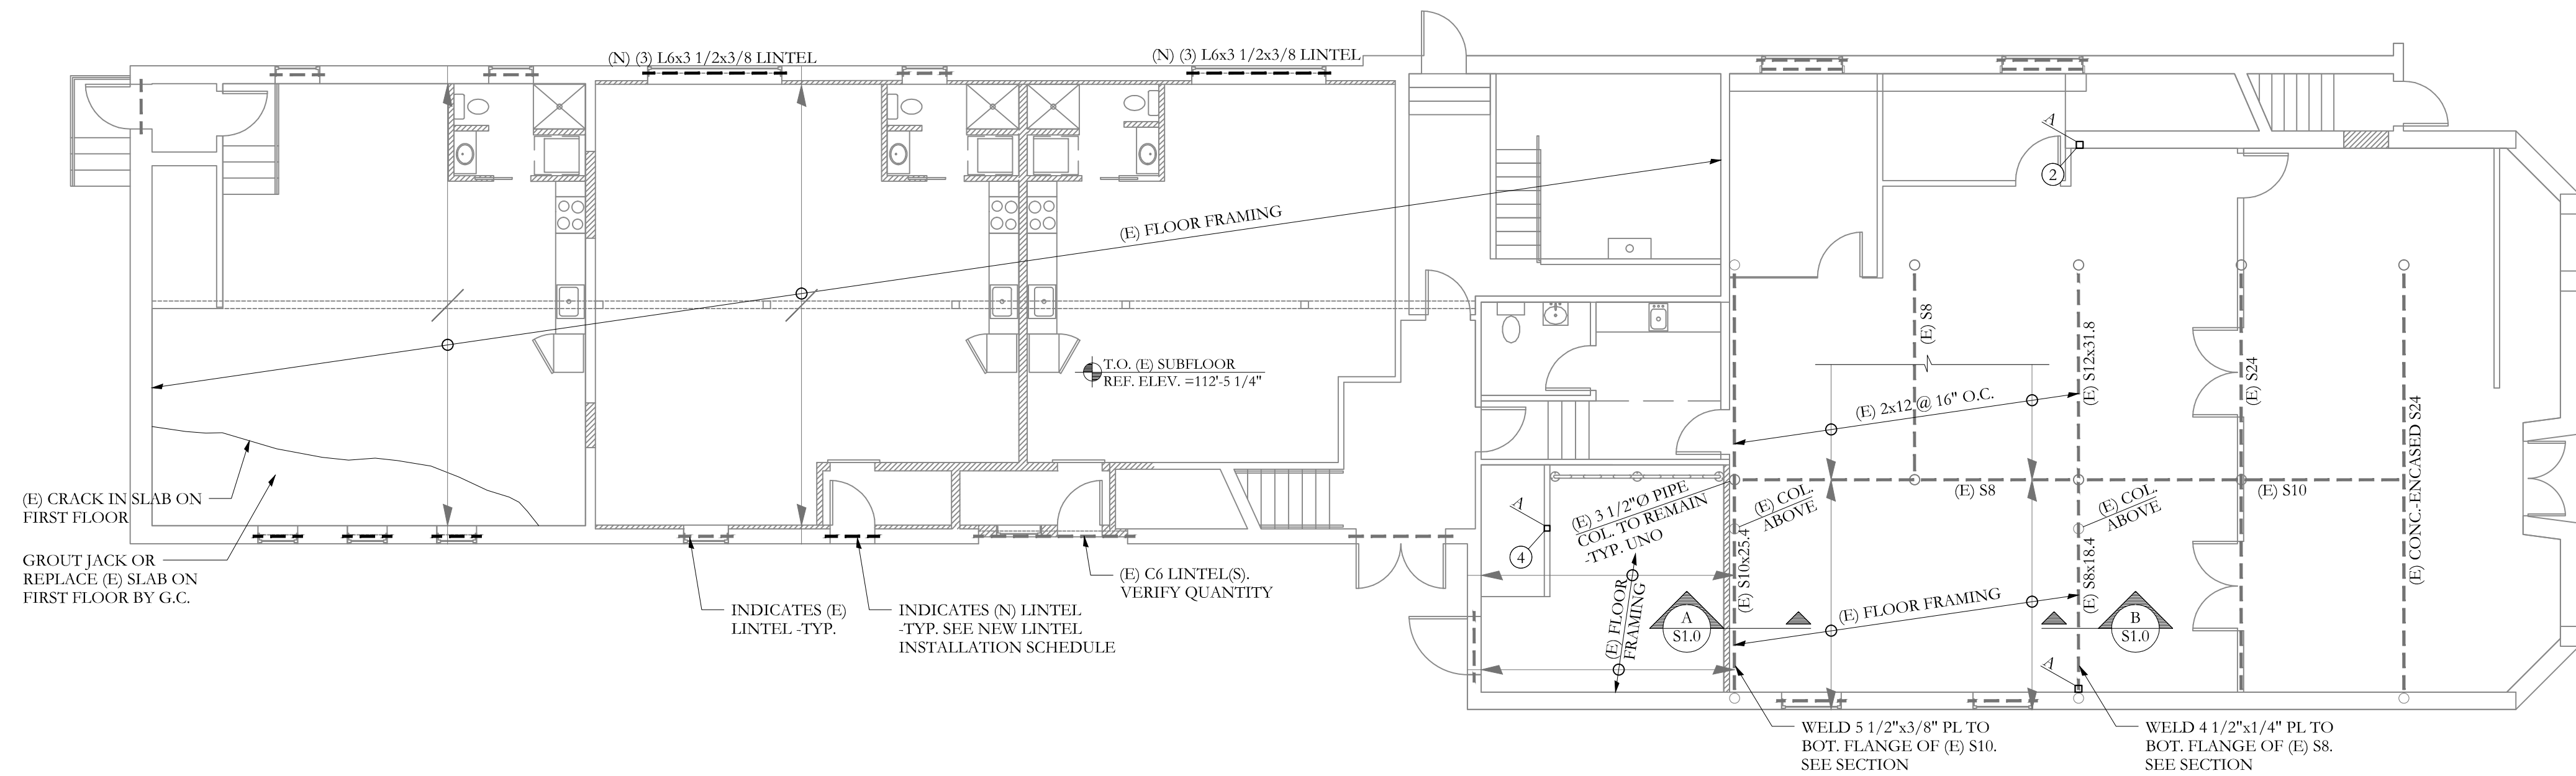

SECOND FLOOR FRAMING PLAN

SCALE 1/8"=1'-0"
 NOTES:
 1. SEE SHEET S1.0 FOR GENERAL STRUCTURAL NOTES
 2. NEW FLOOR SHEATHING SHALL BE 3/4" T&G SHEATHING. SEE GEN NOTES FOR MORE INFO.
 3. NEW WALL SHEATHING TO BE 7/16". SEE GEN NOTES FOR MORE INFO.
 4. ALL NEW WOOD COLUMNS IN 2x6 WALLS SHALL BE (3) 2x6 AND IN 2x4 WALLS SHALL BE (3) 2x4 U.N.O.
 5. ALL HEADERS ARE DROPPED U.N.O.
 6. NEW EXTERIOR STEEL TO BE GALVANIZED -TYP. UNO
 7. NEW INTERIOR STEEL TO HAVE (1) COAT OF SHOP PRIMER -TYP. UNO

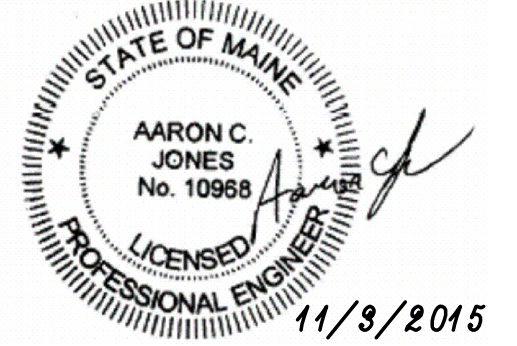

Structural Integrity
 Consulting Engineers, Inc.
 77 Oak Street
 Portland, ME, 04101
 p. 207-774-4614
 f. 866-793-7835
 www.structuralintegrity.com
 BUILD WITH CONFIDENCE
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 SI # 15-0164

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Bild Architecture
 PO Box 8235
 Portland, ME
 04104
 207.408.0168
 evan@bildarchitecture.com

PROJECT NO.
15019
 PROJECT NAME
**273 CONGRESS STREET
 PORTLAND, ME**

REVISIONS	PERMIT SET
1	
2	
3	
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5	

DRAWN BY
BDH
 SHEET TITLE
FRAMING PLANS

ISSUE DATE
11/03/15
 SHEET SCALE
AS NOTED

S
S1.1