


CALC FILE: C1003 INDIA ST 4TH FLOOR.WX1

Design Area No. WX1 - 13R  
 Density 0.05 Area 4 HEADS  
 Flow 64.8 gpm @ 46.7 psi  
 Includes 0 gpm Hose allowance

- 5 VIKING FREEDOM RESIDENTIAL PENDENT  
 155' WHITE, K=4.9, 1/2" NPT, SIN VK468  
 W/ MODEL E-1 RECESSED ESCUTCHEON
- ◁ 5 VIKING FREEDOM RESIDENTIAL HORIZONTAL SIDEWALL  
 155' WHITE, K=4.0, 1/2" NPT, SIN VK453  
 W/ MODEL E-1 RECESSED ESCUTCHEON

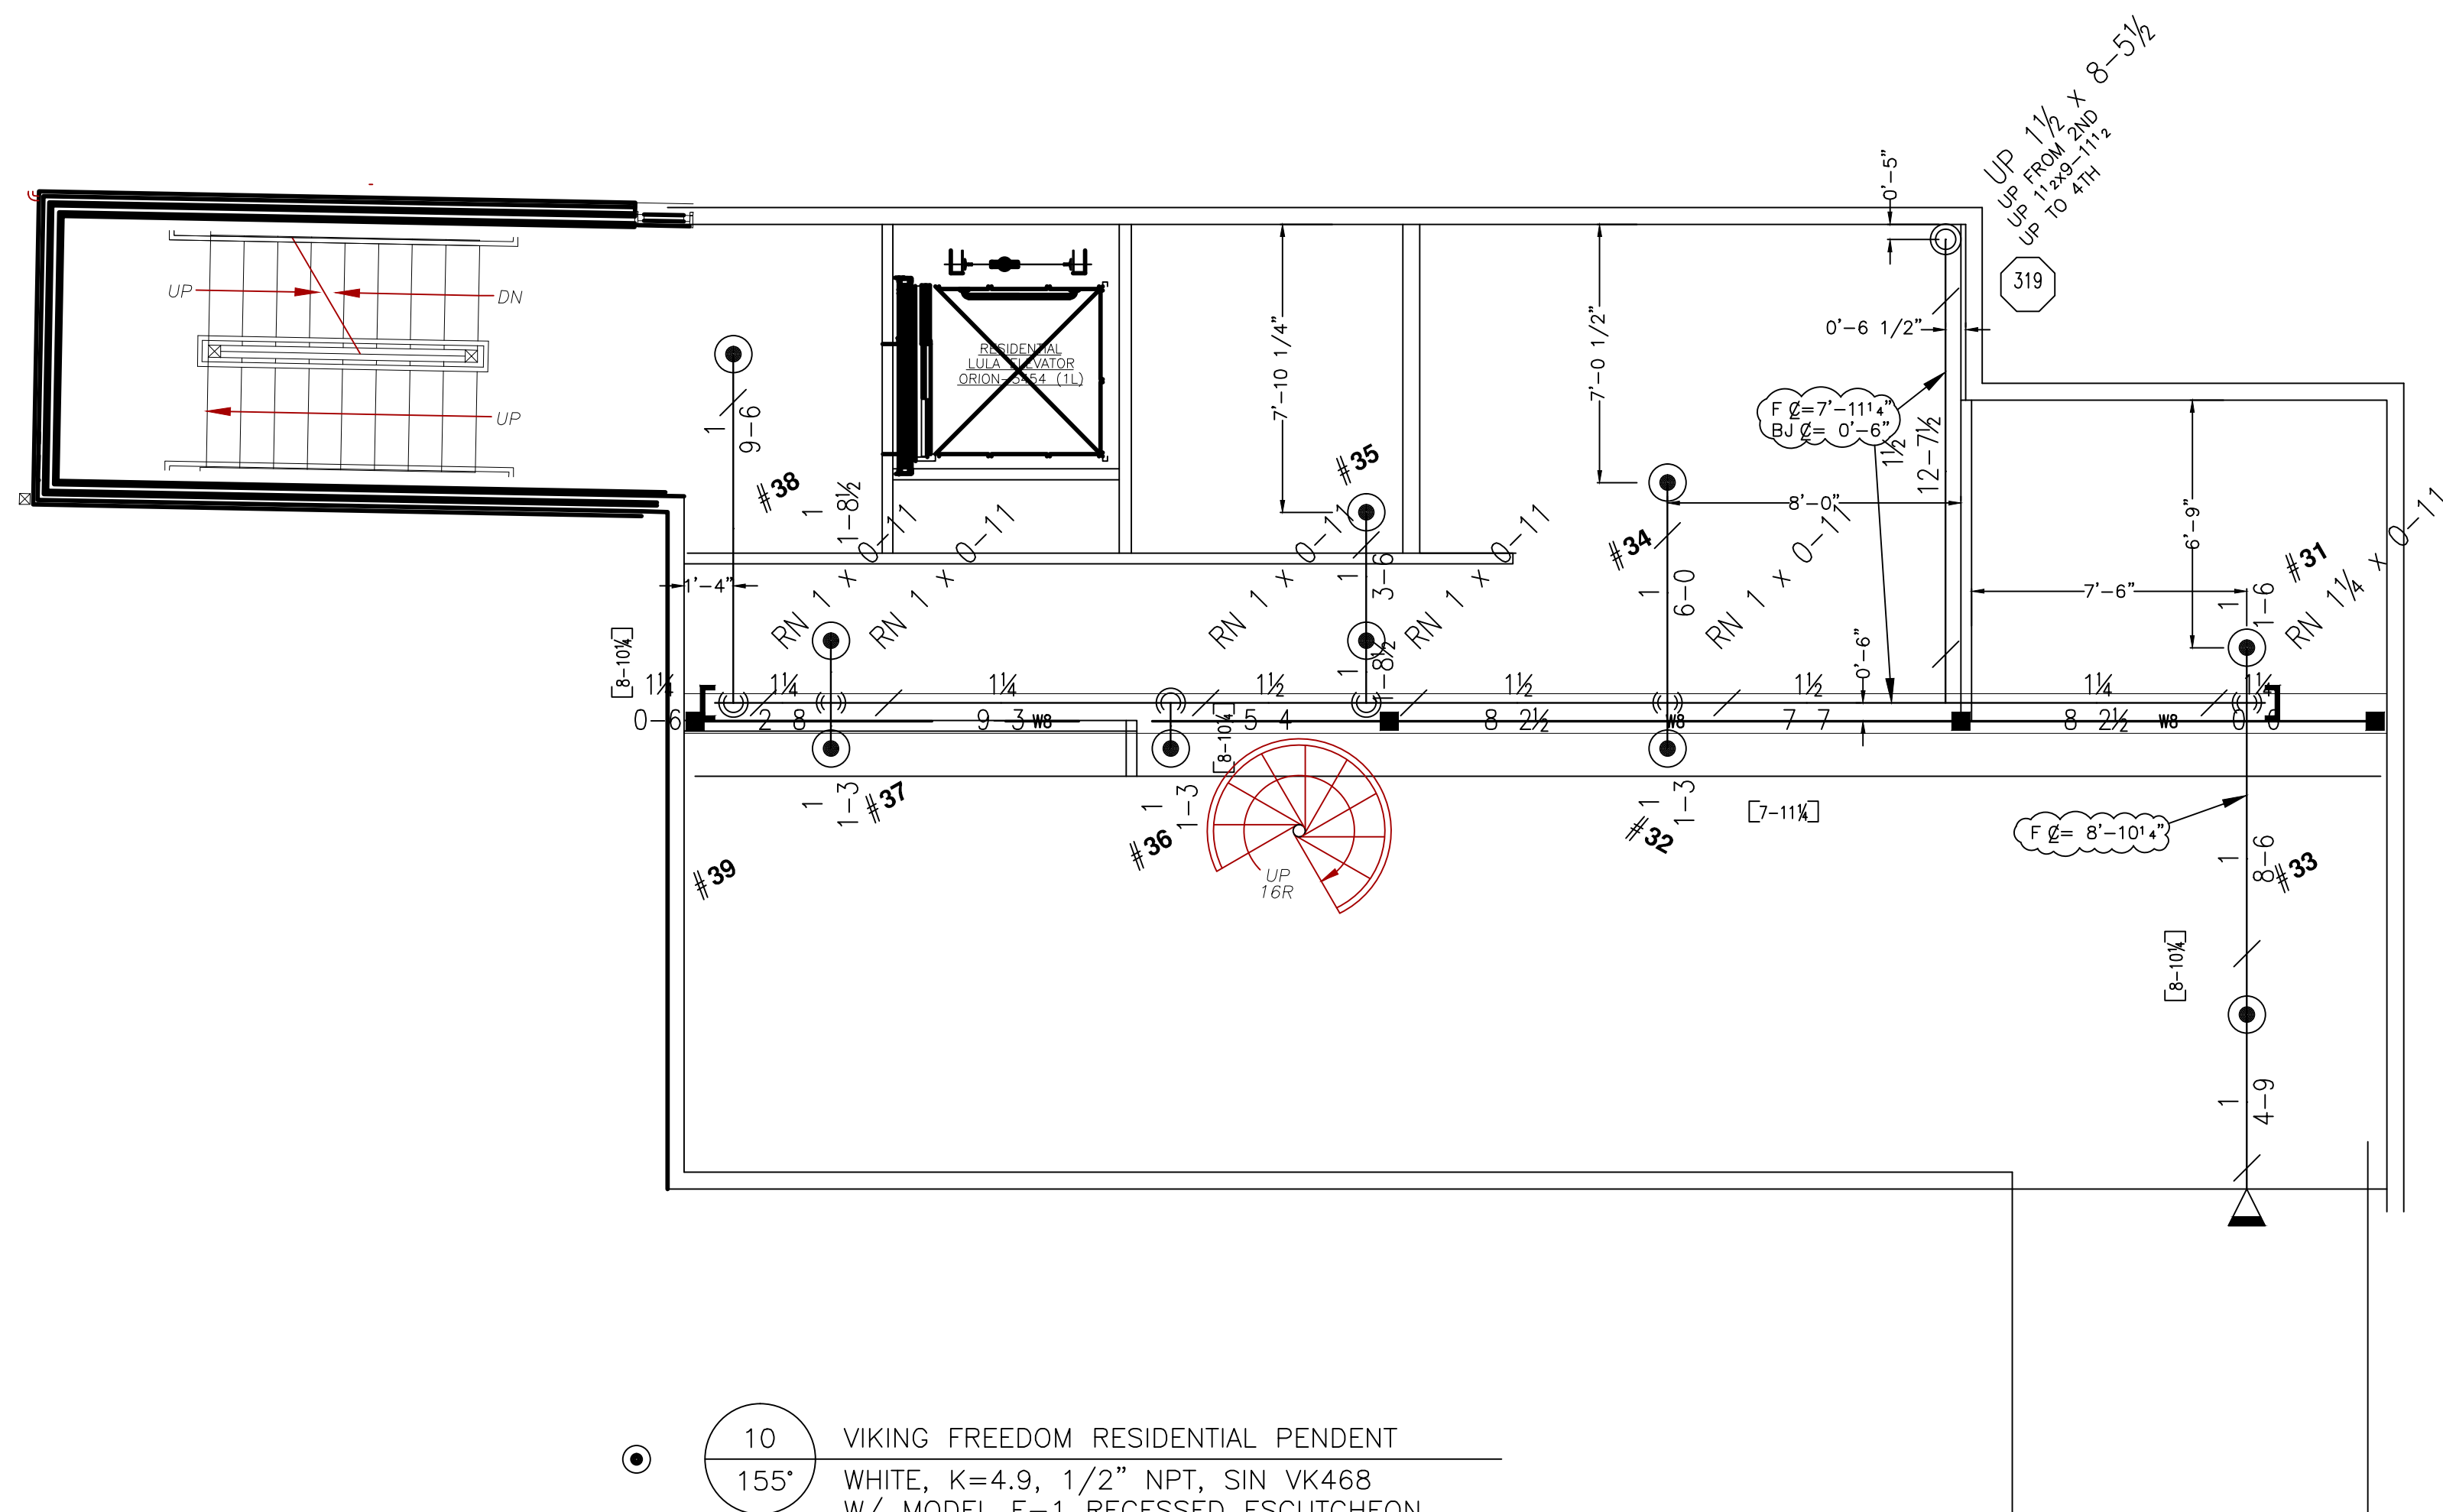

**LEGEND:**

- UPRIGHT SPRINKLER ON A BRANCH LINE
- COMMERCIAL RECESSED PENDENT SPRINKLER ON A 1" DROP
- ◁ COMMERCIAL RECESSED HORIZONTAL SIDEWALL SPRINKLER
- △ COMMERCIAL VERTICAL SIDEWALL SPRINKLER ON A 1" DROP
- ◁ RESIDENTIAL RECESSED HORIZONTAL SIDEWALL SPRINKLER
- RESIDENTIAL RECESSED PENDENT SPRINKLER ON A 1" DROP
- RISE OR DROP
- GROOVED COUPLING
- XX HYDRAULIC REFERENCE POINT
- CEILING HEIGHT
- HANGER
- F ℄= X'-X" FINISHED FLOOR TO PIPE CENTERLINE
- BJ ℄= X'-X" BOTTOM OF JOIST TO PIPE CENTERLINE
- BB ℄= X'-X" BOTTOM OF BEAM TO PIPE CENTERLINE
- C ℄= X'-X" CEILING TO PIPE CENTERLINE

**GENERAL NOTES:**

ALL THREADED PIPE IS TO BE SCH. 40 BLACK STEEL U/N.  
 ALL GROOVED PIPE IS TO BE SCH. 10 BLACK STEEL U/N.  
 ALL THREADED PIPE FITTINGS ARE TO BE BLACK CAST IRON, CLASS 125 U/N.  
 DIMENSIONS SHOWN ON THREADED PIPE ARE CENTER TO CENTER U/N.  
 DIMENSIONS SHOWN ON GROOVED PIPE ARE "CUT" LENGTHS U/N.  
 PENDENT SPRINKLERS IN ACOUSTIC TILE CEILINGS ARE NOT LOCATED IN THE CENTER OF 2X2 AND 2X4 CEILING TILE MODULES.  
 SUFFICIENT HEAT TO PREVENT FREEZING OF THE WET SPRINKLER SYSTEM IS REQUIRED TO BE FURNISHED BY THE BUYER/OWNER.

**SYSTEM CLASSIFICATION:**

A WET PIPE SYSTEM OF AUTOMATIC SPRINKLERS DESIGNED AND INSTALLED IN ACCORDANCE WITH NFPA-13, STANDARD FOR THE INSTALLATION OF SPRINKLER SYSTEMS, 2010 EDITION AND NFPA-13R, STANDARD FOR THE INSTALLATION OF SPRINKLER SYSTEMS IN RESIDENTIAL OCCUPANCIES UP TO AND INCLUDING FOUR STORIES IN HEIGHT, 2007 EDITION.  
 FIRST FLOOR: RETAIL  
 HYDRAULICALLY CALCULATED TO PROVIDE A DENSITY OF 0.20 GPM PER SQUARE FOOT OVER THE AREA OF THE LARGEST ROOM, WITH AN ALLOWANCE OF 250 GPM FOR HOSE STREAMS.  
 SECOND FLOOR: OFFICES/STORAGE  
 HYDRAULICALLY CALCULATED TO PROVIDE A DENSITY OF 0.15 GPM PER SQUARE FOOT OVER THE AREA OF THE LARGEST ROOM, WITH AN ALLOWANCE OF 250 GPM FOR HOSE STREAMS.  
 THIRD AND FOURTH FLOORS: APARTMENT-RESIDENTIAL  
 HYDRAULICALLY CALCULATED TO PROVIDE A DENSITY OF 0.05 GPM PER SQUARE FOOT OVER THE AREA PROTECTED BY THE MOST DEMANDING FOUR SPRINKLERS.

**DEAN & ALLYN, INC.**

FIRE PROTECTION • SPECIAL HAZARD

PO BOX 709, GRAY, MAINE 04039  
 (207)657-5646 FAX:(207)657-5647

- 10 VIKING FREEDOM RESIDENTIAL PENDENT  
 155' WHITE, K=4.9, 1/2" NPT, SIN VK468  
 W/ MODEL E-1 RECESSED ESCUTCHEON
- ◁ 1 VIKING FREEDOM RESIDENTIAL HORIZONTAL SIDEWALL  
 155' WHITE, K=4.0, 1/2" NPT, SIN VK453  
 W/ MODEL E-1 RECESSED ESCUTCHEON

		DANA A. STEWART NICET IV - #064544		DRAWING TITLE: <b>SPRINKLER LAYOUT          THIRD AND FOURTH FLOORS</b>		REV. 0	
APPROVED BY		DATE		SURVEYED BY		JOB:	
//		5/4/11		TEC		61 INDIA STREET PORTLAND, MAINE	
//		5/4/11		DAS		NO. OF SPRINKLERS ON THIS SHEET 21	
//		5/4/11		DAS		NO. OF SPRINKLERS ON JOB 82	
//		5/4/11		AT DEAN & ALLYN, INC		CONTRACT NO. C111003	
① SUBMIT FOR APPROVAL		5/4/11		SCALE 1/4"=1'-0" U/N		CONTRACT WITH: JOSEPH REYNOLDS 198 TUTTLE ROAD, CUMBERLAND, MAINE 04021	
REVISIONS		DATE		SHEET NO. 3 OF 3			