

THE MILESTONE FOUNDATION

PORTLAND, MAINE




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ABBREVIATIONS:

AB ANCHOR BOLT	H HORIZONTAL	SACT SUSPENDED ACOUSTIC
AC, A/C AIR CONDITIONING	HC HANDICAPPED; HOLLOW CORE	SC TILE CEILING
ACCU AIR CONDITIONING CONDENSER UNIT	HORIZ HORIZONTAL	SF SOLID CORE
ACPLAS ACOUSTICAL PLASTER	HM HOLLOW METAL	SH SQUARE FOOT; SUPPLY FAN
ACT ACOUSTIC CEILING TILE	HRU HEAT RECOVERY UNIT	SHT SHEET
AFF ABOVE FINISHED FLOOR	H&V HEATING AND VENTILATING	SIM SIMILAR
AGG AGGREGATE	HVAC HEATING, VENTILATING AND AIR CONDITIONING	SK SHEAR KEY
ALT ALTERNATE		SN SANITARY NAPKIN (DISPENSER)
AP ACCESS PANEL		SP SPECIAL
APROX APPROXIMATE	I INCLUDED ANGLE	SS STAINLESS STEEL
ARCH ARCHITECTURAL	ID INSIDE DIAMETER	STA STATION
	IF INSIDE FACE	STL STEEL
	IJ ISOLATION JOINT	STRUC STRUCTURAL
BCX BOTTOM CHORD EXTENSION	IMP IMPACT RESISTANT	
BD BOARD	INS INSULATED	
BIT BITUMINOUS	INV INVERT	
BLDG BUILDING		T TREAD
BLP BORROWED LIGHT PANEL		T&B TACKBOARD
BO BOTTOM OF	JS JOIST SUBSTITUTE	T&B TOP AND BOTTOM
BOF BOTTOM OF FOOTING		TBM TEMPORARY BENCHMARK
BOS BOTTOM OF STEEL	K KIPS	TCE TOP CHORD EXTENSION
BOT BOTTOM		TJ TIE JOIST
BRDG BRIDGING	L ANGLE; LENGTH	TO TOP OF
BRG BEARING	LF LEFT	TOC TOP OF CONCRETE
BS BOTH SIDES	LINO SHEET LINOLEUM	TOF TOP OF FOOTING
BSE BSBRICK SHELF ELEVATION	LL LIVE LOAD	TOM TOP OF MASONRY
	LLH LONG LEG HORIZONTAL	TOP TOP OF PIER
	LLV LONG LEG VERTICAL	TOS TOP OF STEEL; TOP OF SLAB
	LP LIGHTING PANEL; LIQUIFIED PROPANE	TOW TOP OF WALL
C CHANNEL		
CB CATCH BASIN; CHALKBOARD	MAX MAXIMUM	TP TOILET PAPER (DISPENSER); TEST PIT
CEM BD CEMENTITIOUS BACKER BOARD	MB MARKER BOARD	TS TUBE STEEL
CFM CUBIC FEET PER MINUTE	MDO MEDIUM DENSITY OVERLAY	TYP TYPICAL
CIP CAST IN PLACE	MECH MECHANICAL	
CJ CONTROL JOINT; CONSTRUCTION JOINT	MFR MANUFACTURER	UH UNIT HEATER
CL CENTER LINE	MIN MINIMUM	UNO UNLESS NOTED OTHERWISE
CLL CONTRACT LIMIT LINE	MISC MISCELLANEOUS	
CLR CLEAR	MRO MASONRY OPENING	V VENT PIPE; VERTICAL
CMU CONCRETE MASONRY UNIT	MR MAKE-UP AIR	VB VAPOR BARRIER
COL COLUMN		VCT VINYL COMPOSITION TILE
CONC CONCRETE		VERT VERTICAL
CONT CONTINUOUS		VP VISION PANEL
CT CERAMIC TILE	N NOSING	VTR VENT THROUGH THE ROOF
CUH CABINET UNIT HEATER	NOB NEW CATCH BASIN	
	NDMH NEW DRAIN MANHOLE	W/ WITH
D DIAMETER	NFM NEW FORCE MAINE	WC WATER CLOSET
DBL DOUBLE	NIC NOT IN CONTRACT	WF WIDE FLANGE
DF DRINKING FOUNTAIN	NS NEAR SIDE	WH WATER HEATER
DL DEAD LOAD	NSD NEW STORM DRAIN LINE	W/O WITHOUT
DR DISPLAY RAIL	NSS NEW SANITARY SEWER LINE	WP WORKING POINT
DTL DETAIL	NTS NOT TO SCALE	WS WEB STIFFENER
DW DISHWASHER	NW NEW WATER LINE	WWF WELDED WIRE FABRIC
DWG DRAWING		
EA EACH	OC ON CENTER	
EF EXHAUST FAN; EACH FACE	OF OUTSIDE FACE	
EJ EXPANSION JOINT	OH OVERHEAD	
EL ELEVATION		
ELEC ELECTRICAL	PA PUBLIC ADDRESS	
EOP EDGE OF PAVEMENT	PAF POWDER-ACTUATED FASTENER	
EPDM ETHYLENE PROPYLENE DIENE MONOMER	PDU POOL DEHUMIDIFICATION UNIT	
EQ EQUAL	PL PLATE; PROPERTY LINE	
EW EACH WAY	PLAM PLASTIC LAMINATE	
EWC ELECTRIC WATER COOLER	PLF POUNDS PER LINEAR FOOT	
EXIST EXISTING	PP POWER PANEL	
EXP EXPANSION	PSF POUNDS PER SQUARE FOOT	
EXT EXTERIOR	PSI POUNDS PER SQUARE INCH	
	PT PRESSURE-TREATED	
	PVC POLYVINYL CHLORIDE	
	PVMT PAVEMENT	
FB FLAT BAR		
FBD FURNISHED BY OTHERS	R RISER; RADIUS	
FCO FLOOR CLEAN-OUT	RB RESILIENT BASE	
FD FLOOR DRAIN	RD ROOF DRAIN	
FE FIRE EXTINGUISHER	REINF REINFORCED	
FF FINISHED FLOOR; FAR FACE	REQ'D REQUIRED	
FFE FINISHED FLOOR ELEVATION		
FO FRAMED OPENING	RT ROUGH OPENING	
FRP FIBERGLASS REINFORCED PLASTIC	RO ROUGH OPENING	
FS FAR SIDE	ROW RIGHT OF WAY	
FTG FOOTING	RR RUB-RAIL	
	RTU ROOFTOP UNIT (HVAC)	
GA GUAGE		
GALV GALVANIZED		
GB GRAB BAR		
GC GENERAL CONTRACTOR		
GDT GYPSUM DROP-IN TILE		
GV GRAVITY VENT		
GWB GYPSUM WALL BOARD		

LOCATION MAP:

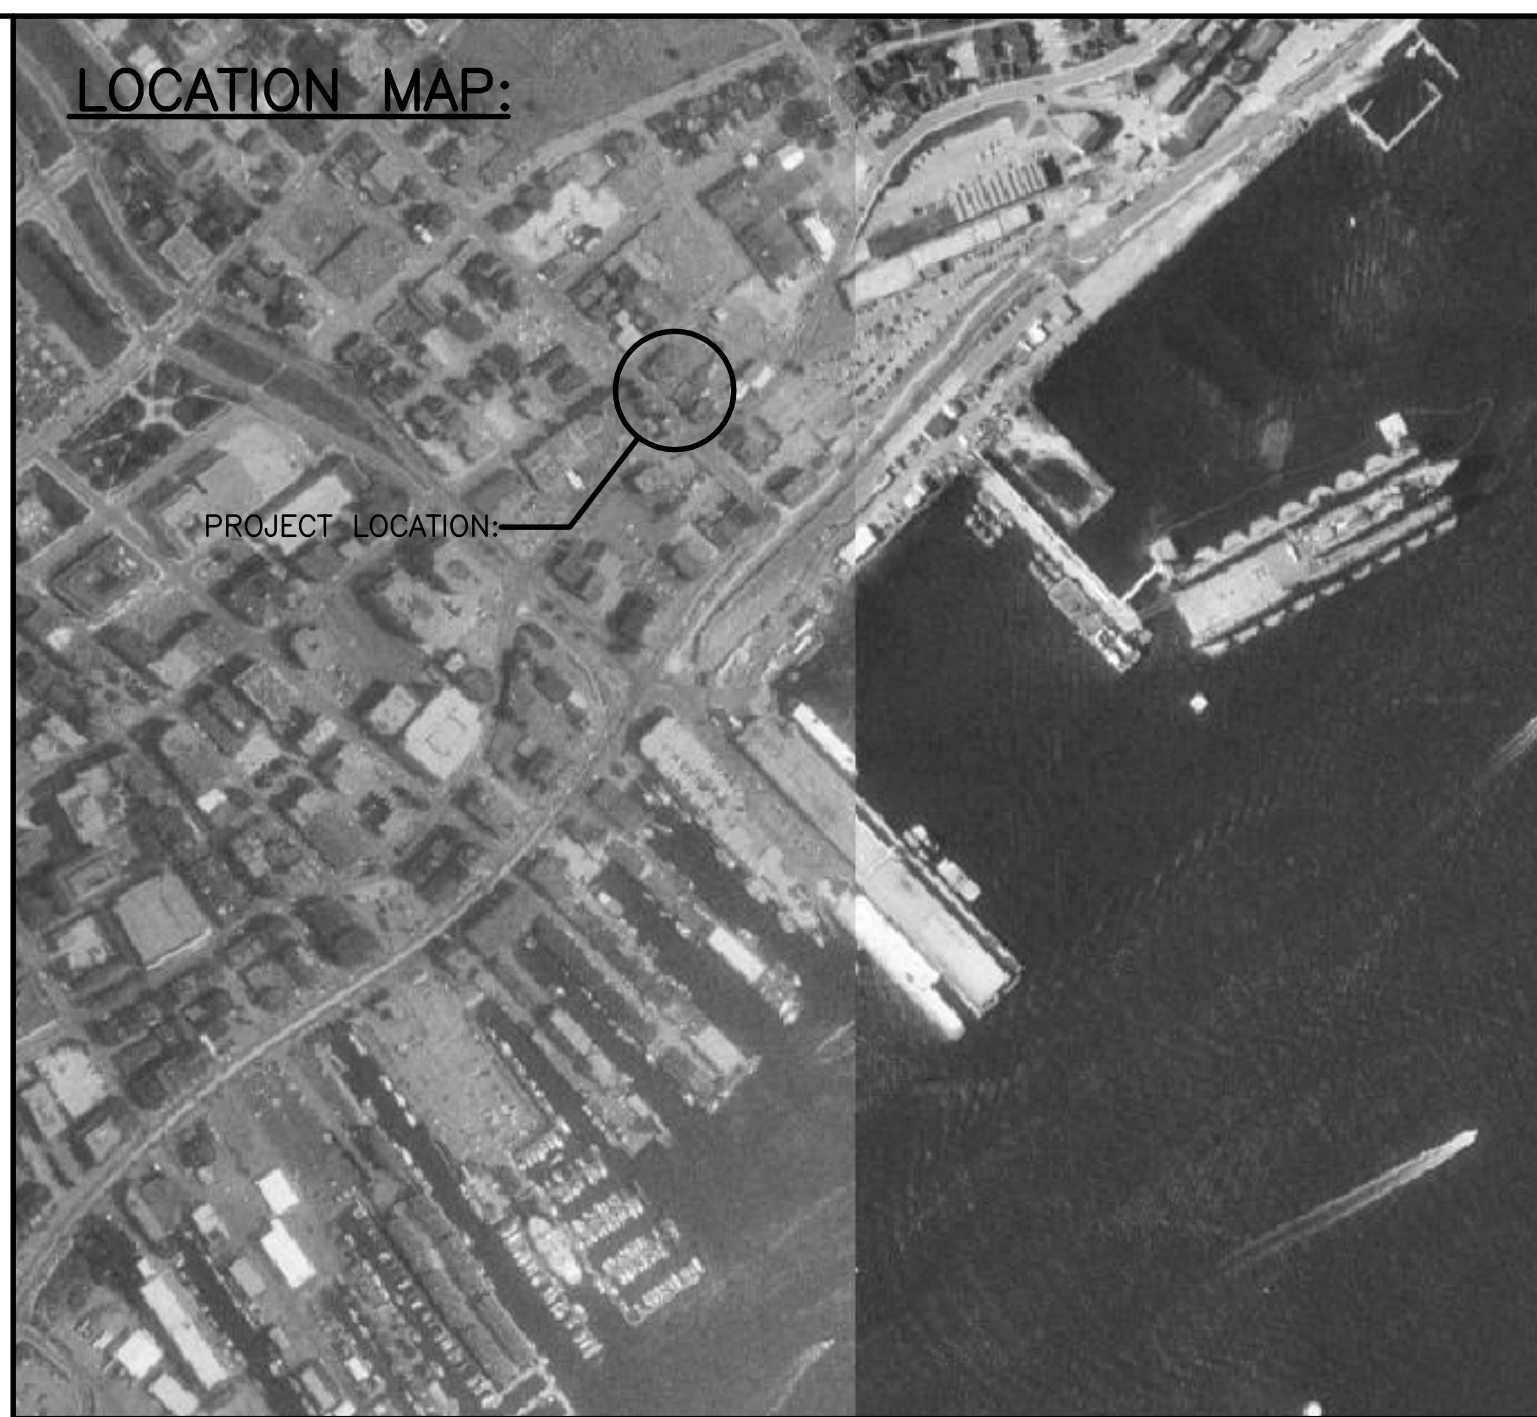

SYMBOL LEGEND:

	BUILDING SECTION
	WALL SECTION
	DETAIL
	EXTERIOR ELEVATION
	INTERIOR ELEVATION
	LEVEL LINE
	CIRCLE NOTE
	WINDOW TAG
	PARTITION TAG
	DOOR TAG
	ROOM NAME ROOM NUMBER
	COLUMN BUBBLE AND CENTER LINE
	BACKER ROD AND SEALANT

DRAWING LIST:

ARCHITECTURAL:	
G1001	COVER SHEET
G1002	GENERAL INFORMATION
AD101	DEMOLITION PLAN
AE101	FLOOR PLANS & LAYOUT PLANS
AE102	REFLECTED CEILING PLANS AND ROOF PLAN
AE201	EXTERIOR ELEVATIONS
AE301	WALL SECTIONS & DETAILS
AE401	ENLARGED STAIR PLANS AND SECTIONS
AE501	ROOF DETAILS
AE601	ROOM FINISH SCHEDULE, DOOR SCHEDULE & DETAILS
ELECTRICAL:	
E-001	LEGEND AND GENERAL NOTES
ED101	DEMOLITION PLANS
EL101	LIGHTING FLOOR PLANS
EP101	POWER FLOOR PLANS
EP601	ONE LINE DIAGRAMS AND PANEL SCHEDULES
EY101	SYSTEMS FLOOR PLANS

GRID NO.	TITLE
SCALE	REFERENCE SHEET

PROJECT TITLE: THE MILESTONE FOUNDATION
 INDIA STREET, PORTLAND
 CURRENT ISSUE STATUS: ISSUED FOR CONSTRUCTION 4-17-03

REV	DESCRIPTION	DATE
0	ISSUED FOR CONSTRUCTION	4-17-03

GRAPHIC SCALE: 0" 1"
 SCALE: 1/8"=1'-0"
 PROJECT MANAGER: JLH
 JC/DRAWN BY: RIL
 A/E OF RECORD: JLH
 SMRT CAD FILE: G1001-03017
 PROJECT NO: 03017
 DATE: 4-17-03

SHEET TITLE: COVER SHEET
 SHEET No. G1001