\Box

DIMENSIONAL CLARIFICATION IS NEEDED DUE TO SCALE

DRAWINGS. G.C. TO ENSURE OPENINGS ARE LOCATED IN SUCH A MANNER AS NOT TO INTERFERE WITH THE

2. TOP OF FIFTH FLOOR SHEATHING IS AT 134'-9".

4. COORDINATE FLOOR OPENINGS WITH PLUMBING

6. TYPICAL WOOD POSTS SHOWN IN FRAMED WALLS SHALL BE TRIPLE STUD POSTS. PROVIDE (3) 2X6 POST

7. FASTEN STAIR STRINGERS TO STAIR WALLS WITH (2)

8. FLOOR TRUSSES AND WALL STUDS ALIGN THROUGHOUT

ALTERED FOR PLUMBING, PROVIDE WALL STUDS BENEATH

JEFFREY

S. NAWROCKI No. 6044

1/4" DIAMETER LAG SCREWS INTO STUDS AT 48" O.C. (EVERY OTHER STUD). PROVIDE 2" PENETRATION INTO

THIS PROJECT. WHERE FLOOR TRUSS SPACING IS

IN 2X6 WALLS AND (3) 2X4 POST IN 2X4 WALLS.

5. VERIFY STAIR OPENING DIMENSIONS WITH

BEARING WALLS OR FLOOR TRUSSES.

ARCHITECTURAL DRAWINGS (TYP.).

3. SEE SHEETS SN.O AND SN.I FOR ADDITIONAL

OF DRAWINGS.

WALL STUDS.

EACH TRUSS.


STRUCTURAL NOTES.

FTH FLOOR FRA, 195, 2008

REVISIONS:

DRG. NO.

54.0

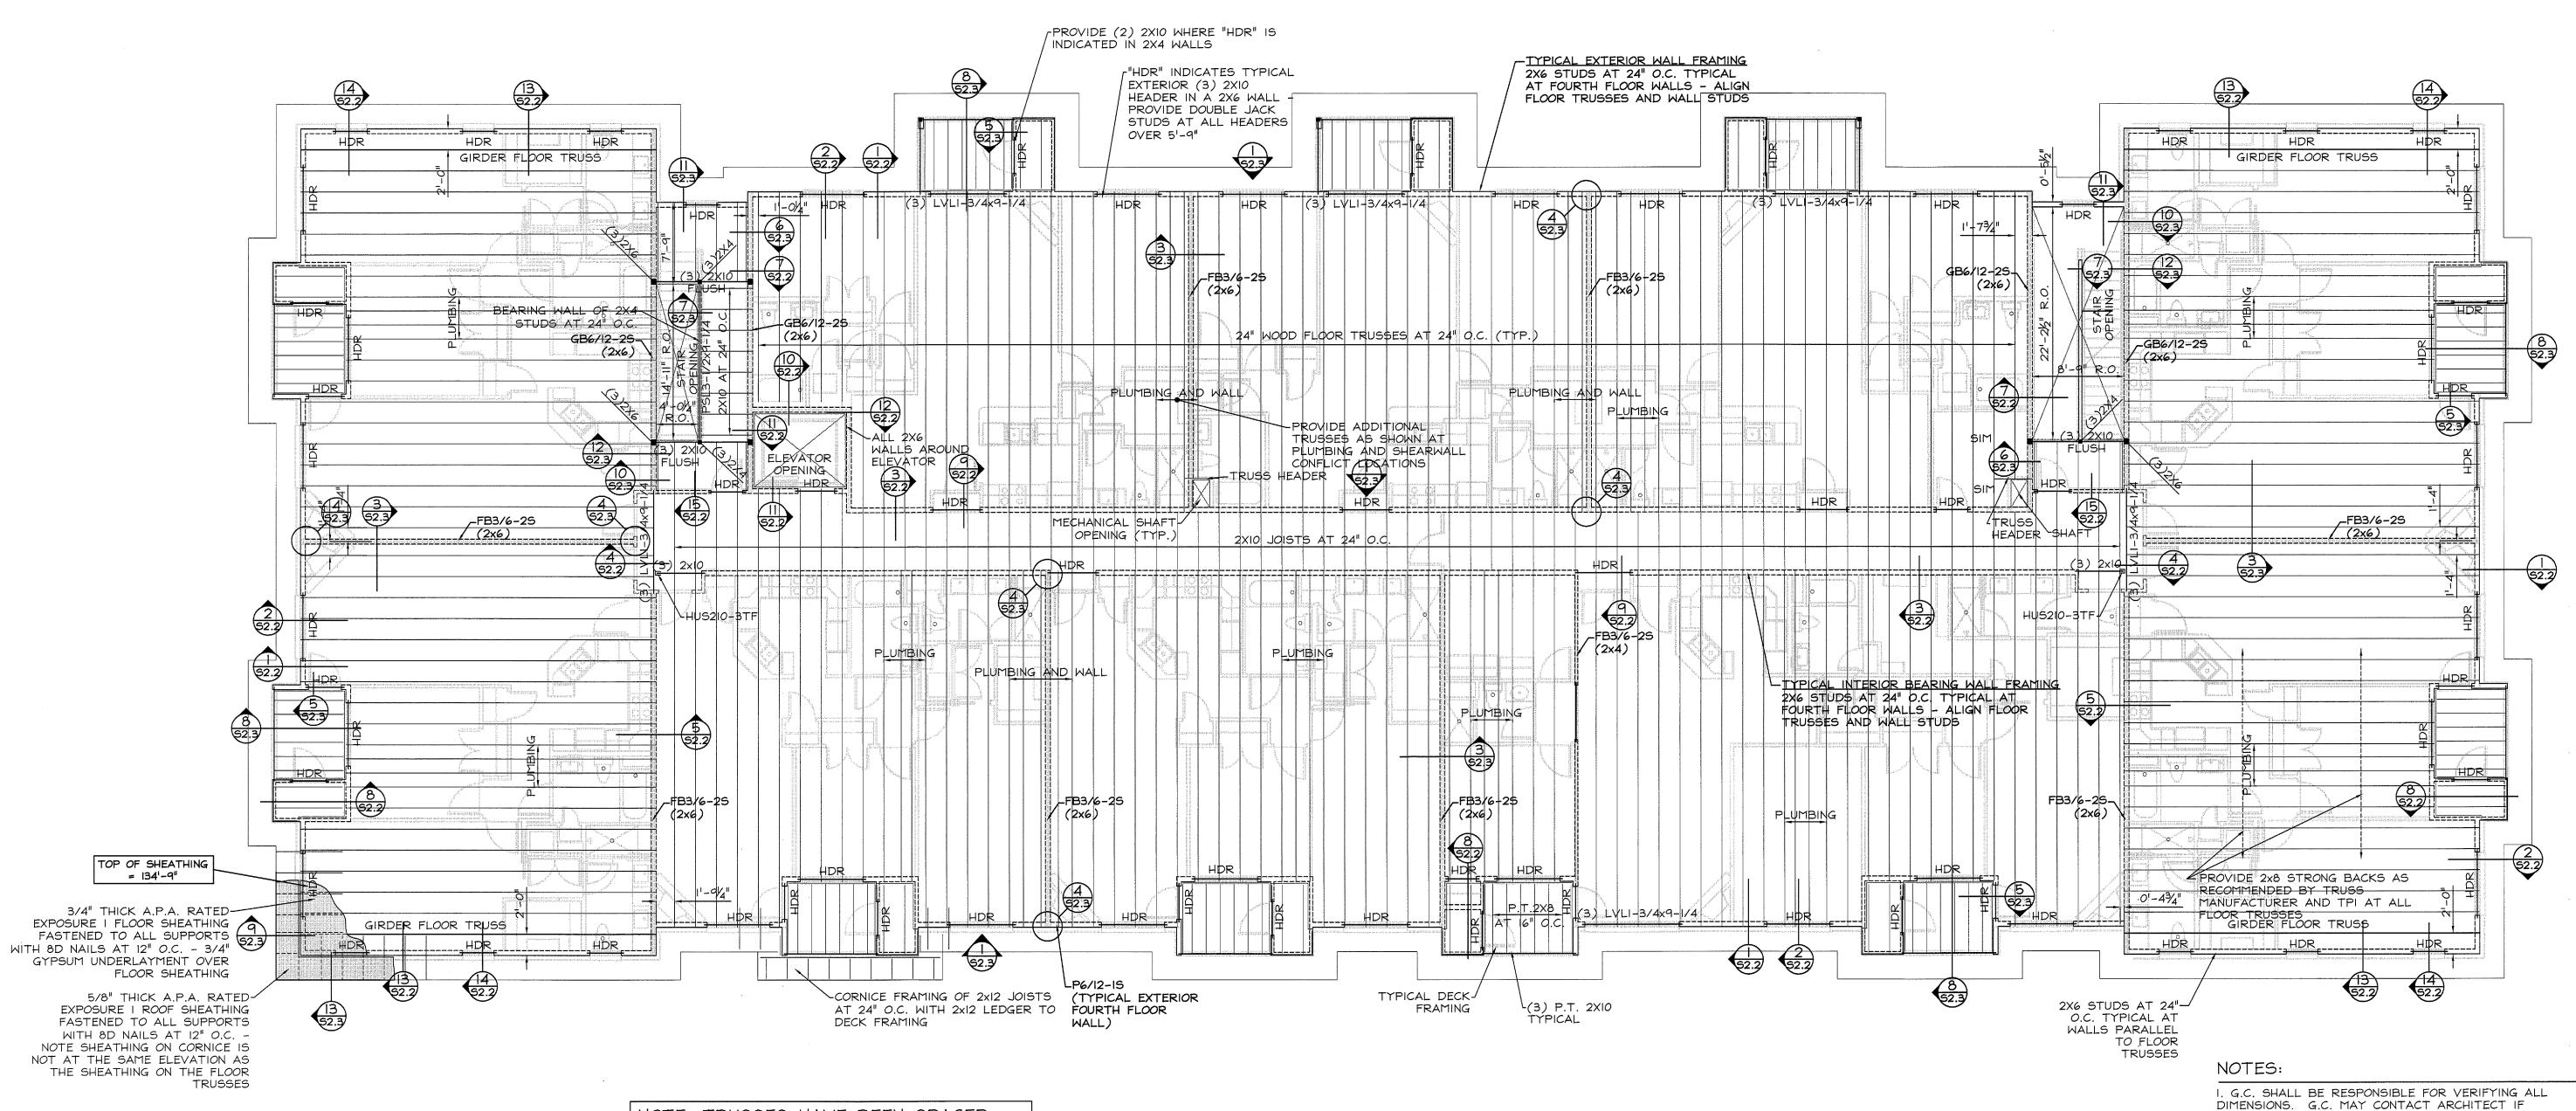

NOTE: FLOOR TRUSSES AND WALL STUDS MUST ALIGN FOR FULL HEIGHT OF BUILDING - DO NOT OFFSET FLOOR TRUSSES OR STUDS FROM FRAMING ABOVE OR BELOW

STRUCTURAL.

NOTE: TRUSSES HAVE BEEN SPACED
TO AVOID PLUMBING CONFLICTS TRUSS MANUFACTURER SHALL ENSURE
COORDINATION OF TRUSS LAYOUT WITH
FINAL PLUMBING DESIGN

SCHEDULE OF SHEAR WALL CONSTRUCTION	
DESIGNATION	SHEATHING AND FASTENING
GB6/12-25 (SEE ARCHITECTURAL DRAWINGS)	2" LAMINATED GYPSUM ASSEMBLY ONE SIDE, NO.6 SCREWS AT 6/12, BLOCKED (2) LAYERS 5/8" GYP. WALLBOARD OTHER SIDE, SCREWS AT 6/12, BLOCKED
FB4/6-25	FIBERBOARD WALL SHEATHING ON TWO SIDES, 8D NAILS AT 4/6, BLOCKED
FB3/6-25	FIBERBOARD WALL SHEATHING ON TWO SIDES, 8D NAILS AT 3/6, BLOCKED
P4/I2-I5	WOOD SHEATHING ONE SIDE WITH 10D NAILS AT 4/12, BLOCKED
P6/12-25	WOOD SHEATHING TWO SIDES WITH 10D NAILS AT 6/12, BLOCKED
P6/12-15 (TYP. EXT. WALL, U.N.O.)	WOOD SHEATHING ONE SIDE WITH 10D NAILS AT 6/12, BLOCKED

- FASTENER PATTERN SHALL BE REPRESENTED AS "SPACING OF FASTENERS AT THE PERIMETER OF THE PANEL"/"SPACING OF FASTENERS IN THE FIELD OF THE PANEL"
- GYPSUM WALLBOARD SHALL BE FASTENED IN PATTERN WITH NO. 6 SCREWS (TYPE S OR W) WITH LENGTH SUFFICIENT TO PROVIDE MINIMUM I"
EMBEDMENT INTO WOOD FRAMING AT 1/2", 5/8", AND I" THICKNESSES
- "BLOCKED" SHALL INDICATE THAT ALL EDGES OF THE APPLIED SHEATHING MUST BE BLOCKED AND FASTENED PER THE FASTENER SPACING

INDICATED

- WOOD SHEATHING SHALL BE 15/32" A.P.A. RATED EXPOSURE I PLYWOOD OR OSB SHEATHING. TYPICAL FASTENING OF WOOD SHEATHING SHALL BE MINIMUM IOD NAILS AT FASTENED 6" ON CENTER AT ALL EDGES (BLOCKED) AND 12" ON CENTER IN THE FIELD OF THE PANEL TO ALL SUPPORTS, UNLESS NOTED OTHERWISE.

- SEE DETAIL 12/SI.4 FOR FASTENING OF BOTTOM PLATES OF SHEAR WALL TO SECOND FLOOR SLAB
- SEE SHEETS 52.3 AND S5.2 FOR SHEAR WALL FASTENING DETAILS AT WOOD FRAMED FLOOR LOCATIONS AND ROOF LOCATIONS, RESPECTIVELY.

- INTERIOR WALL SHEATHING SHALL BE 1/2" THICK STRUCTURAL FIBERBOARD WALL SHEATHING SATISFYING ASTM C 208, TYPE IV, GRADE 2,

FIFTH FLOOR FRAMING PLAN

- BUILDING I

S4.0 Scale: 1/8" = 1'

NOTE: CORNICE I

NOTE: CORNICE DETAIL IS AT FULL PERIMETER OF FIFTH FLOOR FRAMING - SEE 13/S2.3 AND 14/S2.3