

20-C-9 127 Fore Street Residence Inn Novwich Partners, U.C.

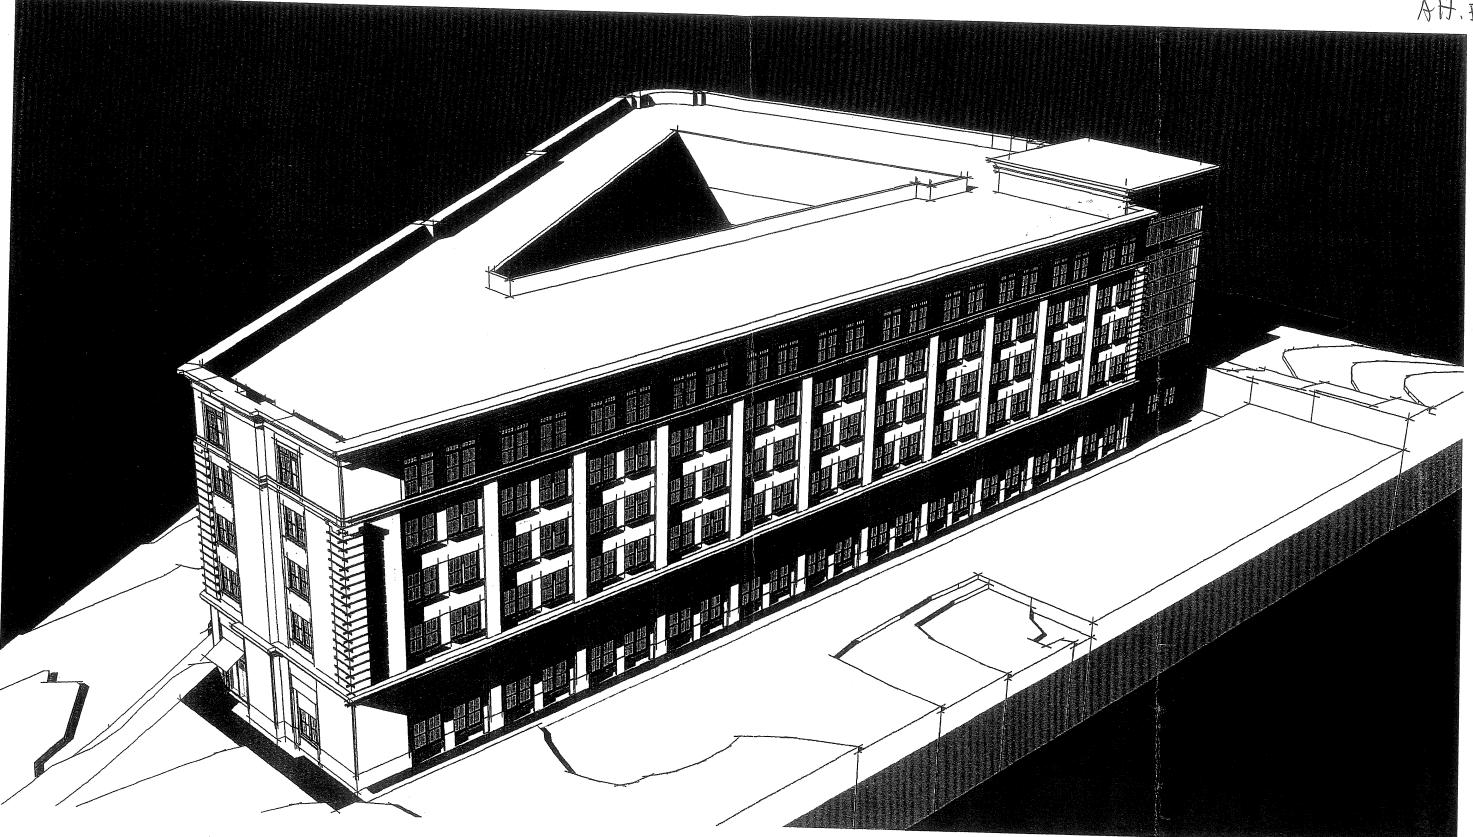



REAR PERSPECTIVE


Group One Partners, Incorporated
21 West Third Street
Boston, MA 02127
617.268.7000 ph
617.268.0209 f
www.grouponeinc.com

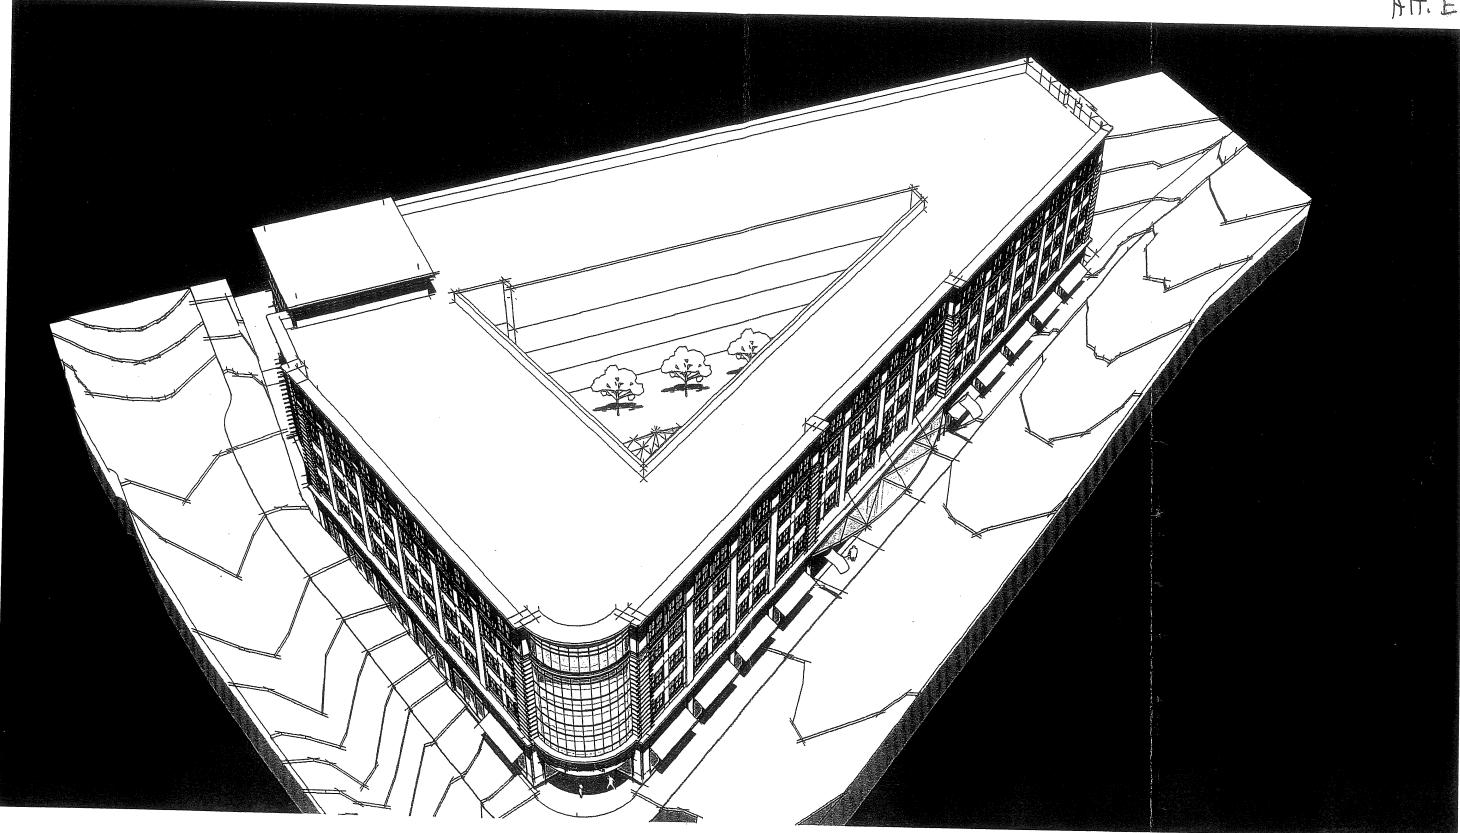



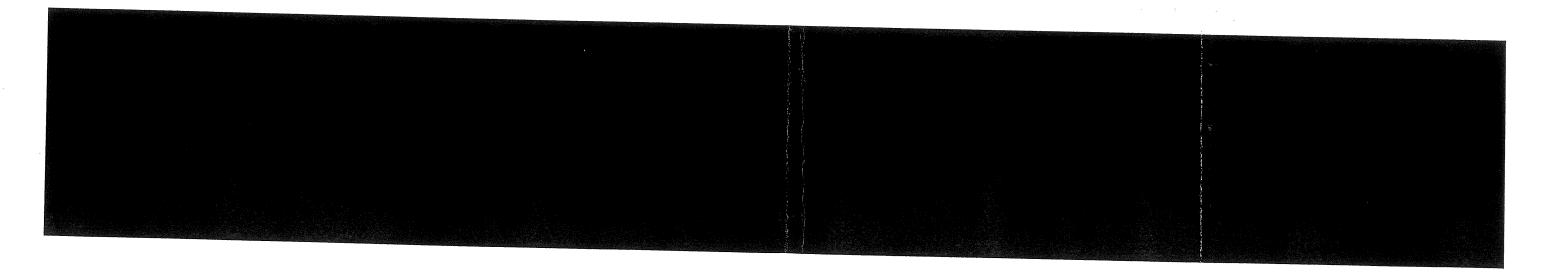

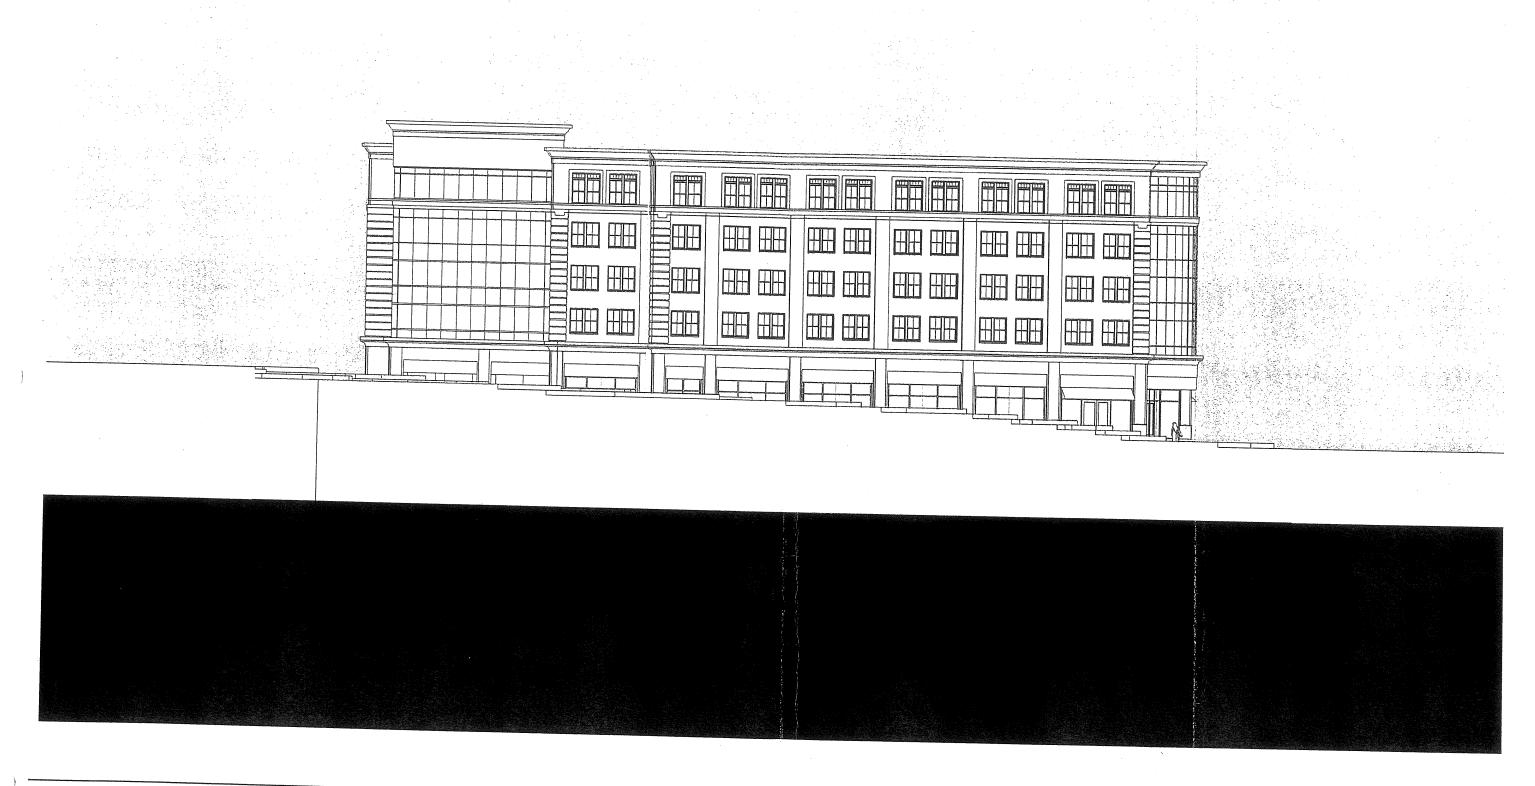

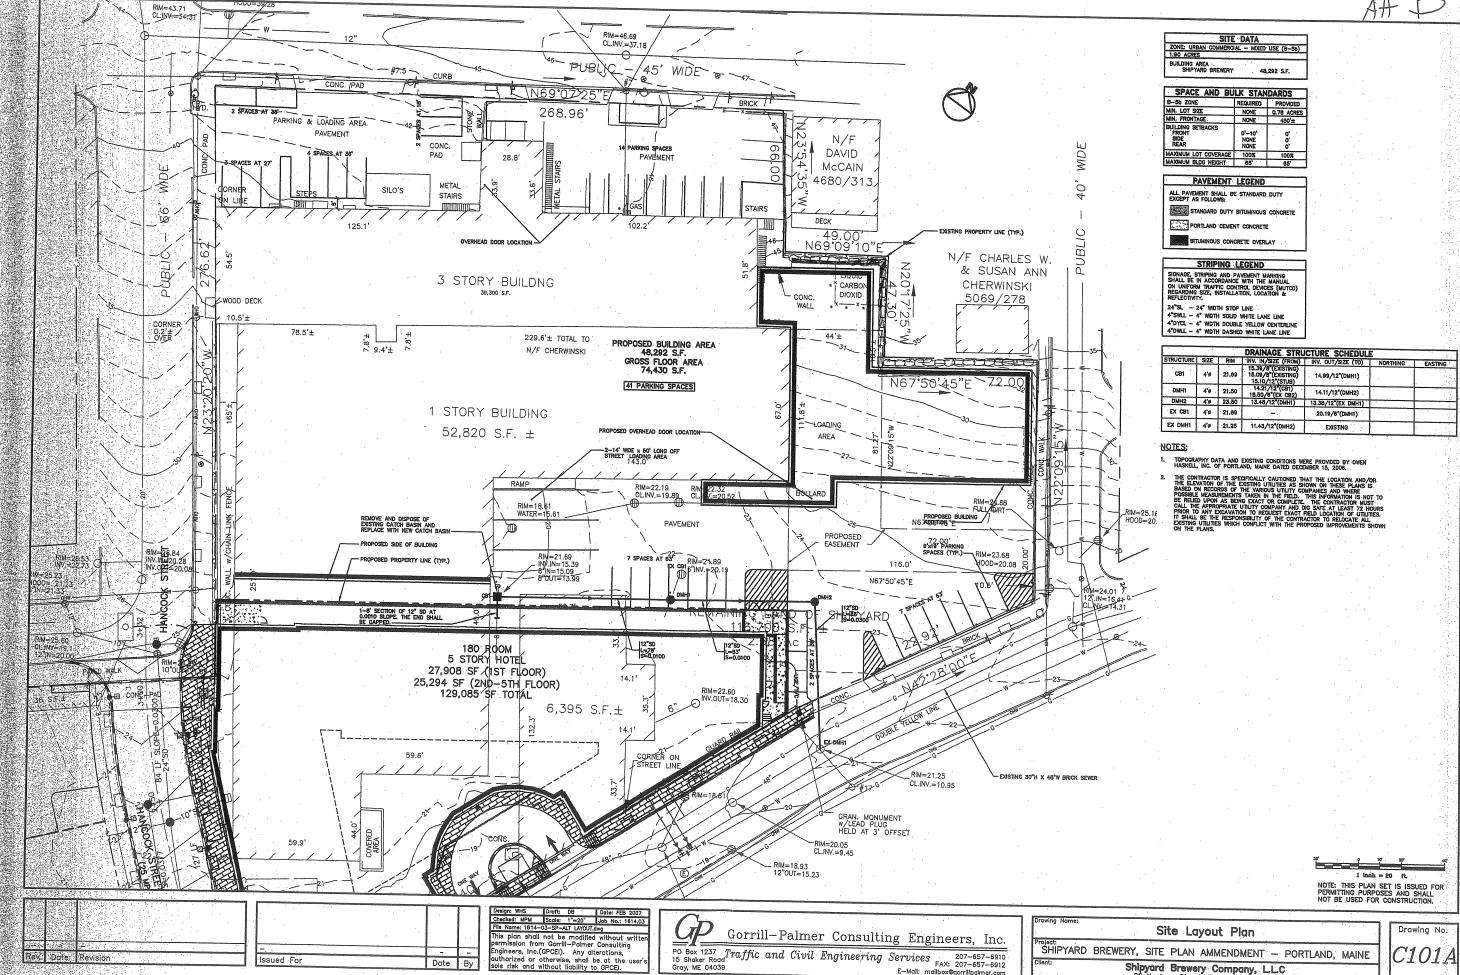

C101A

Shipyard Brewery Company, L.L.C. 86 Newbury Street, Portland, ME 04101



FORE STREET PERSPECTIVE




FORE STREET PERSPECTIVE

light grey = (30% reflectively)

FOINT A: 0.8 X 0.5 = 0.4 +1

Part 10: 0.8 × 2.6 = 2.06 fl

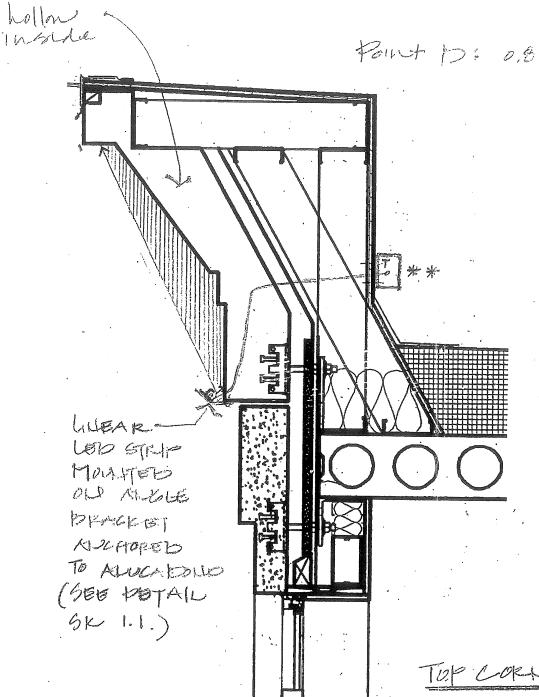

TRANSFORMER TO DO LOCATED EVARY 50'-0" IN CONCEALED DUT ACCESSIBLE LOCATION (BEHIND PARAPET)

TOP CORNICE DETAIL


1216 Arch Street Suite 3A Philadelphia, PA 19107 209 Philadelphia Avenue Egg Harbor City, NJ 08215 p 888.233.2662 27 West 24th Street Suite 507 New York, NY 10011 p 212.645.6040

RESIDENCE INT

HARRIOTT 04.16.07 BK

1.0

04.19.01

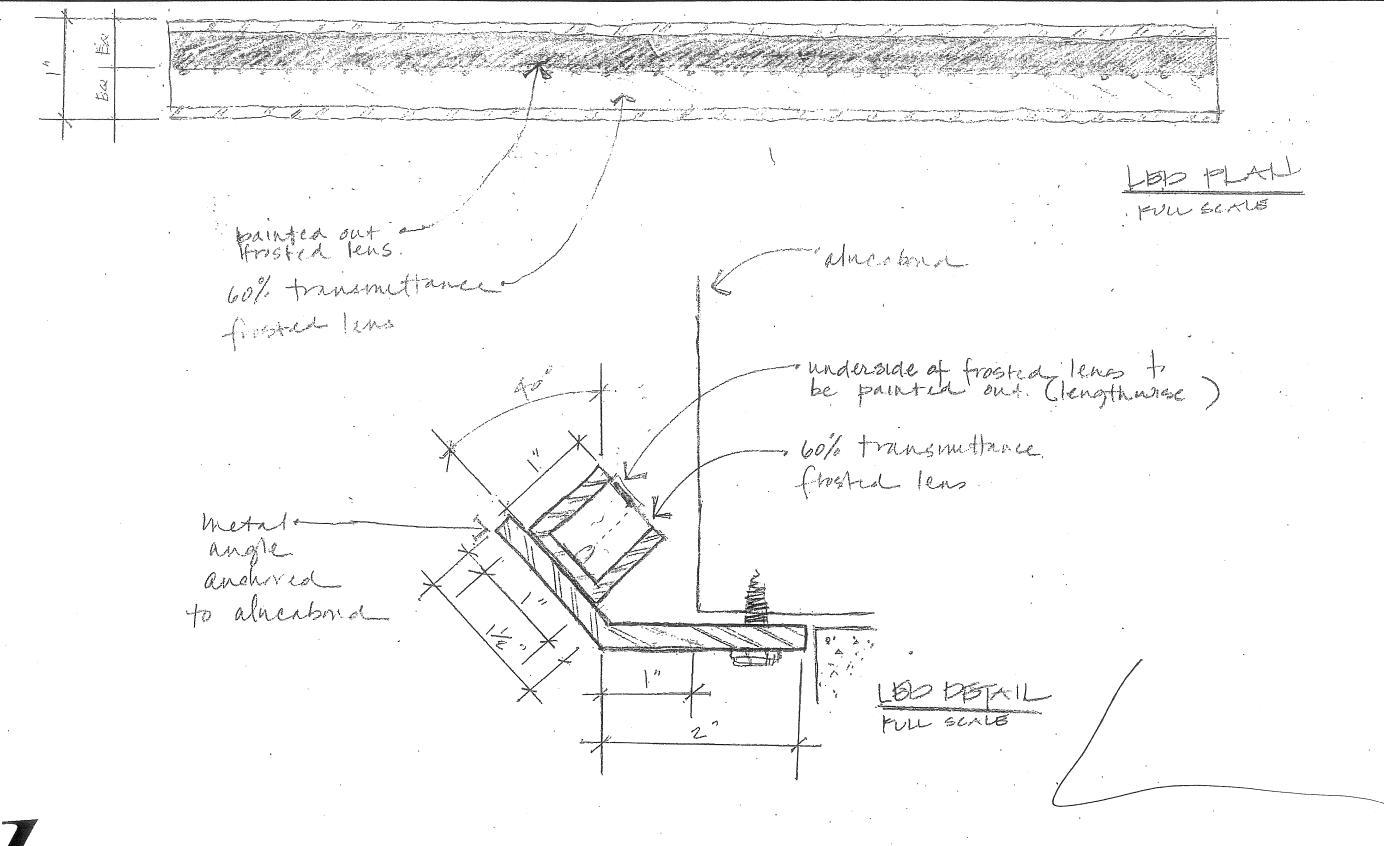


1216 Arch Street Suite 3A Philadelphia, PA 19107 209 Philadelphia Avenue Egg Harbor City, NJ 08215 p 888.233.2662 27 West 24th Street Suite 507 New York, NY 10011 p 212.645.6040

p 215,569,2115

FROIDPITCE INTO 4.12.07 HARRIOTT


04.16.01 CK

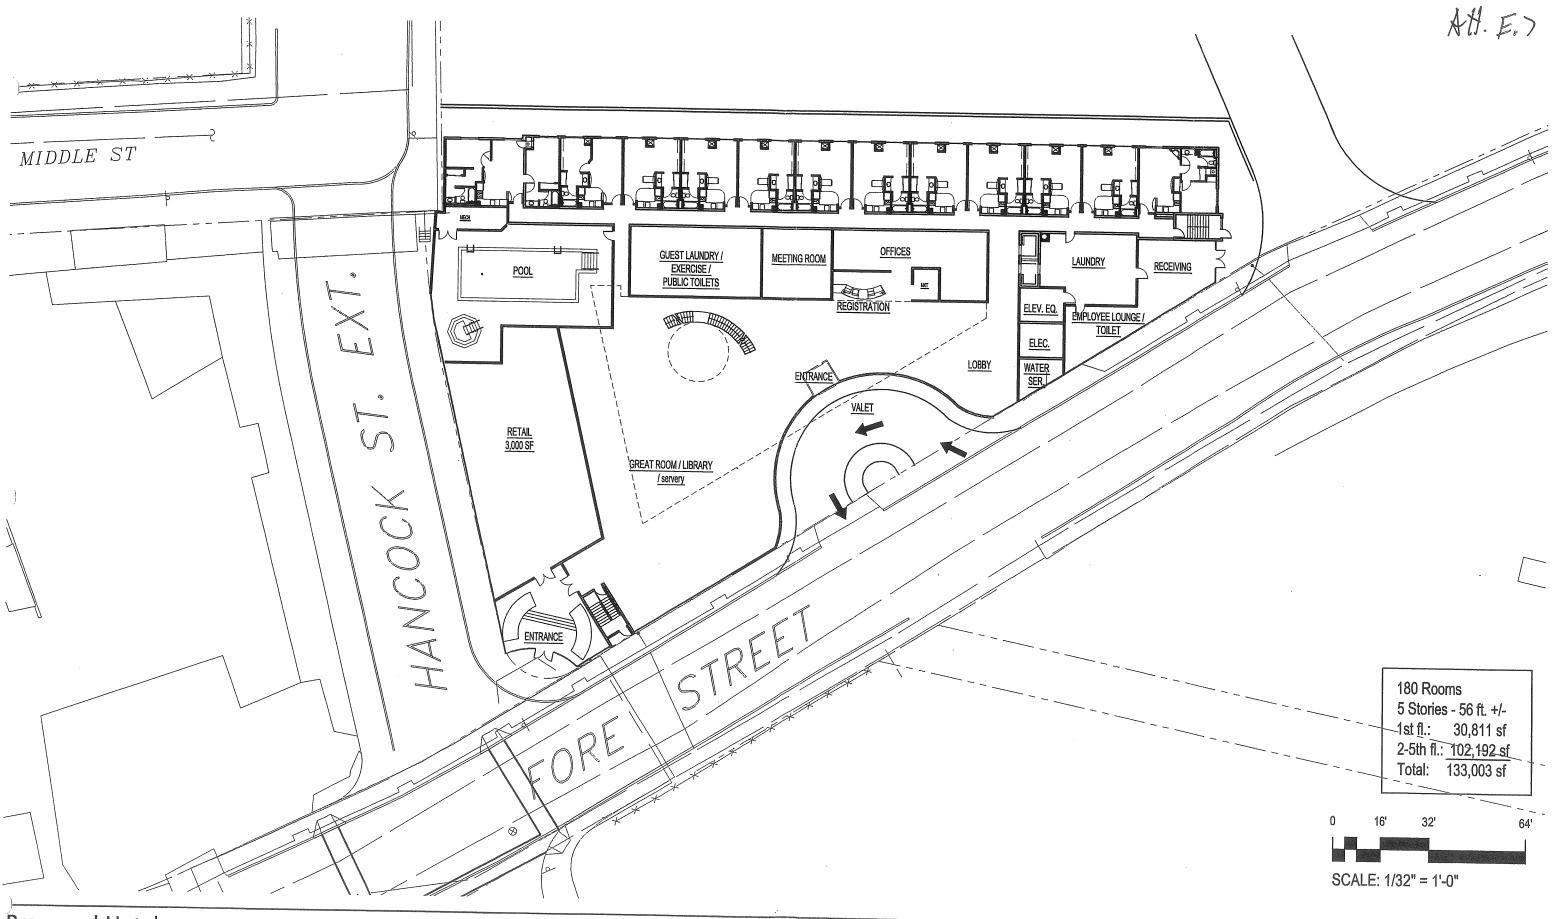

GROUND FLOOR PLAN

Group One Partners, Incorporated


21 West Third Street
Boston, MA 02127
617.268.7000 ph
617.268.0209 f

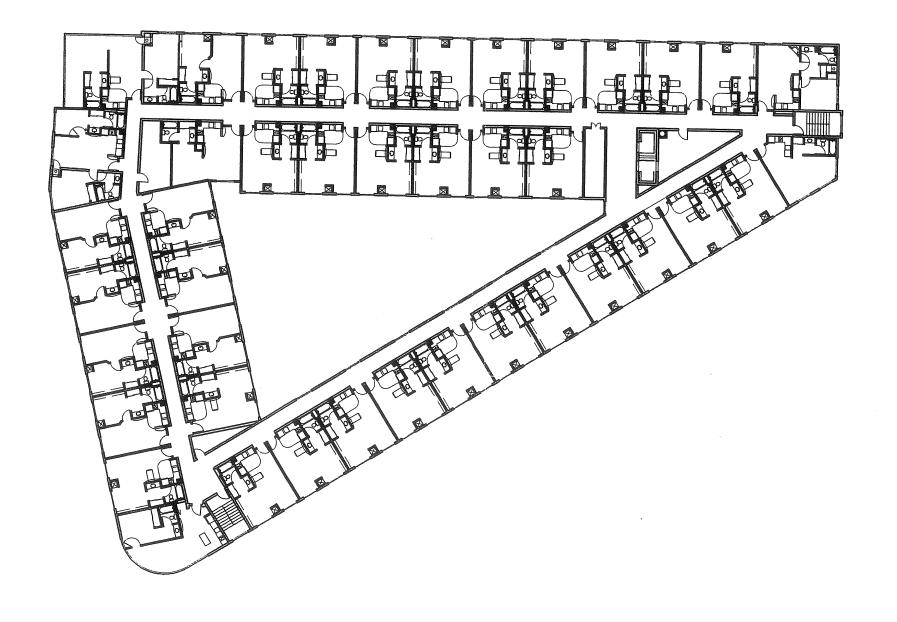

180 Rooms


5 Stories - 56 ft. +/-


1st fl.: 30,811 sf 2-5th fl.: 102,192 sf Total: 133,003 sf

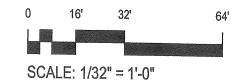





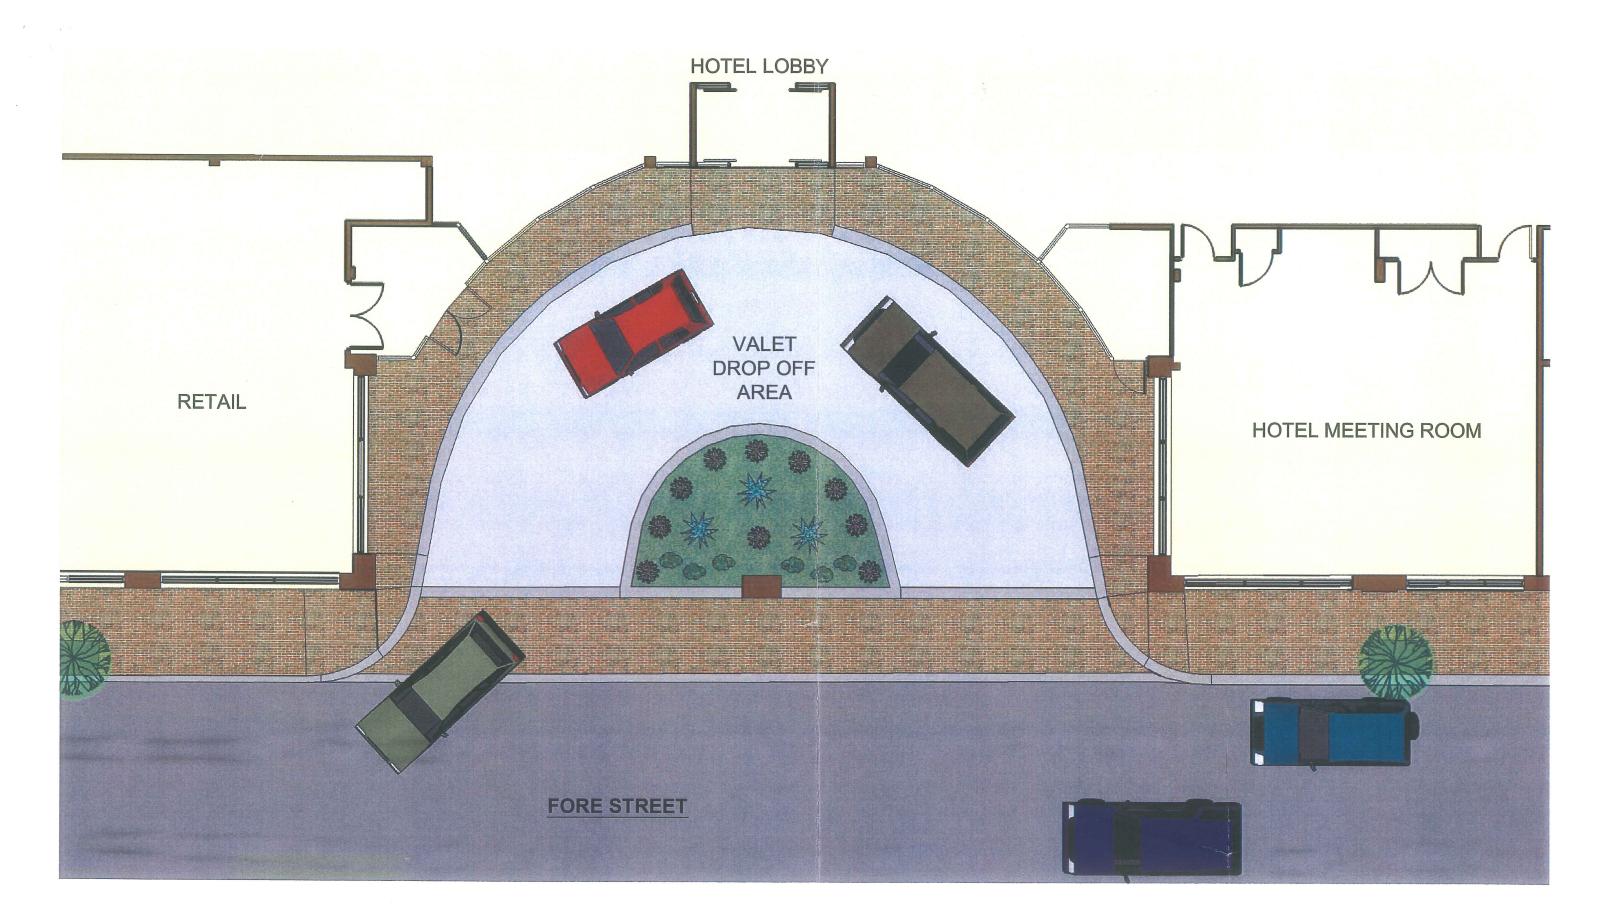

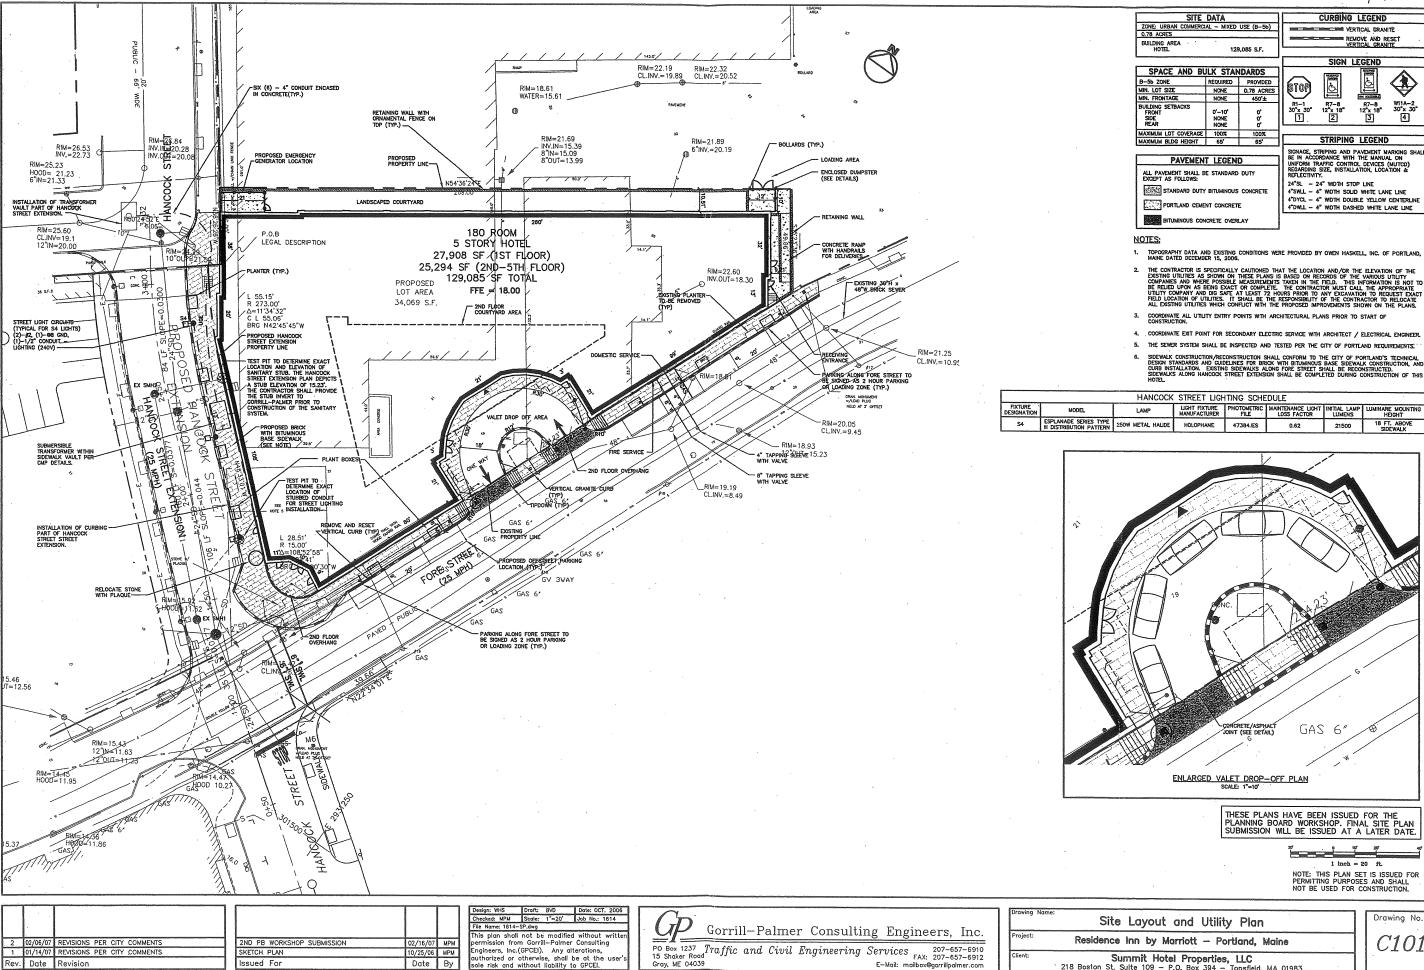

1 01/14/07 REVISIONS PER CITY COMMENTS

Rev. Date Revision

SKETCH PLAN

Issued For

MPM


Date By

authorized or otherwise, shall be at the use sole risk and without liability to GPCEI.

C101

Summit Hotel Properties, LLC 218 Boston St. Suite 109 — P.O. Box 394 — Topsfield, MA 01983

Summit Hotel Properties, LLC 218 Boston St. Suite 109 - P.O. Box 394 - Topsfield, MA 01983

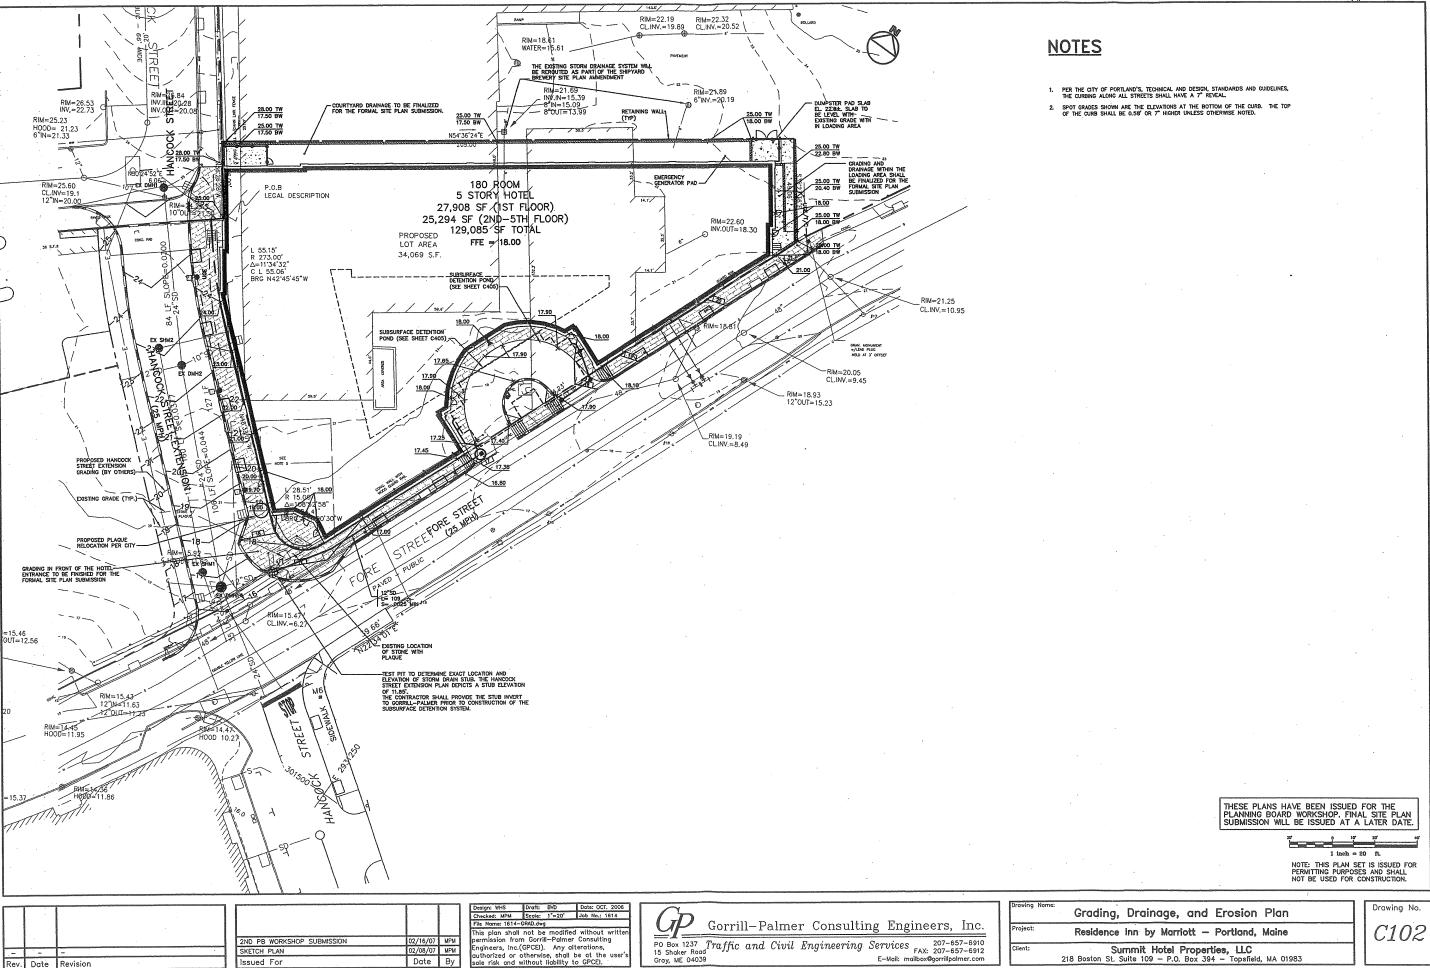

Engineers, Inc.(GPCEI). Any alterations, authorized or otherwise, shall be at the user sole risk and without liability to GPCEI.

02/08/07 MPM Date By

Rev. Date Revision

STORMTECH PRODUCT SPECIFICATIONS

- GENERAL
 STORMITCH CHAMBERS ARE DESIGNED TO CONTROL
 STORMATCH RUNDER. AS A SUBSURFACE RETENTION
 SYSTEM, STORMITCH CHAMBERS RETAIN AND ALLOW
 EFFECTIVE INFILTRATION OF WATER INTO THE SOIL. AS
 A SUBSURFACE DETENTION SYSTEM, STORMITCH
 CHAMBERS DETAIN AND ALLOW FOR THE METERED
 FLOW OF WATER TO AN OUTFACT OR AN OUTFACE
- 2.0 CHAMBER PARAMETERS
 2.1 THE CHAMBER SHALL BE INJECTION MOLDED OF
 2.1 THE CHAMBER SHALL BE INJECTION MOLDED OF
 2.2 THE CHAMBER SHALL BE INJECTION MOLDED OF
 2.2 THE CHAMBER SHALL BE INJECTION MOLDED OF
 2.2 THE CHAMBER SHALL BE INJECTION OF
 2. THE CHAMBER SHALL BE INJECTED OF
 2. THE
- 22 THE NOMINAL CHAMBER DIMENSIONS OF THE STORNITECH SC-740 SHALL BE 9.0 IN DICHES TALL 51.0 INCHES WIDE AND BOT INCHES IONG. THE KNOMINAL CHAMBER DIMENSIONS OF THE STORNITECH SC-310 SHAME OF THE STORNITECH DE THE STORNITECH SC-310 SHAME OF THE STALL BE DENOTH OF A JONED CHAMBER SHALL BE 85.4 INCHES.
- 2.3 THE CHAMBER SHALL HAVE A CONTINUOUSLY CURVED SECTION PROFILE.
- 2.4 THE CHAMBER SHALL BE OPEN-BOTTOMED.
- 25 THE CHAMBER SHALL INCORPORATE AN OVERLAPPING CORRUGATION JOINT SYSTEM TO ALLOW CHAMBER ROWS OF ALMOST ANY LEWGHT TO BE CREAPED. THE OVERLAPPING CORRUGATION JOINT SYSTEM SHALL BE EFFECTIVE WHILE ALLOWING CHAMBER TO BE TRIMMED TO SHORTEN ITS OVERALL LENGTH.
- THE MOMINAL STORAGE VOLUME OF A JOINED STORMTECH SC-740 CHANGER SHALL BE 749 CUBIC FEET PER CHANGER WHAT IS THE THE STORMTECH SC-740 CHANGER SHALL BE 749 CUBIC FEET PER CHANGER WHEN INSTALLED PER STORMTECH STYPICAL FEATURE (MCLUMES THE WOLUME OF CHUSHED ANGULAR STONE WITH AN ASSEMBLY STORAGESCAULAR FOOT OF FEED THE MOMINAL STORAGE VOLUME OF AN INSTALLED STORAGESCAULAR FOOT OF FEET PER CHANGER WHEN INSTALLED PER STORMTECH SC-710 CHANGER SHALL BE 750 CHIEFOL STORAGE S

- 2.8 THE CHAMBER SHALL HAVE TWO ORIFICES NEAR ITS TOP TO ALLOW FOR EQUALIZATION OF AIR PRESSURE BETWEEN ITS INTERIOR AND EXTERIOR.
- 2.9 THE CHAMBER SHALL HAVE BOTH OF ITS ENDS OPEN TO ALLOW FOR UNIMPEDED HYDRAULIC FLOWS AND VISUAL INSPECTIONS DOWN A ROW'S ENTIRE LENGTH.
- 2.11 THE CHAMBER SHALL HAVE A CIRCULAR, INDENTED, FLAT SURFACE ON THE TOP OF THE CHAMBER FOR AN OPTIONAL 4-INCH INSPECTION PORT OR CLEAN-OUT.
- 2.13 THE CHAMBER SHALL BE MANUFACTURED IN AN ISO 9001:2000 CERTIFIED FACILITY.
- 3.0 END CAP PARAMETERS
 3.1 THE END CAP SHALL BE INJECTION MOLDED OF POLYPPOPUREN RESIN TO BE INHERENTLY RESISTANT TO ENMICONNENTIAL STRESS CRECONING, AND TO MANTAN ADEQUATE STRENESS THROUGH HIGHER TEMPERATURES EXPERIENCED DURING INSTALLATION AND SERVICE.
- 32 THE END CAP SHALL BE DESIGNED TO FIT INTO ANY CORRUGATION OF A CHAMBER, WHICH ALLOWS: . CAPPING A CHAMBER THAT HAS ITS LENGTH TRIMMED; 35 SEGMENTING ROWS INTO STORAGE BASINS OF VARIOUS LENGTHS.
- THE END CAP SHALL HAVE SAW GUIDES TO ALLOW EAS' CUTTING FOR VARIOUS DIAMETERS OF PIPE THAT MAY BE USED TO INLET THE SYSTEM.
- THE END CAP SHALL HAVE EXCESS STRUCTURAL ADEQUACIES TO ALLOW CUTTING AN ORIFICE OF ANY SIZE AT ANY INVERT ELEVATION.
- THE PRIMARY FACE OF AN END CAP SHALL BE CURVED OUTWARD TO RESIST HORIZONTAL LOADS GENERATED NEAR THE EDGES OF BEDS.


STORMTECH GENERAL NOTES

- STORMTECH LLC ("STORMTECH") REQUIRES INSTALLING CONTRACTORS TO USE AND UNDERSTAND STORMTECHS LATEST INSTALLATION INSTRUCTIONS PRIOR TO BEGINNING SYSTEM INSTALLATION.
- SYSTEM INSTALLATION.

 2 OUR TECHNICAL SERVICES DEPARTMENT OFFERS INSTALLATION CONSULTATIONS TO INSTALLATION CONTRACTORS. C
- 3. STORMTECHS REQUIREMENTS FOR SYSTEMS WITH PAYEMENT DESIGN (ASPHALT, CONCRETE PAYERS, ETC.): MINIMUM COVER 18 IS INCHES NOT INCLUDIOR PAYEMENT; MAXIMUM COVER 18 SI INCHES INCLUDIONS PAYEMENT, FOR INSTILLATIONS THAT DO NOT INCLUDE PAYEMENT, WHERE RUTTING FROM YEHCLES MAY TOCKY, MINIMUM REQUIRE! COVER 15 24 INCHES, MAXIMUM COVER 15 SO ROME.
- 4. THE CONTRACTOR MUST REPORT ANY DISCREPANCIES WITH CHAMBER FOUNDATION MATERIALS BEARING CAPACITIES TO THE DESIGN ENGINEER.
- AASHTO M288 CLASS 2 NON-WOVEN GEOTEXTILE (FILTER FABRIC) MUST BE USED AS INDICATED IN THE PROJECT PLANS.

- 6. STONE PLACEMENT BETWEEN CHAMBERS ROWS AND AROUND PERIMETER MUST FOLLOW INSTRUCTIONS AS INDICATED IN THE MOST CURRENT VERSION OF STORMTECH'S INSTALLATION INSTRUCTIONS.
- 8. THE CONTRICTOR MUST REFER TO STORMTECHS
 INSTALLATION INSTRUCTIONS FOR A TABLE OF
 ACCEPTABLE REFLICE LOOKS AT VARIOUS DEPTHS OF
 ACCEPTABLE REFLICE LOOKS AT VARIOUS DEPTHS OF
 ACCEPTABLE REFLICE LOOKS AT VARIOUS DEPTHS OF
 ACCEPTABLE REFLICE WITH STORMTECH COON. THE
 CONTRICTOR IN SESPONSIBLE FOR PREVENTING
 VEHICLES THAT EXCEDE STORMTECHS REQUIREMENTS
 FROM TRAVELINIS ACROSS OR PARKING OVER THE
 STORMANTER SYSTEM. LEMPORARY FERDING, WARNING
 THE AND APPROPRIATELY LOCATED SIGNS ARE
 COMMON VISED TO PREVENT I MAINTINGER DEFICILES.
- THE CONTRACTOR MUST APPLY EROSION AND SEDIMENT CONTROL MEASURES TO PROTECT THE STORMWATER SYSTEM DURING ALL PHASES OF SITE CONSTRUCTION PER LOCAL CODES AND DESIGN ENGINEER'S SPECIFICATIONS.
- 10. STORMTECH PRODUCT WARRANTY IS LIMITED. SEE CURRENT PRODUCT WARRANTY FOR DETAILS. TO ACQUIRE A COPY CALL STORMTECH AT 1-888-992-2694 OR VISIT WWW.STORMTECH.COM.

SUBSURFACE DETENTION SYSTEMS MAY BE SUBSTITUTED WITH AN ENGINEER APPROVED EQUAL WHICH PROVIDES EQUAL DETENTION STORAGE AND WATER QUALITY TREATMENT

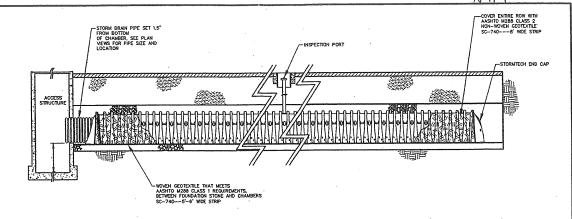

CHAMBER ISOLATOR ROW

N.T.S.

				ELEVATION	N]
•	BACKFILL TO BOTTOM OF PAVEMENT SECTION WITH SELECT BACKFILL	POND	A*	В	С	D	
SC-740 END CAP	THE SUBSURFACE DETENTION POND	1	12.15	12.65	15.15	15.50]
SC-740 CHAMBER	SHALL BE WRAPPED IN LINEAR LOW DENSITY POLYETHYLENE LINER, MIN. 20 MIL THICKNESS PAYEMENT SECTION - SEE DETAIL				,		
GRADATION TABLE————————————————————————————————————	PAVEMENT SECTION - SEE DETAIL	1 1/2° CRUS	HED ANGULAR ST	ONE GRADATION			
NON-WOVEN GEOTEXTILE—		SIEVE	% PASSING	BY WEIGHT			
		2"	10	00			
		1 1/2"	90 -	- 100			
		1"	20 -	- 55			
	30.	3/4"	0 -	- 15			
		3/8"	0 -	- 5			
	6 51 12 UNDERDIVEW FOI	RAIN, SEE PLAN R LOCATION	AT ALL PIPE INLET AASHTO M288 CL/ CHAMBER. PLACE A LENGTH ALONG ROLL, BUT NOT LE	PROTECTION NOTE: TS TO CHAMBER PL A 5' - 6' WIDE ST THE CHAMBERS EQ SS THAN 10'. CROSS N.T.S.	'S BETWEEN FOUN RIP CENTERED ON UAL TO THE WIDT	IDATION STONE AN I CHAMBER WIDTH H OF THE FABRIC	MTH.

	.5		-
	- 1 1 1		-
			1000000
			H
L	<u> </u>		H
		-	1
Rev.	Date	Revision	


02/16/07	MPM
02/16/07	MPM
Date	Ву
	02/16/07

hecked: MPM Scale: NONE Job No.: 1614
ile Name: 1614-DETAILS-POND.dwg This plan shall not be modified without writter permission from Gorrill—Palmer Consulting Engineers, Inc.(GPCEI). Any alterations, authorized or otherwise, shall be at the user's sole risk and without liability to GPCEI.

Gorrill-Palmer Consulting Engineers, Inc. PO Box 1237 Traffic and Civil Engineering Services FAX: 207-657-6910 Gray, ME 04039


Drawing Na	Drainage Details
Project:	Residence Inn by Marriott - Portland, Maine
Client:	Summit Hotel Properties, LLC 218 Boston St. Suite 109 - P.O. Box 394 - Topsfield, MA 01983


Drawing No. C403

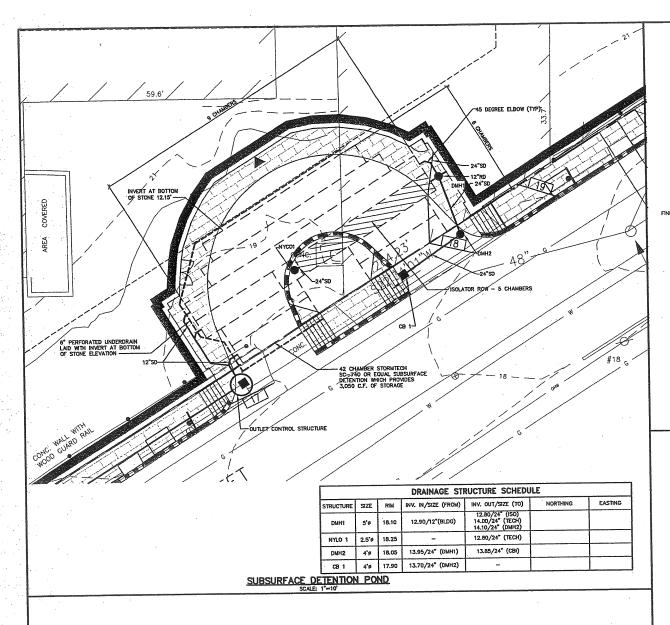


SCHEDULE A					
· ou	TLET CONTROL S				
	TON	DIMENSION/ELEVATION			
ITEM DESCRIP	HON	OCS 1			
A TOP OF	STRUCTURE	16.20			
(B) UNDERSID	E TOP SLAB	15.53			
C TOP CON	CRETE BULKHEAD	15.00			
(B) UNDERSIDE TOP CON (D) ORIFICE D	NVERT	12.15			
ORIFICE I	DIAMETER	1"			
WALL SLE	EEVE I.D.	10"			
(F) ВОТТОМ	OF STRUCTURE	10.65			
© PIPE DIA	METER	12"			
(H) INVERT II	٧	13.85			
PIPE DIA	METER	12"			
(J) INVERT O	OUT .	12.13			
(K) PIPE DIA	METER	6"			
INVERT I	N	12.15			
-		1			

SCHED! ORI	JLE B FICE
DESCRIPTION	DIMENSION OCS 1
A FLANCE O.D. B BOLT CIRCLE NOMINAL PIPE DIA. BOLT HOLE DIA. E ECCENTRIC ORIFICE DIAMETER	16.00" 14.25" 10" 1" 1"

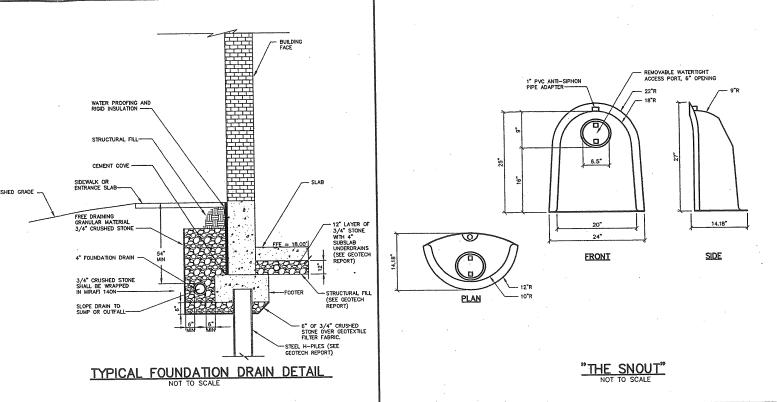

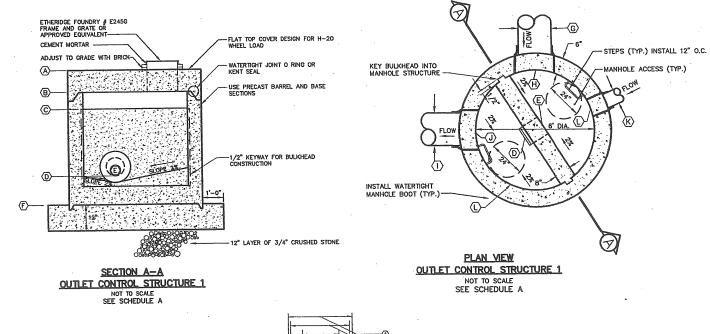

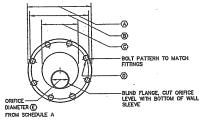

ORIFICE DETAIL 1
SEE SCHEDULE B

THESE PLANS HAVE BEEN ISSUED FOR THE PLANNING BOARD WORKSHOP, FINAL SITE PLAN SUBMISSION WILL BE ISSUED AT A LATER DATE.

1 inch = 20 ft.

NOTE: THIS PLAN SET IS ISSUED FOR PERMITTING PURPOSES AND SHALL NOT BE USED FOR CONSTRUCTION.

-			•
-			
-			
	_		-
	Rèv.	Date	Revision

	2ND PB WORKSHOP SUBMISSION	02/16/07	MPM
	SKETCH PLAN	02/08/07	MPM
_	legued For	Date	Ву


Design: WHS Draft: BVD Dete: OCT. 2006
Checked: MPM Scale: AS NOTED Job No.: 1614
File Nome: 1614-DETAILS-POND.0wg
This plon shall not be modified without written
permission from Corrill-Palmer Consulting
Englineers, Inc. (GPCEI). Any alterations,
authorized or otherwise, shall be at the user's
sole risk and without liability to GPCEI.


G	Gorrill-Palmer	Consulting	Engineers,	Inc

- 1					
	PO Box 1237 Traffic	and Civil	Engineering	Services	207-657-6910 FAX: 207-657-6912
	Gray, ME 04039			E-Mail: ma	ilbox@gorriilpalmer.com

Drawing N	Subsurface Detention Pond Plan and Details
Project:	Residence Inn by Marriott - Portland, Maine
Client:	Summit Hotel Properties, LLC 218 Boston St. Sulte 109 - P.O. Box 394 - Topsfield, MA 01983

Drawing No. C404

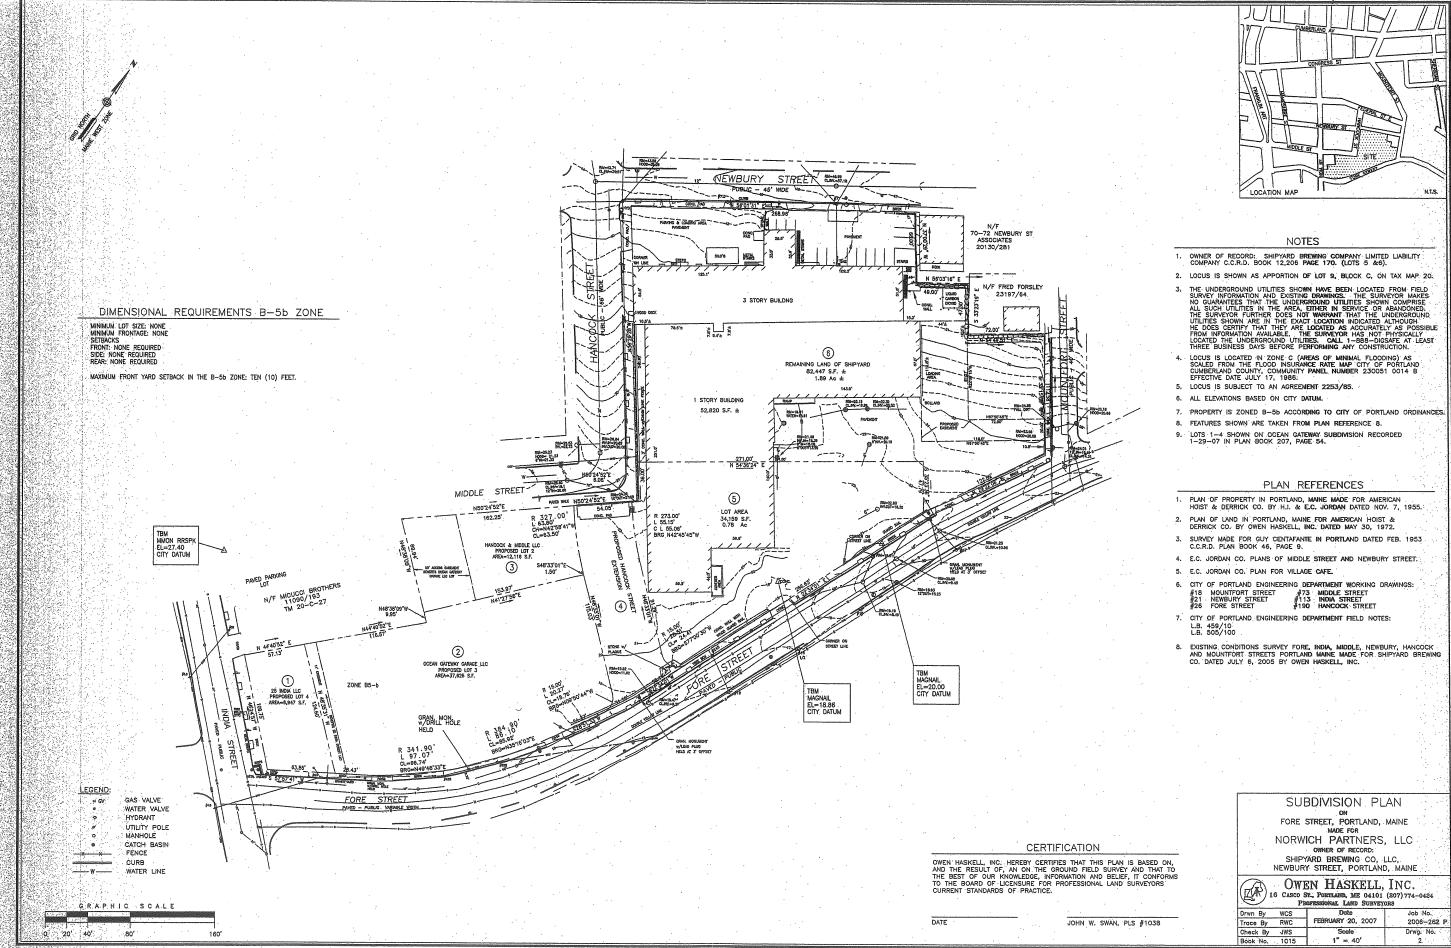

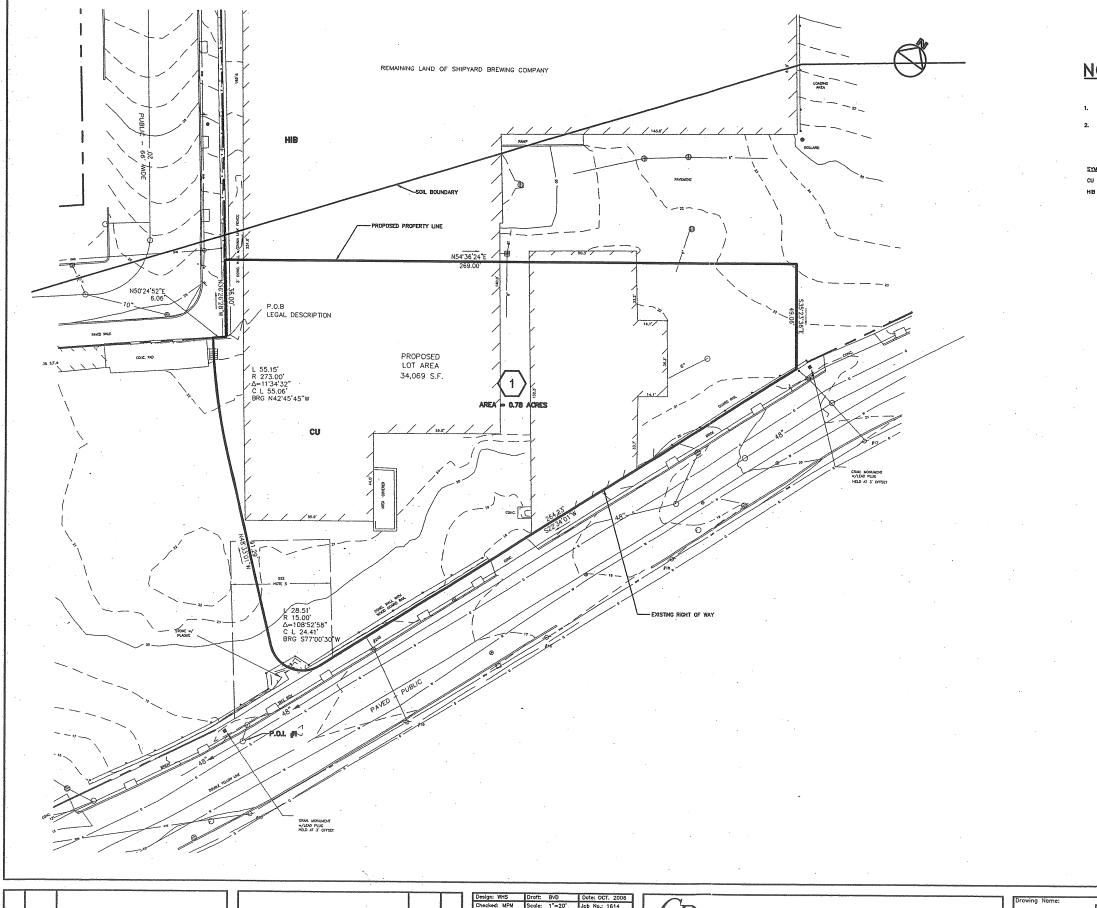

NOTES


- SUBCATCHIENT 1 HAS AN ASSUMED TIME OF CONCENTRATION (TC VALUE) OF 5 MINUTES WHICH IS APPROPRIATE FOR AN URBAN ENVIRONMENT.

SYMBOL DESCRIPTION

CU - CUT AND FILL

HIB - HINKLEY GRAVELLY SANDY LOAM

THESE PLANS HAVE BEEN ISSUED FOR THE PLANNING BOARD WORKSHOP. FINAL SITE PLAN SUBMISSION WILL BE ISSUED AT A LATER DATE.

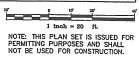


1				
1				
-]				
-				
- 1	1 1		· .	
1			,	
1	-			
1				
-	Rev	Date	Revision	

2ND PB WORKSHOP SUBMISSION	02/16/07	МРМ
SKETCH PLAN	02/08/07	MPM
Issued For	Date	Ву

Design: WHS	Droft:	BVD	Date: OCT. 2006	
Checked: MPM	Scale:	1°=20'.	Job No.: 1614	
File Name: 1614-WS-PRE.dwg				
This plan shall not be modified without written permission from Gorill—Palmer Consulting				
Engineers, Inc.(GPCEI). Any alterations, authorized or otherwise, shall be at the user's				

GP_{\perp}	Gorri	ll-P	alme	r Consulti	ng Eng	ineers,	Inc.
PO Box 1237 15 Shaker Road	Traffic	and	Civil	Engineering			
Gray, ME 0403	9.				E-Mail: m	ailbox@gorrillpa	lmer.com

Drawing Name	
	Predevelopment Watershed Map
Project:	Residence Inn by Marriott - Portland, Maine
Client;	Summit Hotel Properties, LLC 218 Boston St. Suite 109 - P.O. Box 394 - Topsfield, MA 01983

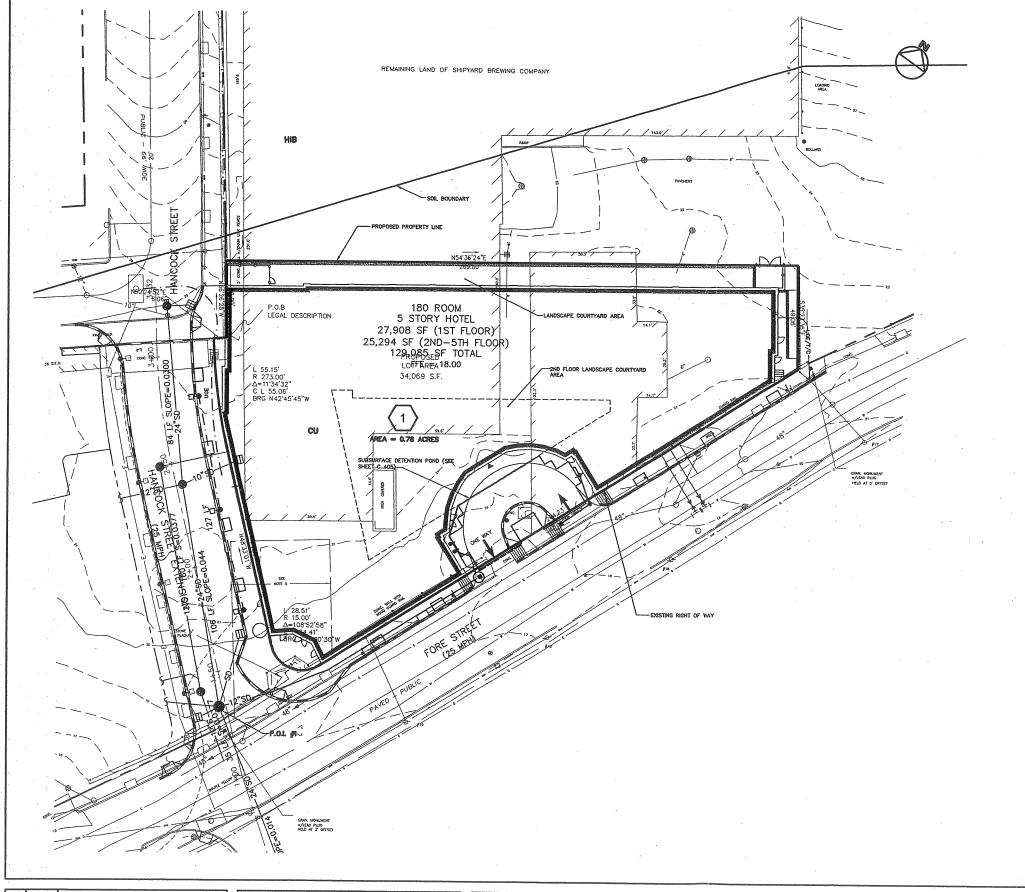

NOTES

- SUBCATCHMENT 1 HAS AN ASSUMED TIME OF CONCENTRATION (TC VALUE) OF 5 MINUTES WHICH IS APPROPRIATE FOR AN URBAN ENVIRONMENT.
- TO BE CONSERVATIVE THE LANDSCAPE AREA WAS NOT TAKEN INTO CONSIDERATION
 WHEN DETERMINING THE CN VALUE. AN ASSUMED CN VALUE OF 98, TYPICAL OF
 IMPERVOUS AREAS WAS APPLIED TO ENTIRE DEVISION OF INTERPROPERTY AREA.

SYMBOL DESCRIPTION

CU - CUT AND FILL

HIB - HINKLEY GRAVELLY SANDY LOAM


THESE PLANS HAVE BEEN ISSUED FOR THE PLANNING BOARD WORKSHOP. FINAL SITE PLAN SUBMISSION WILL BE ISSUED AT A LATER DATE.



NOTE: THIS PLAN SET IS ISSUED FOR PERMITTING PURPOSES AND SHALL NOT BE USED FOR CONSTRUCTION.

		·
	_	
Rev.	Date	Revision

	2ND PB WORKSHOP SUBMISSION	02/16/07	MPM
ļ	SKETCH PLAN	02/08/07	MPM
	Issued For	Date	Ву

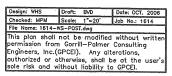

I GP	Gorri	ll–Pa	alme	r Consulti	ng En	gineers,	Inc.
PO Box 1237 15 Shaker Roa Gray, ME 0403	Traffic	and	Civil	Engineering		S 207-6: FAX: 207-6: nailbox@gorrillpa	

nsulting Engineers, Inc.	Postdevelopment Watershed Map
eering Services 207-657-6910 FAX: 207-657-6912	Project: Residence Inn by Marriott — Portland, Maine
FAX: 207-657-6912 E-Mail: mailbox@gorrillpalmer.com	Client: Summit Hotel Properties, LLC 218 Boston St. Suite 109 - P.O. Box 394 - Topsfield, MA 01983

Drawing No.

WS-2