


SECOND FLOOR FRAMING PLAN

1/4" = 1'-0"

KEYED NOTES

- REMOVE UPPER BOLT IN EX. BEAM TO POST CONNECTION. REPLACE WITH GALV. THRU-BOLT w/1/4"x2"x2" PLATE WASHER EA. SIDE
- 75 REMOVE EX. 1x TIE BETWEEN POST AND BEAM. REPLACE w/ SIMPSON PS720 STRAP TIE
- REINFORCE EX. SPLIT IN 4x8 w/ 6" LONG SDWC15600 SCREW BY SIMPSON STRONG TIE. INSTALL 2x6 x 2'-0" LONG BELOW BEAM FASTENED TO POST w/(8) $3^{5}/8$ " Long fastenmaster timberlok screws

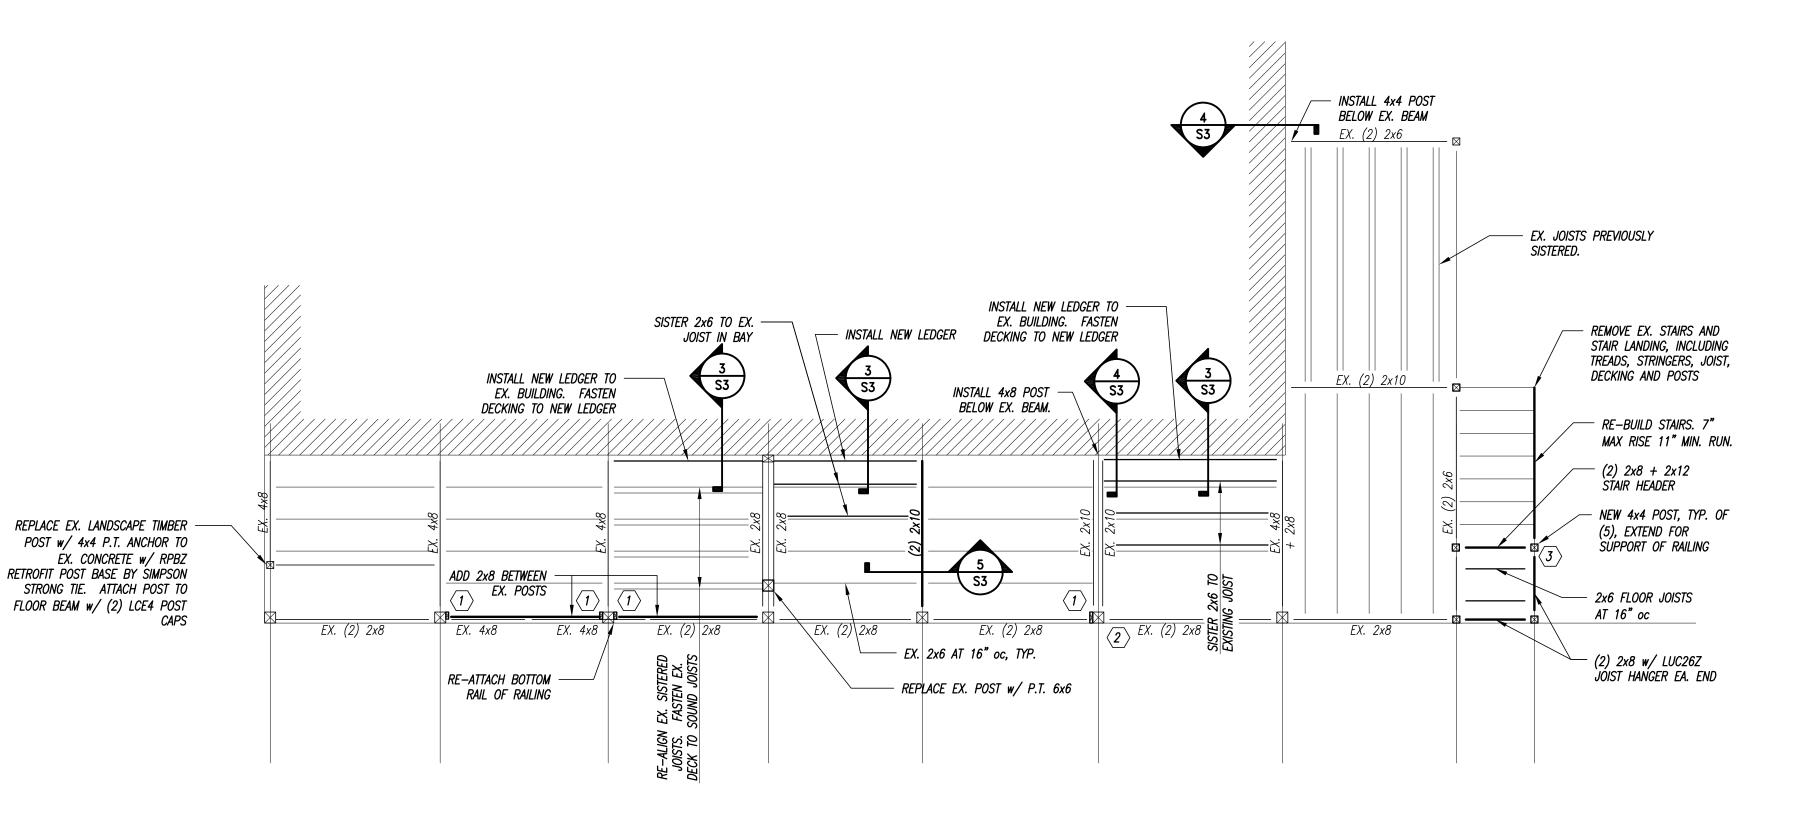


FIRST FLOOR FRAMING PLAN

1/4" = 1'-0"

KEYED NOTES

- 1) ADD 2x6 TO SIDE OF EX. POST. SEE DETAIL 1/S3
- 2 ADD FRAMING ANGLE BETWEEN BEAM AND POST. SEE DETAIL 2/S3
- SUPPORT NEW POST ON 12" SQUARE CONCRETE DECK BLOCKS FOUNDED A MINIMUM OF 2'-0" BELOW EX. GRADE, TYP. OF (5)

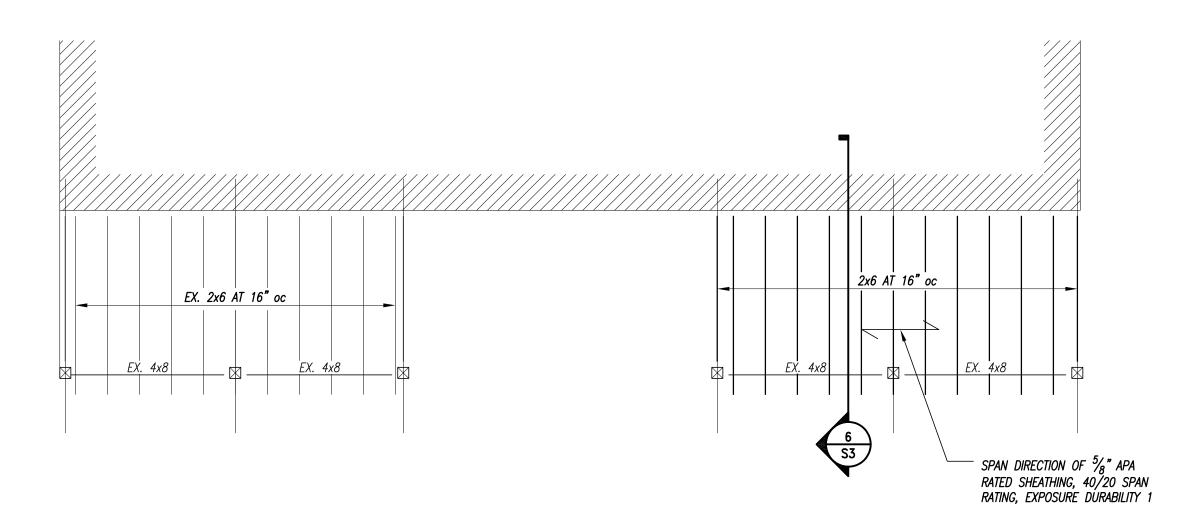


ROOF FRAMING PLAN

1/4" = 1'-0"


KEYED NOTES


FEMOVE EX. 1x TIE BETWEEN POST AND BEAM. REPLACE w/ SIMPSON PS720 STRAP TIE

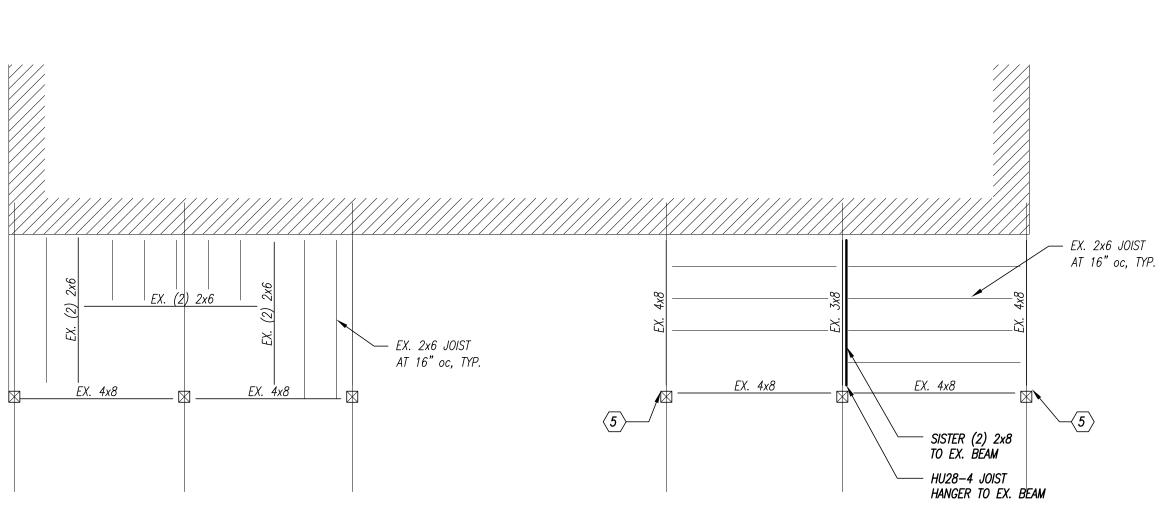

THIRD FLOOR FRAMING PLAN

1/4" = 1'-0"

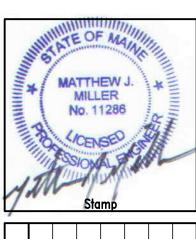

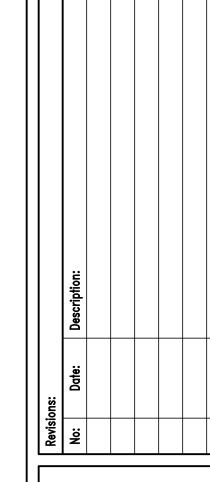

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Project No: Designed By: Drawn By: Checked By: AS NOTED 10/04/2017 Date: