




**SECOND FLOOR FRAMING PLAN**

Scale: 1/4" = 1'-0"

**FLOOR FRAMING NOTES:**

1. See structural notes sheet S1.
2. Built-up beams shall be spiked together w/ 3 rows of 16d nails @ 12" o.c.
3. Provide metal hangers at all joist connections.
4. Provide double joists below all upper parallel walls.
5. Provide solid blocking at mid-span of all joists.
6. See architectural drawings for all dimensions and openings.
7. Add solid blocking between floor joists below all posts.
8. Provide (2) 2 x 10 headers with 2" rigid insulation at all exterior window and door openings unless noted otherwise on plans.
9. Leave 3/8" gap between top of floor beams and bottom for plywood sheathing.
10. Field verify existing member size matches as shown. Notify engineer if member does not match.

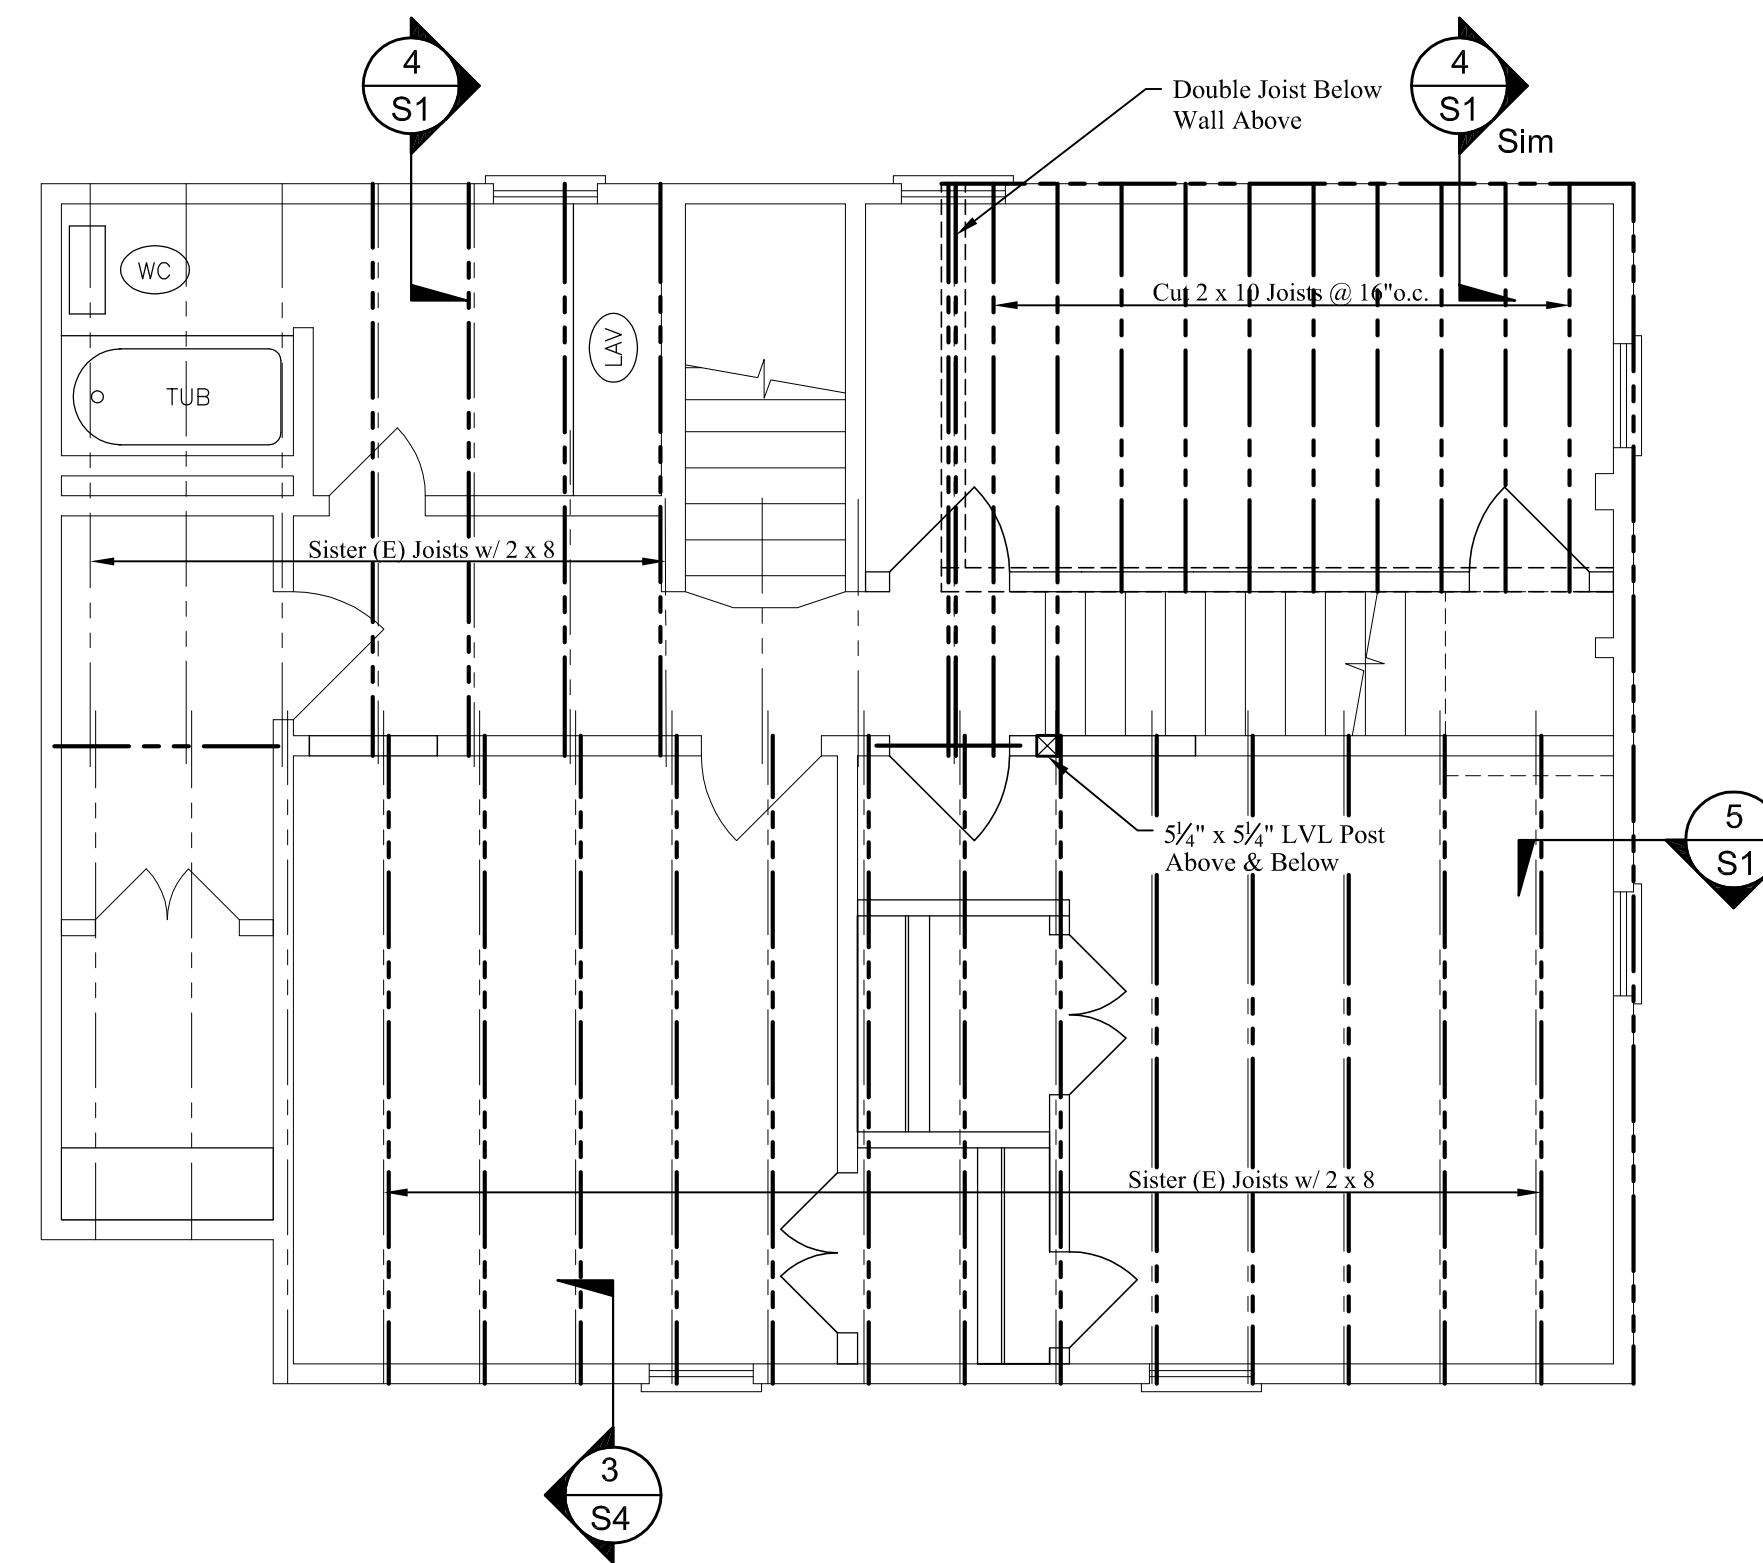


**THIRD FLOOR FRAMING PLAN**

Scale: 1/4" = 1'-0"

**FLOOR FRAMING NOTES:**

1. See structural notes sheet S1.
2. Built-up beams shall be spiked together w/ 3 rows of 16d nails @ 12" o.c.
3. Provide metal hangers at all joist connections.
4. Provide double joists below all upper parallel walls.
5. Provide solid blocking at mid-span of all joists.
6. See architectural drawings for all dimensions and openings.
7. Add solid blocking between floor joists below all posts.
8. Provide (2) 2 x 10 headers with 2" rigid insulation at all exterior window and door openings unless noted otherwise on plans.
9. Leave 3/8" gap between top of floor beams and bottom for plywood sheathing.

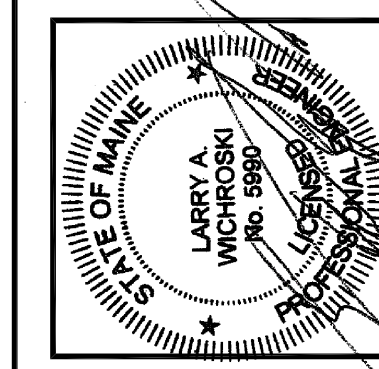

DESIGNED BY:  
 Larry A. Wichroski, P.E.  
 DRAWN BY:  
 LAW  
 JOB #:  
 06614  
 DATE:  
 12-18-2014

REVISIONS

SHEET:  
**S3**  
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