

UNIT NOTES

1.) CEILING HEIGHTS, WINDOW HEAD AND SILL HEIGHTS VARY FROM FLOOR TO FLOOR, INTERIOR ELEVATIONS GRAPHICALLY DEPICT ONE FLOOR ONLY, FOR HEIGHT INFORMATION REFER TO BUILDING SECTIONS AND WALL SECTIONS

2.) G.C. TO CONFRIM AND COORDINATE ALL ROUGH FRAMING

DIMENSIONS FOR TUBS, SHOWERS, BUILT-IN FIXTURES ETC. G.C. TO CONFRIM AND COORDINATE ALL CABINETRY AND APPLIANCES DIMENSIONS 3.) PROVIDE APPROPRIATE BLOCKING IN WALLS BEHIND ALL FIXTURES, PARTITIONS, CABINETS AND ACCESSORIES.
BLOCKING FOR GRAB BARS TO BE PROVIDED IN WALLS OF

BATHROOMS IN ALL UNITS 4.) PROVIDE MOISTURE RESISTANT GWB AT ALL WALLS AND CEILINGS IN BATHROOMS TYPICAL

5.) SET ALL CLOTHES WASHERS IN PANS WITH WATER SENSOR 6.) REFER TO ELECTRICAL AND MECHANICAL DRAWINGS FOR ADDITIONAL INFORMATION REGARDING, LIGHTING, DIFFUSERS,

7.) PROVIDE FIRE EXTINGUSHER ON BRACKET IN BASE CABINET

BELOW KITCHEN SINK - TYPICAL

8.) HANG HOT WATER HEATER FROM CEILING ABOVE CLOTHES ROD IN CLOSET, PROVIDE UNISTRUT SUPPORTS ON TOP OF BOTTOM CHORDS OF TRUSSES PRIOR TO CEILING INSTALLATION

CABINETRY AND APPLIANCE ABBREVIATIONS

DB = DRAWER BASE


DRB = DOOR BASE

SB = SINK BASE WC = WALL CABINET

WC(24) = WALL CABINET 24" DEEP PU = PANTRY UNIT 24" DEEP

OS = OPEN SHELVES RA = RANGE

DW = DISHWASHER REF = REFRIGERATOR

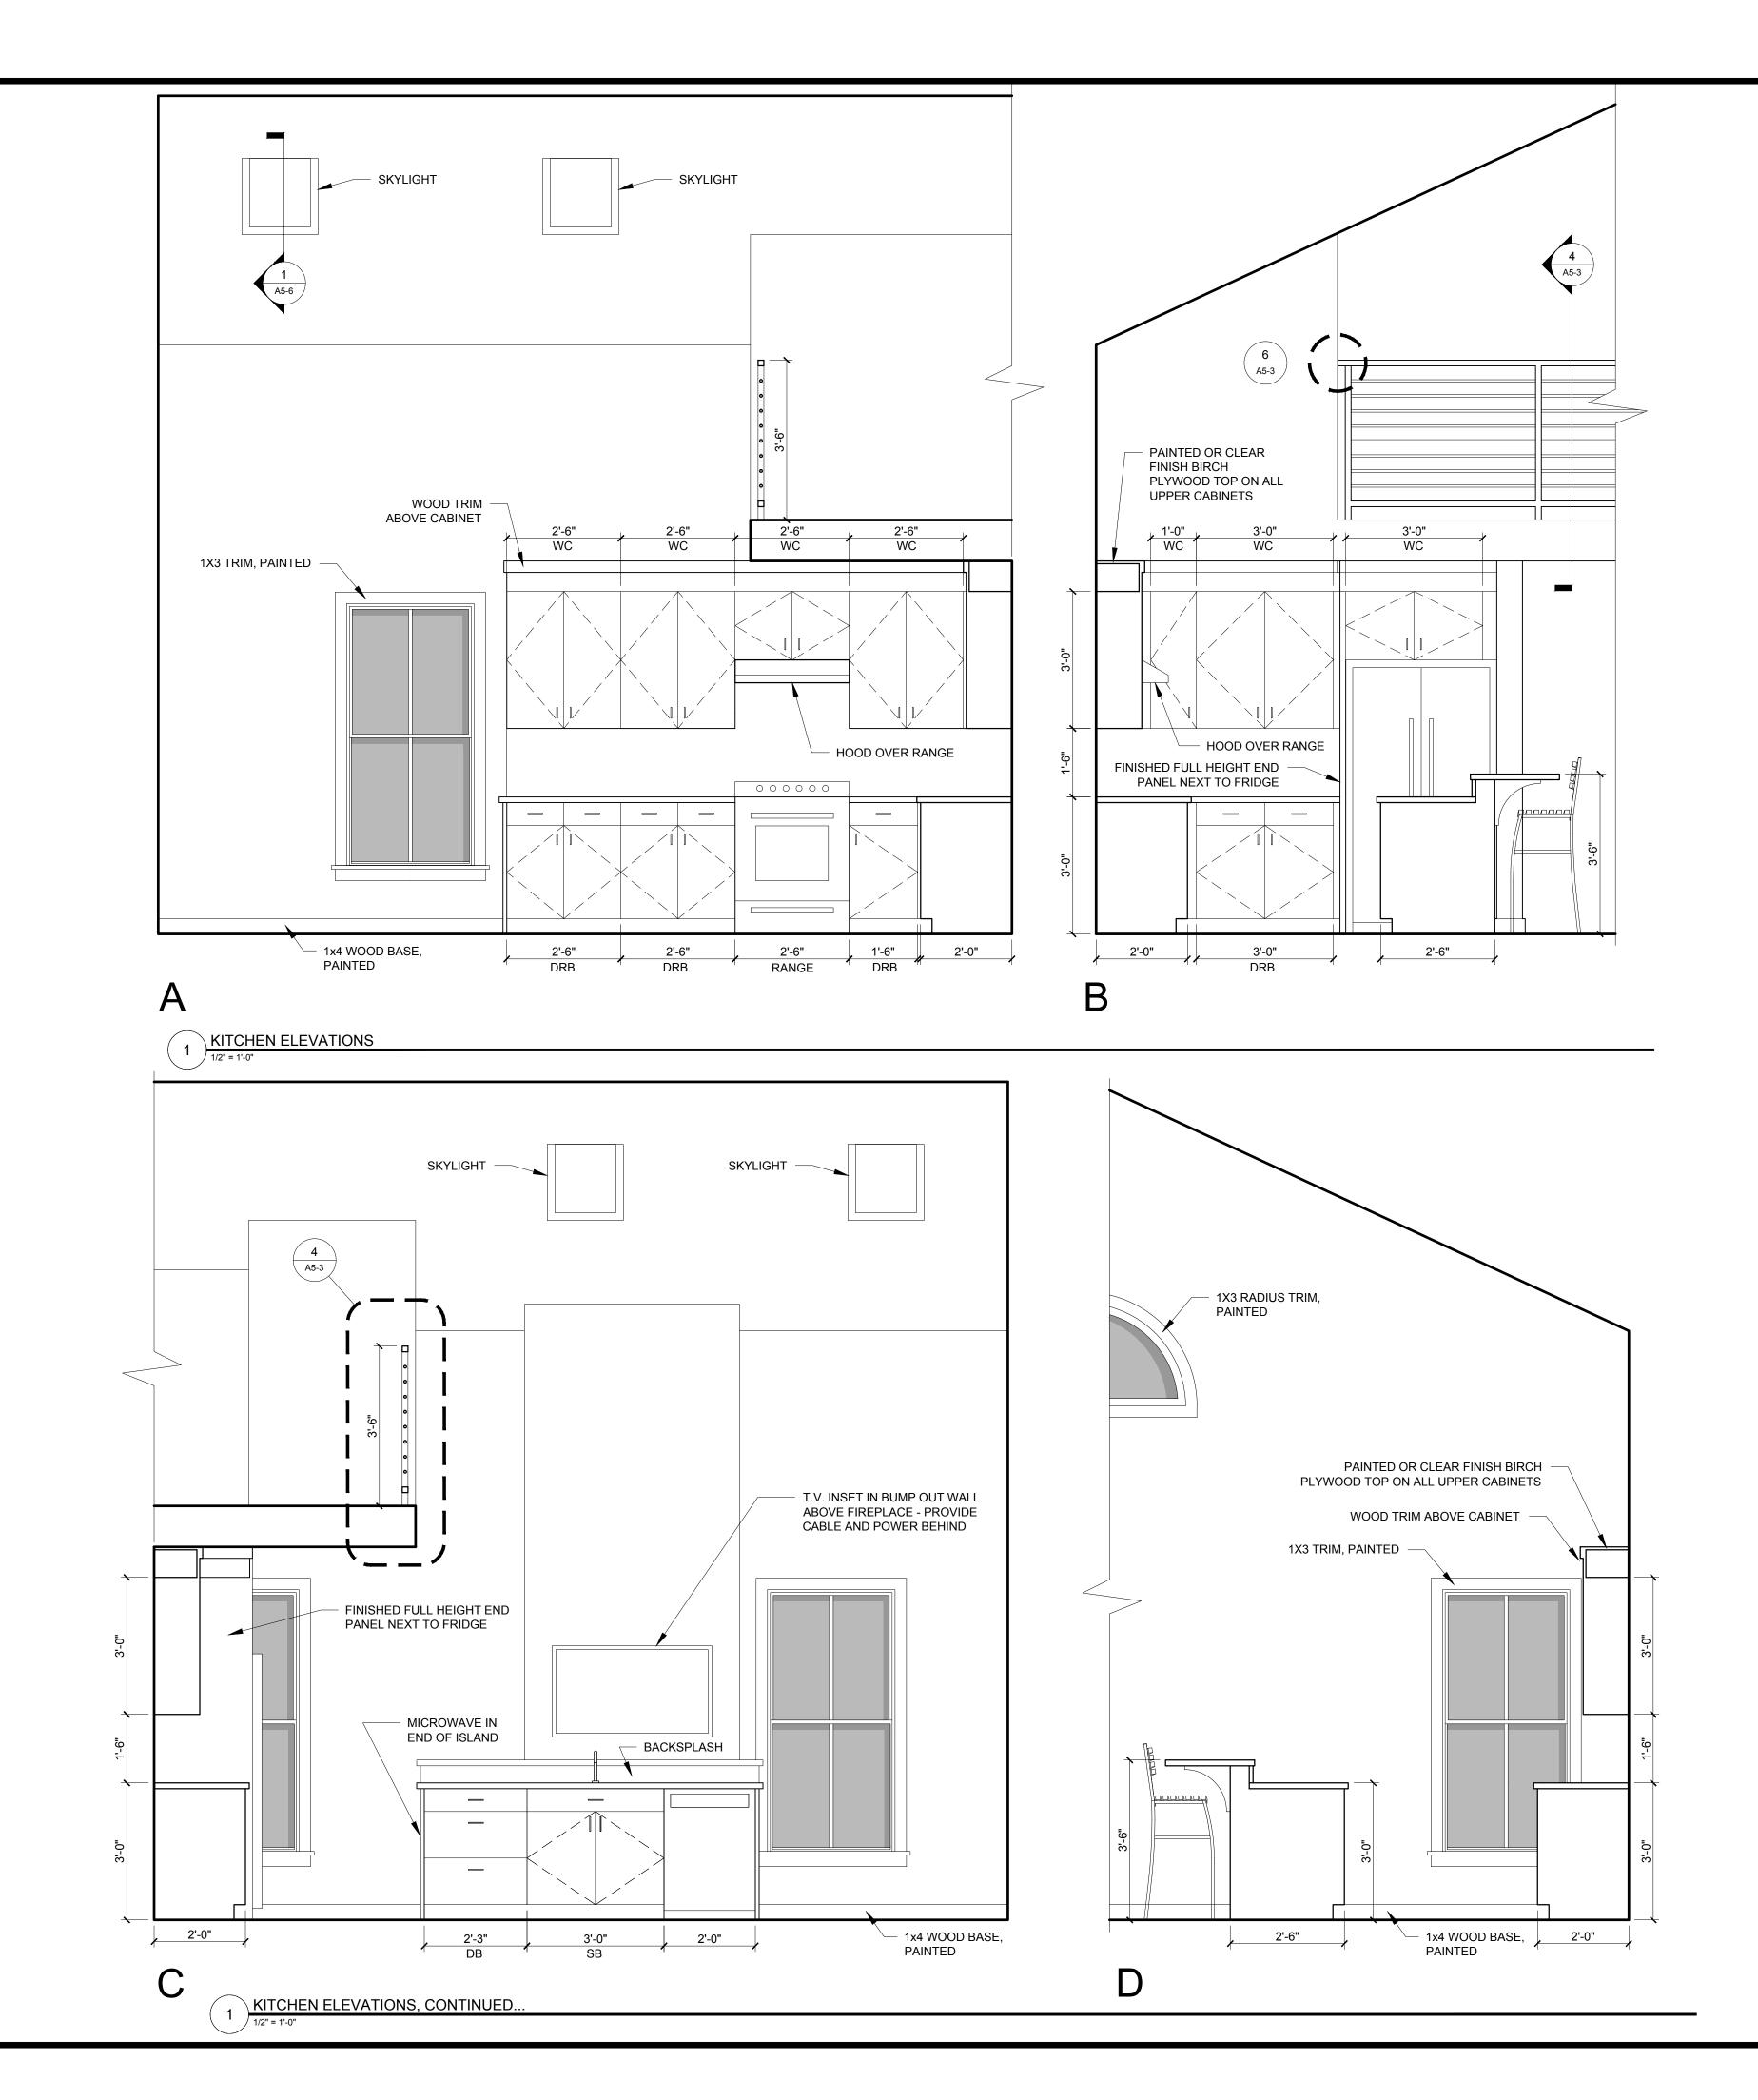



© 2016 RYAN SENATORI ARCHITECTURE

SIDENCE INDIA

107

A H

ARCHITECTURE 565 CONGRESS STREET PORTLAND, MAINE 04101 207-747-5159 senatorearchitecture.com

CONSULTANTS: STRUCTURAL: Structural Integrity
77 Oak Street
Portland, ME 04101
207-774-4614

REVISIONS:

DATE: FEBRUARY 5, 2016

PROJECT No. DRAWN BY:

CHECKED BY: SCALE: AS NOTED

SHEET TITLE: KITCHEN ELEVATIONS