


**NOTES:**  
 1. SEE SHEET E-001 FOR LEGEND AND GENERAL NOTES.

- KEYED NOTES:**
- ① BOND TO STEEL COLUMN, BUILDING STEEL AND TO REBAR IN FOOTING.
  - ② FURNISH AND INSTALL 1/4"x4"x20" GROUND BAR (ERICO CADWELD MODEL # 8544A1T002 OR EQUAL) WITH INSULATORS MOUNTED 48" AFF. TIE GROUND BAR TO GROUND LOOP WITH A BARE #3/0 COPPER CONDUCTOR AND TO ALL 19" EQUIPMENT RACKS WITH A GREEN INSULATED #6 GROUNDING CONDUCTOR.
  - ③ BOND GROUND LOOP TO NEW PAD MOUNT TRANSFORMER GROUNDING PADS.

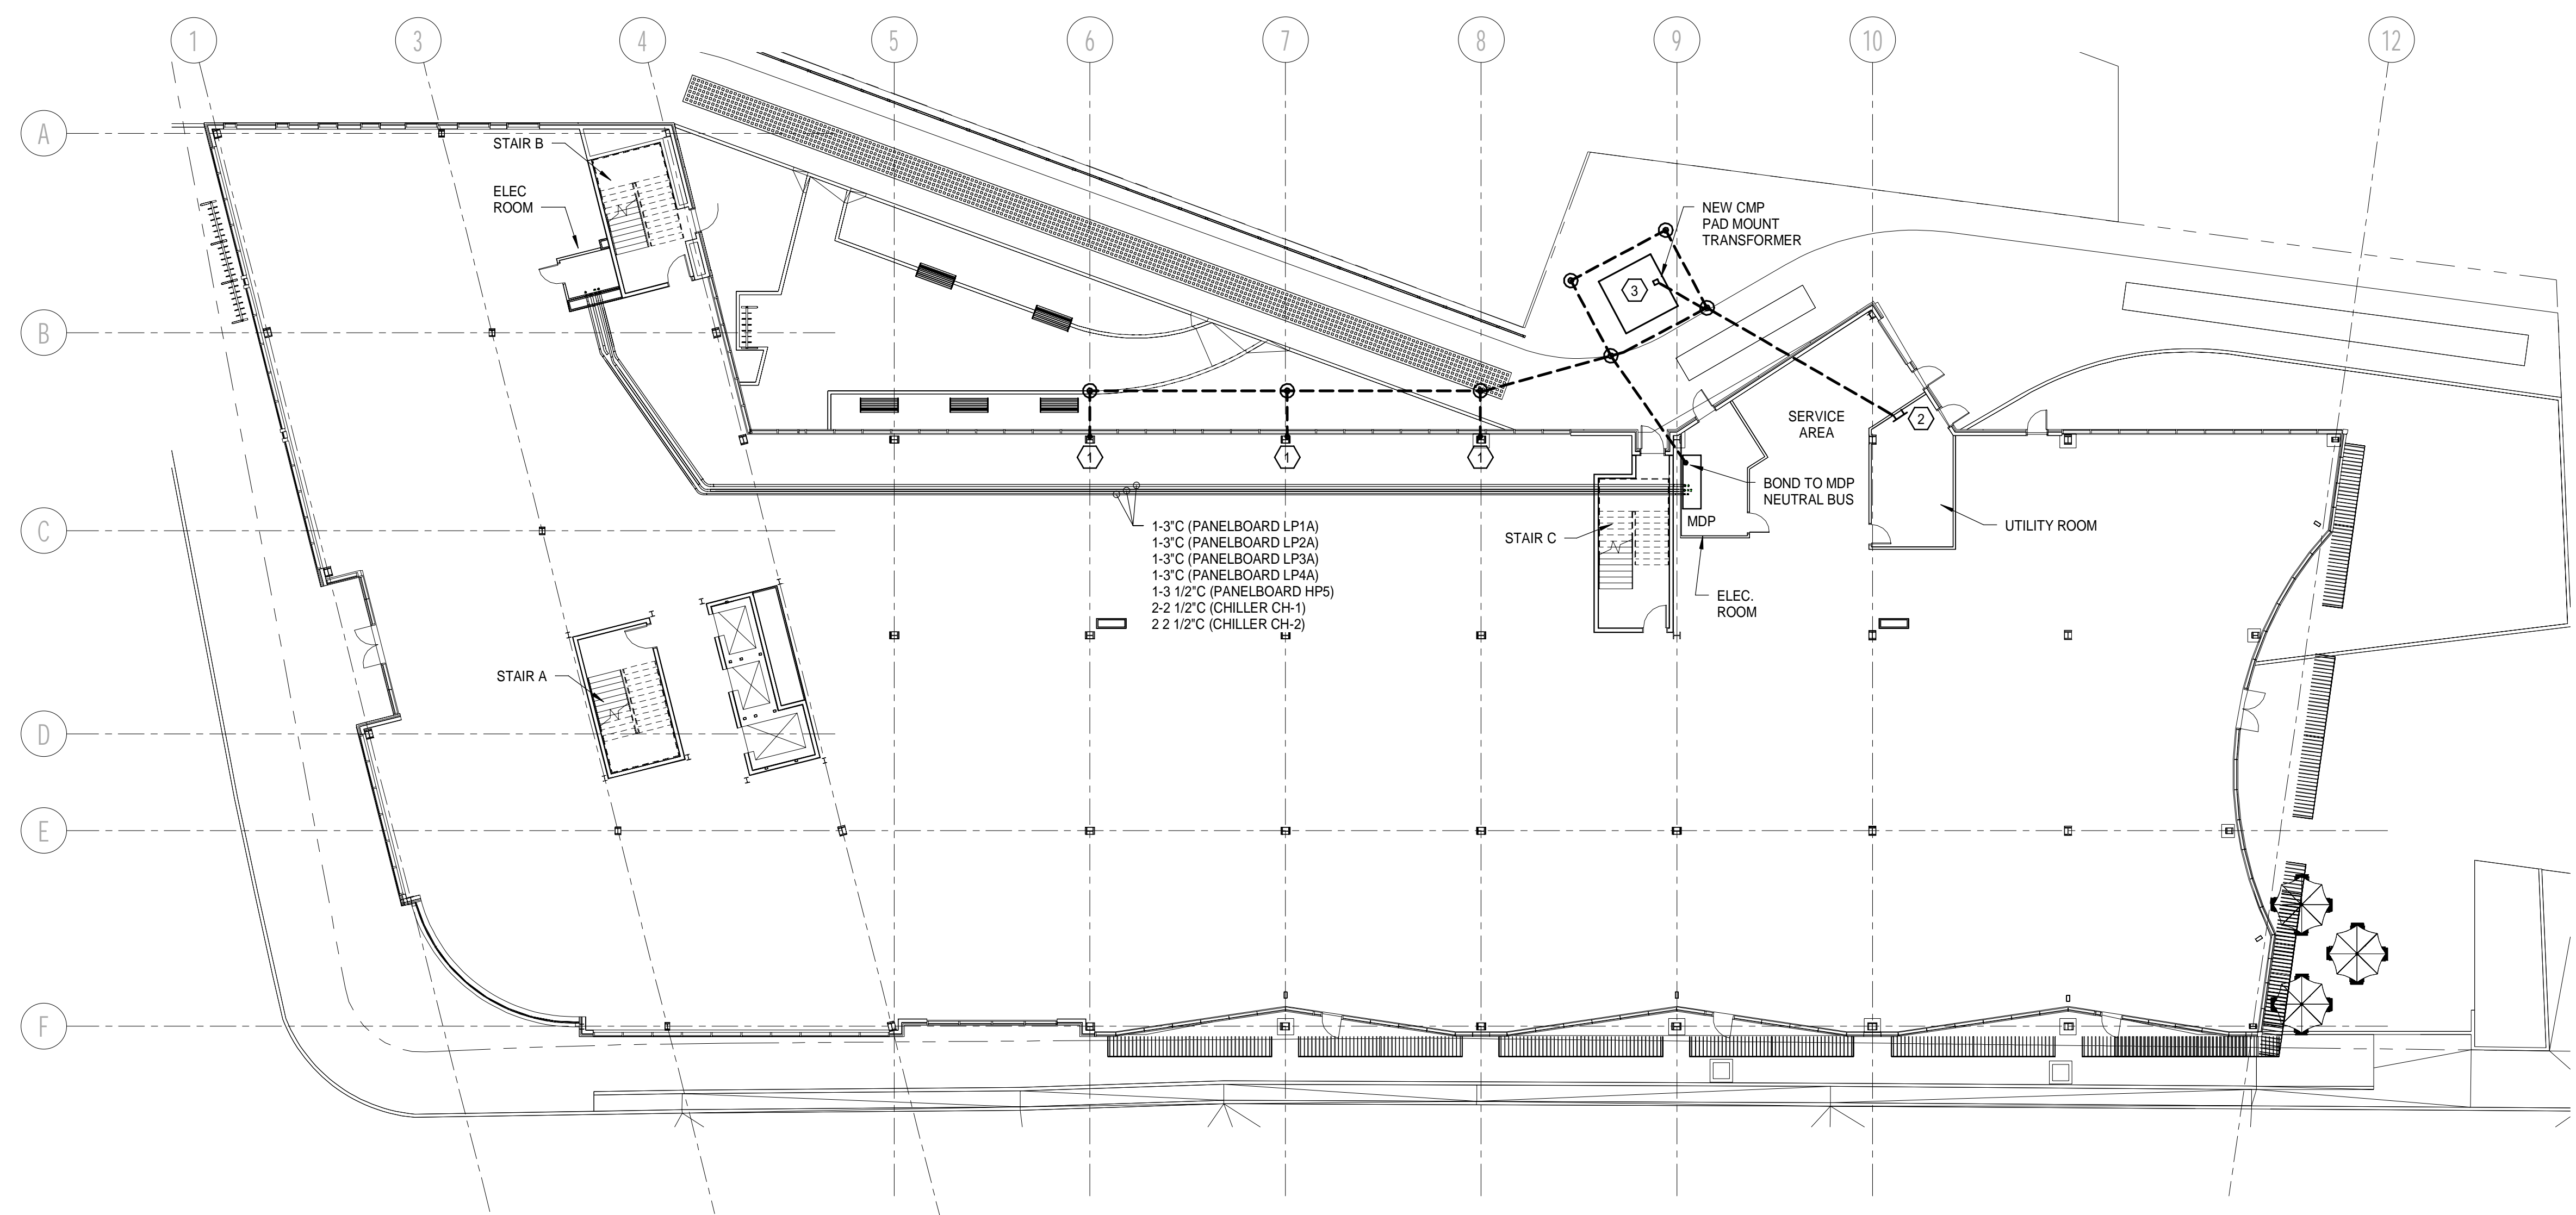

REV	DESCRIPTION	DATE
0	ISSUED FOR PERMIT	10/23/2017

**ISSUED FOR PERMIT**  
 10/23/2017  
 CURRENT ISSUE STATUS:


PROJECT NORTH:

SMRT Architects and Engineers  
 144 Fore Street/P.O. Box 618  
 Portland, Maine 04104

ARCHITECTURE | ENGINEERING | PLANNING | INTERIOR DESIGN | ENERGY SERVICES | **SMRT**

**WEX**  
 8 HANCOCK STREET, PORTLAND MAINE

**UNDER SLAB AND GROUNDING PLAN**

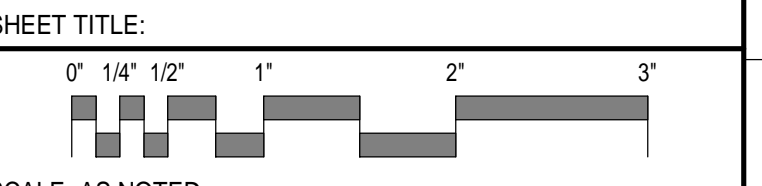

SCALE: AS NOTED

PROJECT MANAGER:	DJT	PROJECT NO.:	17146
A/E OF RECORD:	DJT		
JOB CAPTAIN:	DTJ		
DRAWN BY:	CDS		
SMRT FILE:	EG101-17146	SHEET No.:	<b>EG101</b>

**UNDER SLAB AND GROUNDING PLAN** (A1)  
 1/16" = 1'-0"