		Year 1	U B		Day 3200	Cubic Feet.  Utility Dep.	
		Unit.		1		ea Co	of Re blic se blic
		Coefficient	Multiplier	Depth	Sound Valu	12	SEE SEE RESCHOOL SEE SEE SEE SEE SEE SEE SEE SEE SEE SE
				NOI			
		Land Value	Coefficient		54	Height t	Plumbing Common Individual Open Set jubs Finish Hardwood Halls Wood—Roofing Shingle Fire Paraca Prepared Asbestos Flat Hip Gable Dormers Window Plain Glass Shutters Window Plain Glass Window Plain

## STRUCTURAL GENERAL NOTES

- THE CONTRACTOR SHALL COMPLY WITH ALL FEDERAL, STATE, AND LOCAL SAFETY REQUIREMENTS.
   FURTHERMORE, THE CONTRACTOR SHALL BE COMPLETELY RESPONSIBLE FOR THE SAFETY OF ADJACENT PROPERTY AND THE PUBLIC.
- 2. NO PROVISIONS HAVE BEEN MADE FOR ANY TEMPORARY CONDITIONS THAT MAY ARISE DURING CONSTRUCTION PRIOR TO THE COMPLETION OF THE PROJECT. THE CONTRACTOR SHALL BE RESPONSIBLE FOR ADEQUATE DESIGN AND CONSTRICION OF ALL FORMS, SHORING, AND TEMPORARY BRACING DURING THE PROJECT.
- 3. WORK NOT INDICATED ON THE DRAWINGS BUT REASONABLY IMPLIED TO BE SIMILAR TO THAT SHOWN AT CORRESPONDING PLACES SHALL BE INCLUDED.
- 4. THE CONTRACTOR SHALL NOTIFY ENGINEER OF ANY DISCREPANCIES BETWEEN THE DRAWINGS AND EXISTING CONDITIONS THAT MAY AFFECT THE WORK. DUE TO THE TIGHT DIMENSIONAL TOLERANCES NECESSARY TO ACHIEVE CODE COMPLIANCE ON THIS PROJECT, IT IS HIGHLY RECOMMENDED THAT THE OWNER CONTACT THE ENGINEER AFTER DEMOLITION HAS EXPOSED SUFFICIENT STRUCTURE TO VERIFY THE DIMENSIONAL ACCURACY OF THESE EXISTING AND PROPOSED PLANS.
- 5. ANY MODIFICATION OR ALTERATION OF THESE CONSTRUCTION DOCUMENTS OR CHANGES IN CONSTRUCTION FROM THE INTENT OF THESE DOCUMENTS BY THE CONTRACTOR WITHOUT WRITTEN APPROVAL OF THE ENGINEER SHALL REMOVE ALL PROFESSIONAL AND LIABILITY RESPONSIBILITY ON THE PART OF THE ENGINEER. ALTERNATE CONNECTION DETAILS MAY BY USED IF SUBMITTED TO THE ENGINEER FOR REVIEW, AND ACCEPTANCE GRANTED.
- 6. DO NOT SCALE FROM THE DRAWINGS.

## **DESIGN CRITERIA**

1. BOCA/NATIONAL BUILDING CODE, 1999 EDITION, AS ADOPTED BY THE CITY OF PORTLAND

ADDRESS: 21-23 SHERIDAN STREET, PORTLAND, MAINE CITY CHART - LOT - BLOCK NUMBER 17-F-20/21

BOCA OCCUPANCY: RESIDENTIAL, R-2

FLOOR LIVE LOAD: RESIDENTIAL, ONE AND TWO-FAMILY, SECTION 1606.0

40 PSF - DWELLING UNITS

60 PSF - EXTERIOR DECKS LESS THAN 100 SQUARE FEET

STAIR DESIGN PER BOCA CHAPTER 12

WITH PROVISIONS FOR EXISTING BUILDINGS AS ALLOWED BY SECTION 1204.6, EXCEPTION 6, PROVISIONS FOR STAIRS IN EXISTING STRUCTURES.

MAXIMUM RISER HEIGHT 7 INCHES
TREAD WIDTH 11 INCHES (STAIR STRINGER CUT TO 7 INCHES x 11 INCHES).

SNOW LOAD PER BOCA SECTION 1608.0 GROUND SNOW LOAD Pg = 60 PSF FLAT ROOF SNOW LOAD = 42 PSF

FLAT ROOF SNOW LOAD = 42 PSF


## LUMBER AND JOIST HANGERS

- 1. ALL LUMBER USED ON THIS JOB SHALL BE SPRUCE-PINE-FIR (S-P-Fs) NO. 2 OR BETTER, KILN DRIED TO A MOISTURE CONTENT OF 15 PERCENT OR LESS. DO NOT USE LUMBER THAT HAS BEEN STORED IN DAMP CONDITONS.
- 2. ALL JOIST HANGERS, HURRICANE TIES, AND ATTACHMENT HARDWAREARE TO BE AS SPECIFIED, MANUFACTURED BY SIMPSON STRONG-TIE. CONNECT ALL JOIST HANGERS PER SIMPSON STRONG-TIE REQUIREMENTS.
- 3. SPECIAL ATTENTION SHOULD BE TAKEN TO INSTALL FASTENERS AS INDICATED ON THE DRAWINGS.
- 4. WHEN FASTENING INTO EXISTING LUMBER, IT MAY BE NECESSARY TO PREDRILL HOLES SO THAT NAILS OR SCREWS DO NOT CRACK EXISTING FRAMING. TO ACHIEVE PROPER FASTENER ALIGNMENT, TEMPORARILY PIN JOIST HANGER IN PLACE WHILE DRILLING HOLES.
- 5. NEW STRUCTURAL FRAMING INSTALLATION SHOULD OCCUR WHILE TEMPORARY SHORING IS IN PLACE. FINISH CARPENTRY, DRYWALL INSTALLATION, AND FINISH PAINTING SHOULD OCCUR AFTER TEMPORARY SHORING IS REMOVED.
- 6. ACCLIMATE FRAMING LUMBER TO INTERIOR CLIMATE BY STORING IT INSIDE FOR AT LEAST 48 HOURS BEFORE USE. KEEP LUMBER OFF OF THE FLOOR BY USING SPACER BLOCKS. STORE OUT OF DIRECT SUNLIGHT TO DIMINISH UNEVEN DRYING EFFECTS.
- 7. DO NOT NOTCH JOISTS IN THE MIDDLE-THIRD OF THEIR SPAN.
  REPAIR EXISTING, NOTCHED JOISTS AND RAFTERS BY "SISTERING" THEM
  WITH NEW MATERIAL OF THE SAME DEPTH.
  GLUE AND SCREW NEW MATERIAL TO THE EXISTING MATERIAL.
  PREDRILL HOLES INTO ADDED PIECES TO PROVIDE PRE-DRILLING TEMPLATE
  FOR EXISTING MATERIAL. REFER TO PLANS AND DETAILS FOR OVERLAP LENGTHS.

## STRUCTURAL WORK ASSOCIATED WITH FIRE PROTECTION

- 1. INSTALL SOLID LUMBER FIRE BLOCKING BETWEEN EXISTING WALL STUDS AT THE THIRD FLOOR LEVEL. IF NO SUCH BLOCKING EXISTS.
- 2. AFTER INSTALLING ELECTRICAL WIRING, BLOCK ALL EXISTING, ABANDONED HOLES THAT WERE DRILLED IN PREVIOUSLY-EXISTING BLOCKING.

RESURGENCE NGINEERING & PRESERVATION, INC 132 BRENTWOOD STREET PORTLAND, ME 04103 V/F (207) 773-4880 RESURGENCEINC@AOL.COM ALAN JAGGER 21-23 SHERIDAN STREET PORTLAND, ME 04103 25 JUN 04 AS NOTED DRAWN BY-CHECKED BY A. HODSON A. HODSON PROJECT NUMBER CAD FILE 04-008 JACGERREV.DWG

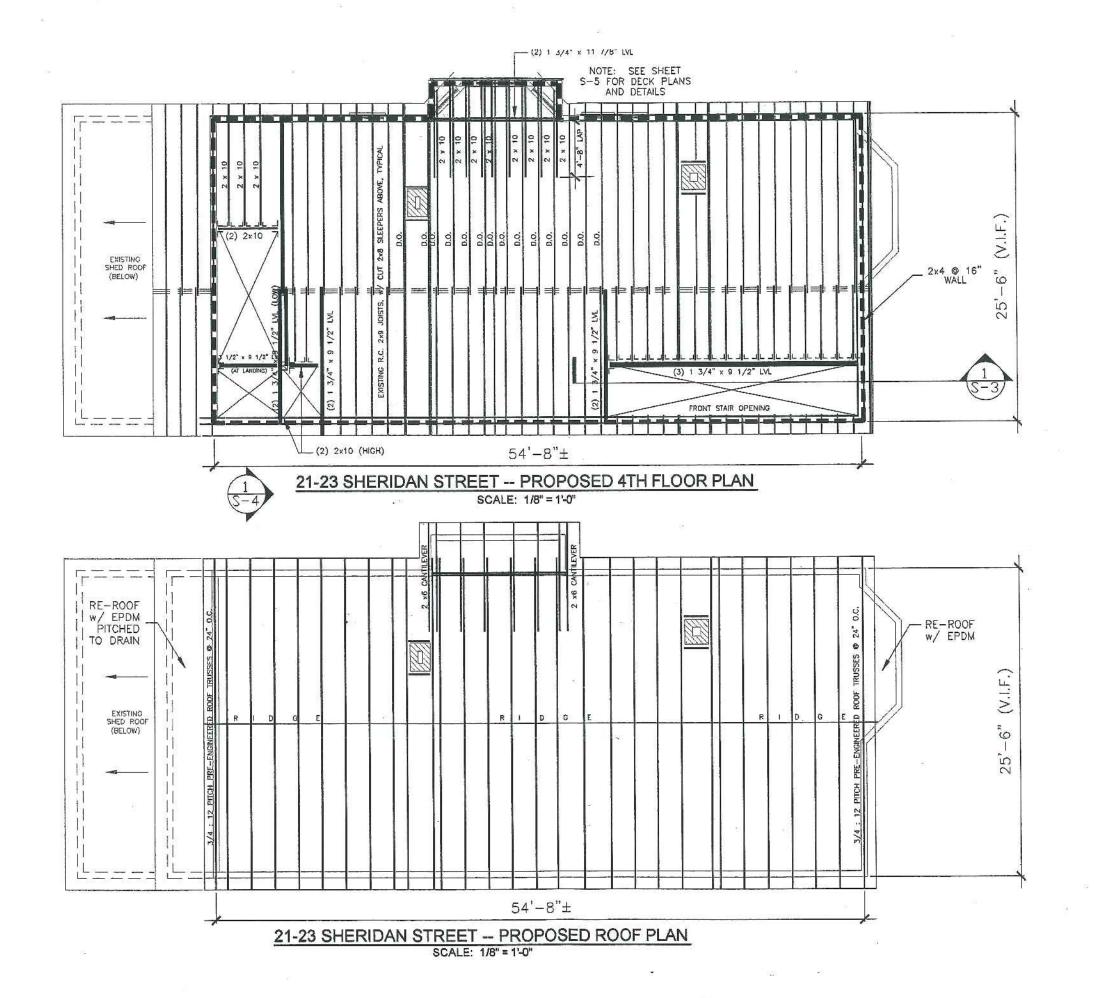


RESURGENCE
ENGINEERING & PRESERVATION, INC.
132 BRENTWOOD STREET
PORTLAND, ME 04103
V/F (207) 773-4880
RESURGENCEINC@AOL.COM

CLIENT: ALAN JAGGER
21-23 SHERIDAN STREET
PORTLAND, ME 04103

DATE:
25 JUN 04 AS NOTED


DRAWN BY: CHECKED BY:
A. HODSON A. HODSON

PROJECT NUMBER: CAD FILE
04-008 JAGGER.DWG

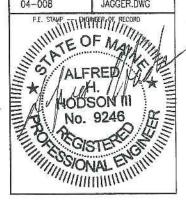

DRAWING NUMBER:


**S-2**SHEET 2 OF 5

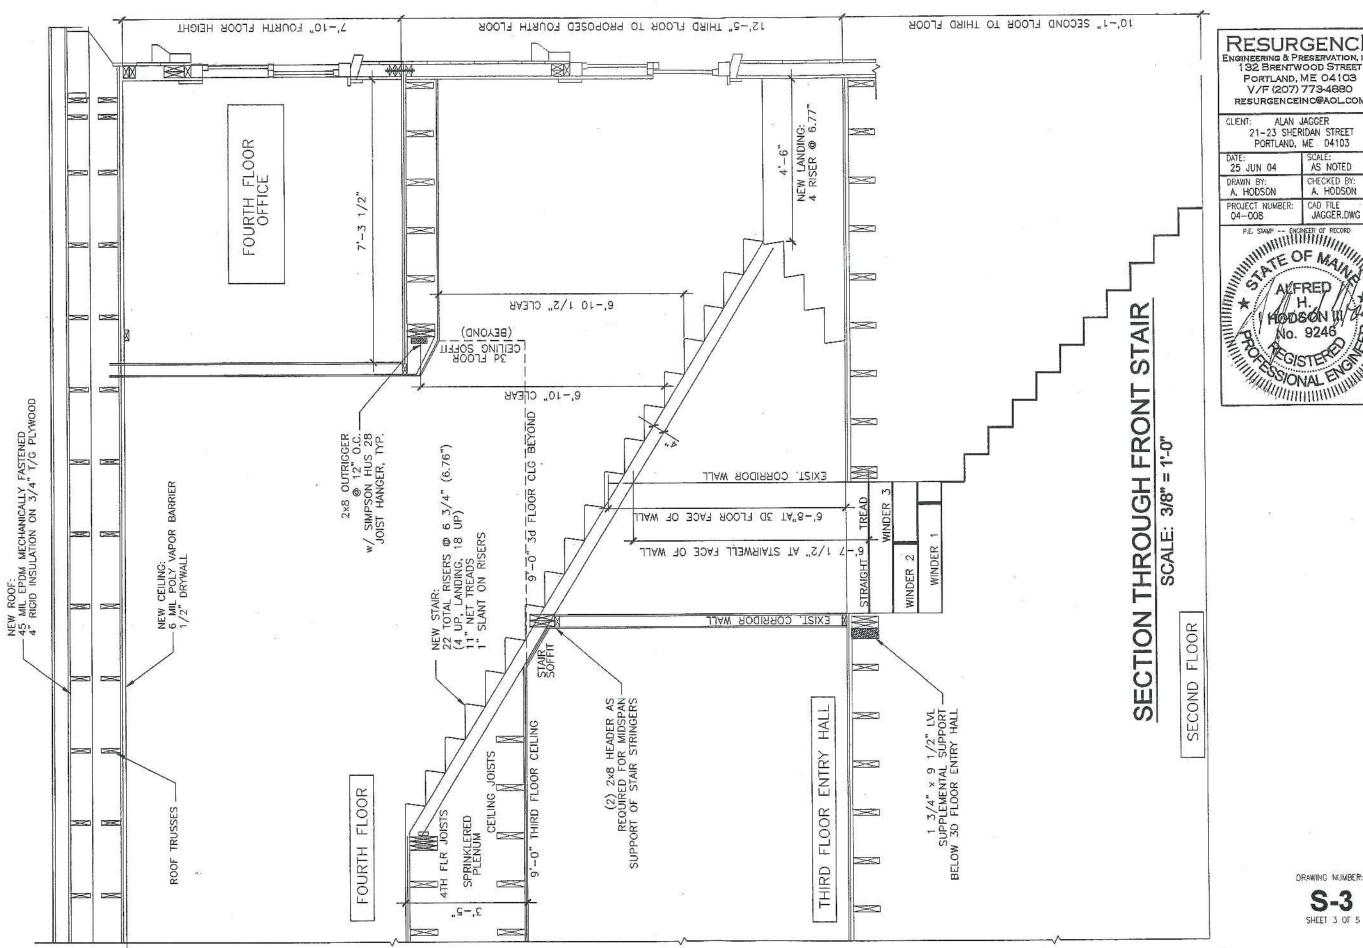

RESURGENCE
ENGINEERING & PRESERVATION, INC.
192 BRENTWOOD STREET
PORTLAND, ME 04103
V/F (207) 779-4880 RESURGENCEINC@AOL.COM

CHECKED BY: A, HODSON CAD FILE JAGGER.DWG

**S-3** 

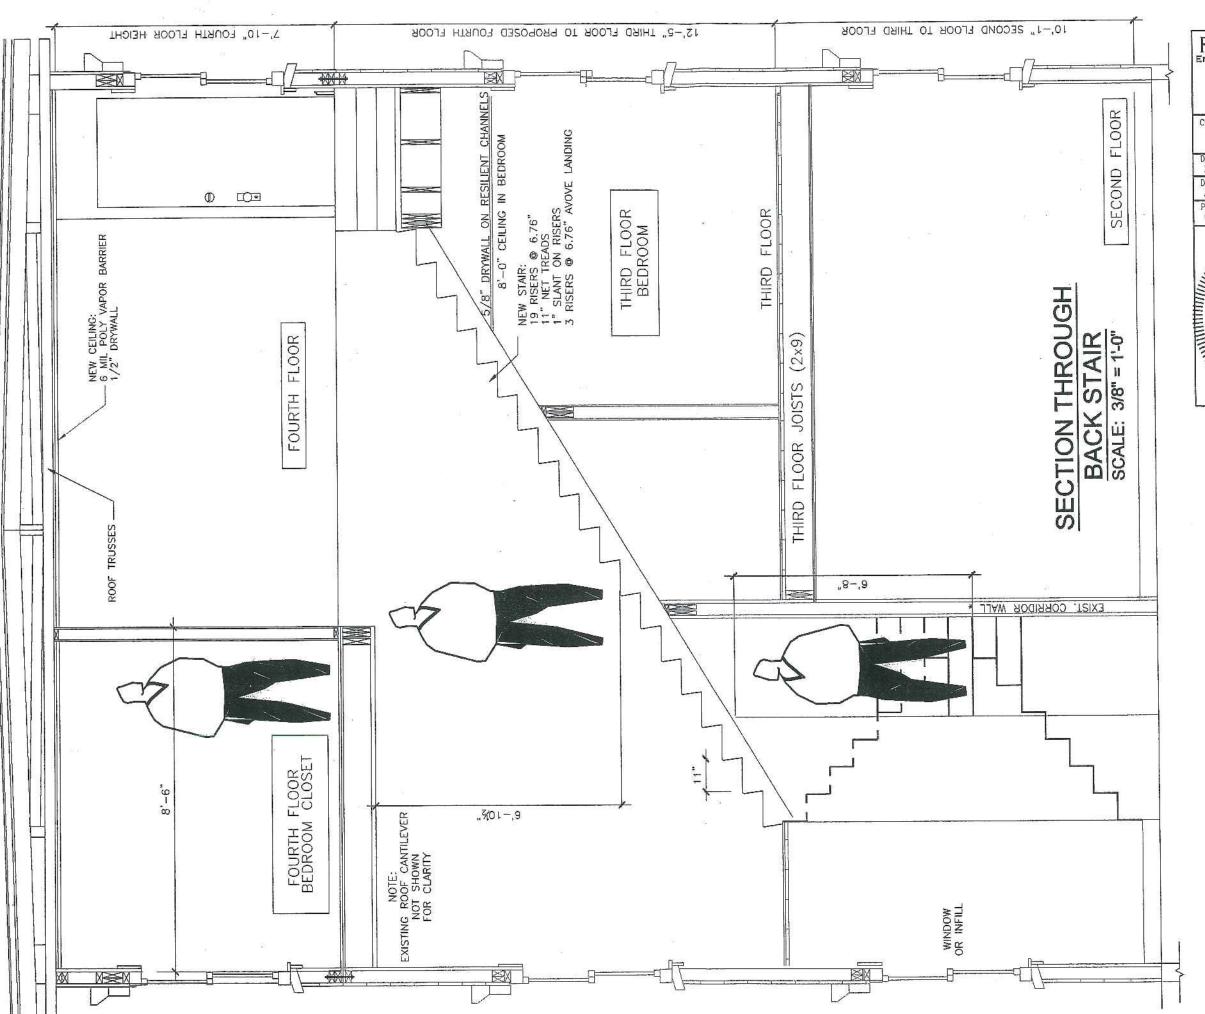


RESURGENCE
ENGINEERING & PRESERVATION, INC.
132 BRENTWOOD STREET
PORTLAND, ME 04103
V/F (207) 773-4880
RESURGENCEINC@AOL.COM

CLIENT: ALAN JAGGER 21–23 SHERIDAN STREET PORTLAND, ME 04103

DATE:
25 JUN 04 AS NOTED


DRAWN BY:
A. HODSON A. HODSON


PROJECT NUMBER: CAD FILE
04-008 JAGGER.DWG

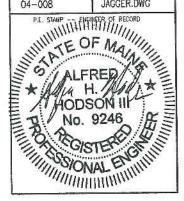


DRAWING NUMBER:

S-4 SHEET 4 OF 5

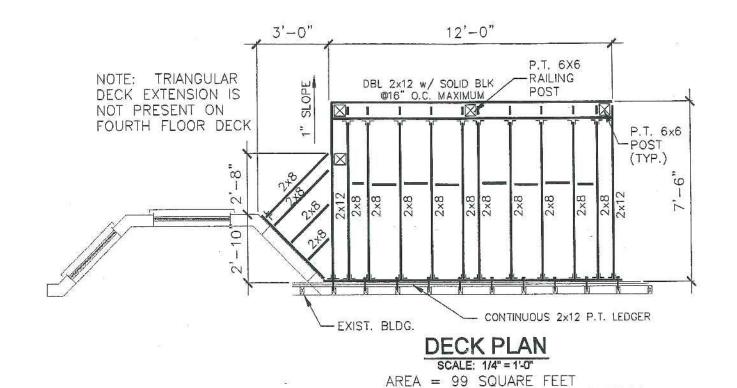

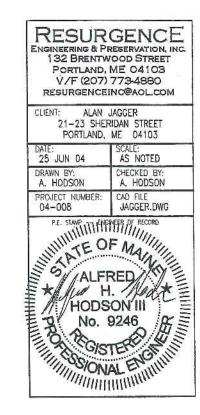


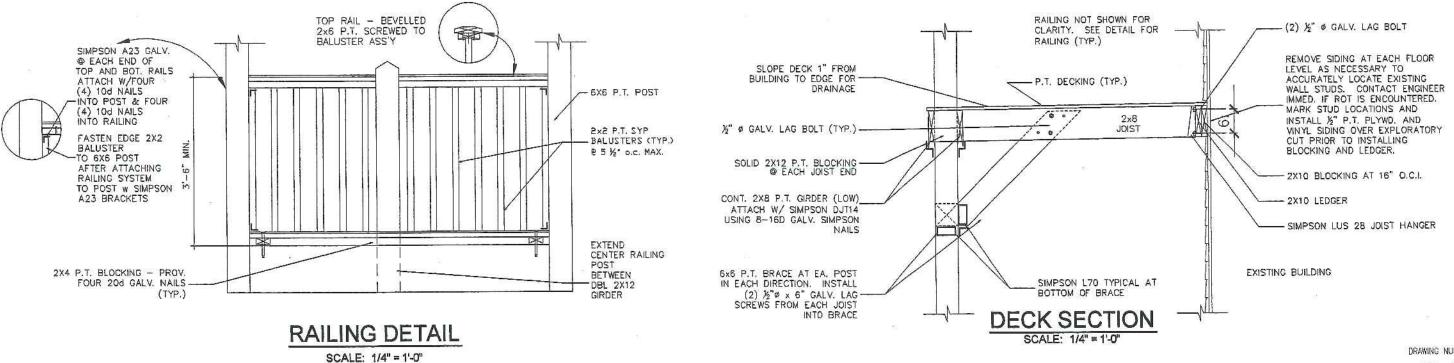


SEE DETAILS THIS SHEET FOR RAILINGS

DRAWING NUMBER:

**S-5** SHEET 5 OF 5

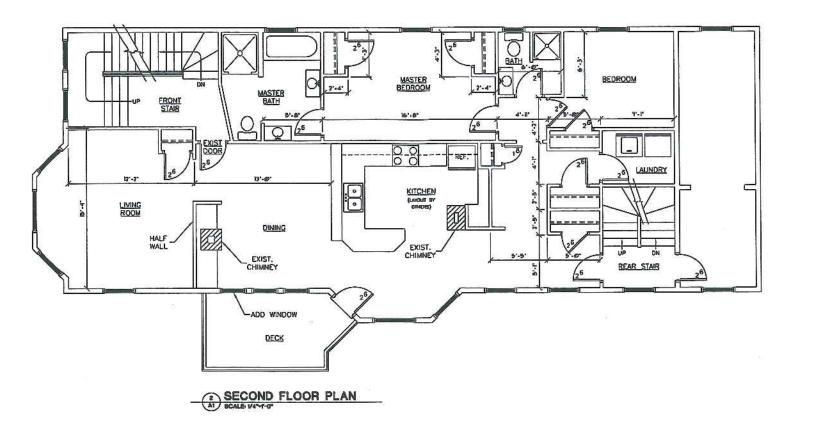

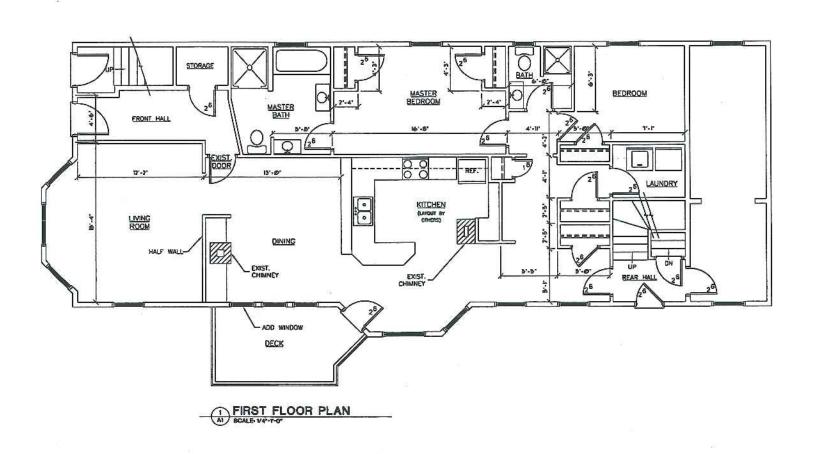

STREET 04101 SHERIDAN PORTLAND, MAINE 21-23

PROPERTY OF

REVS.

CODE: 1999


TOWN- PORTLAND DATE: 21 JULY 04

SCALE AS NOTED DRAWN TJF/P8

TITLE FIRST AND SECOND FLOOR PLANS

FILE: 04-0035


SHEET! A1

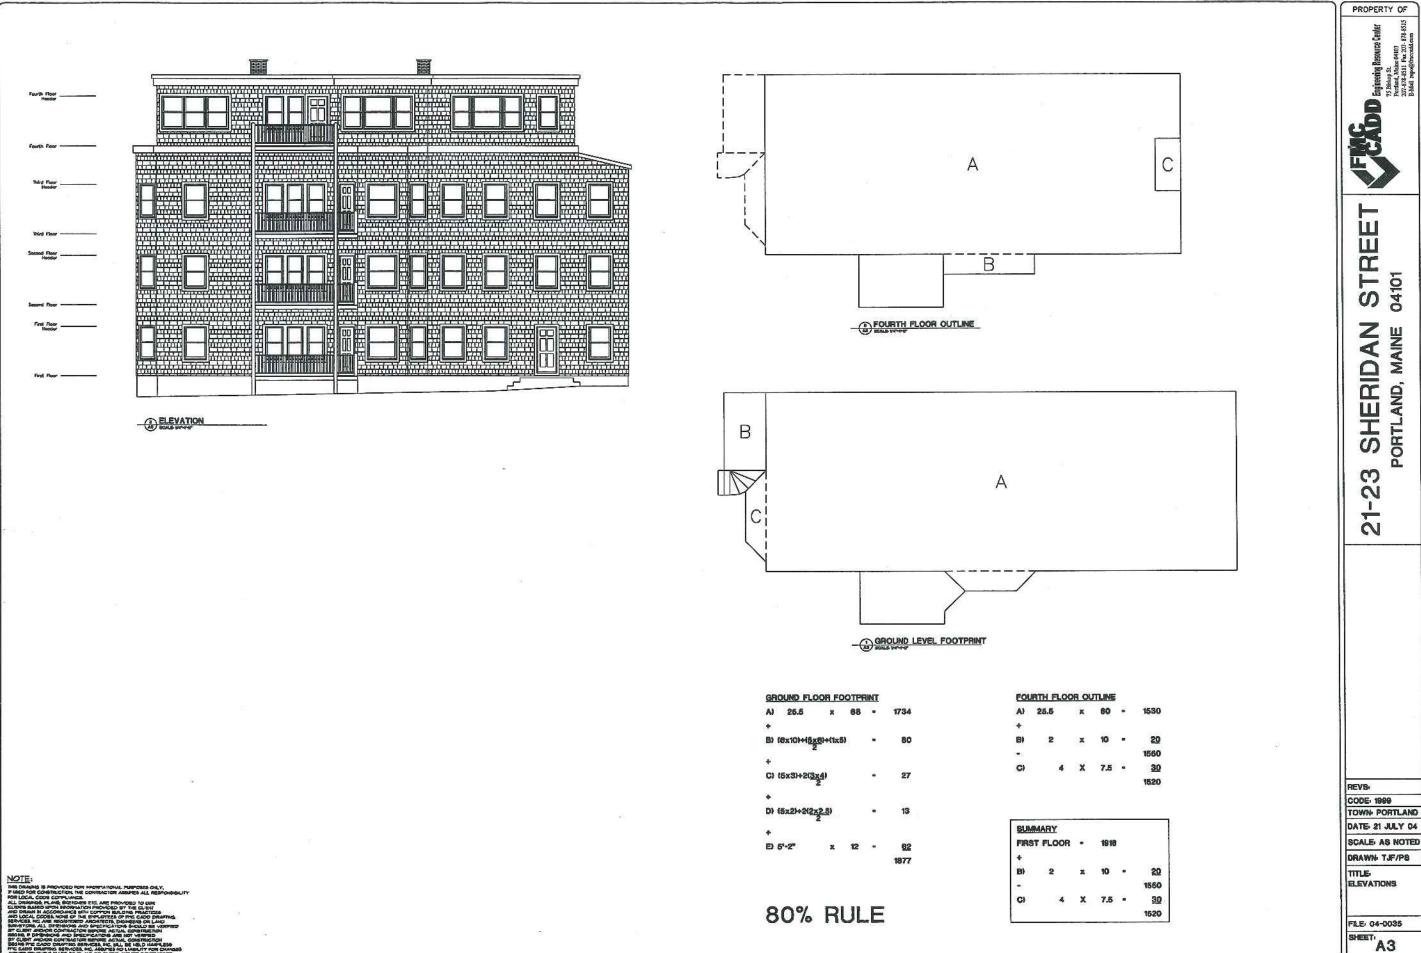

STREET 04101

S SHERIDAN PORTLAND, MAINE

21-23

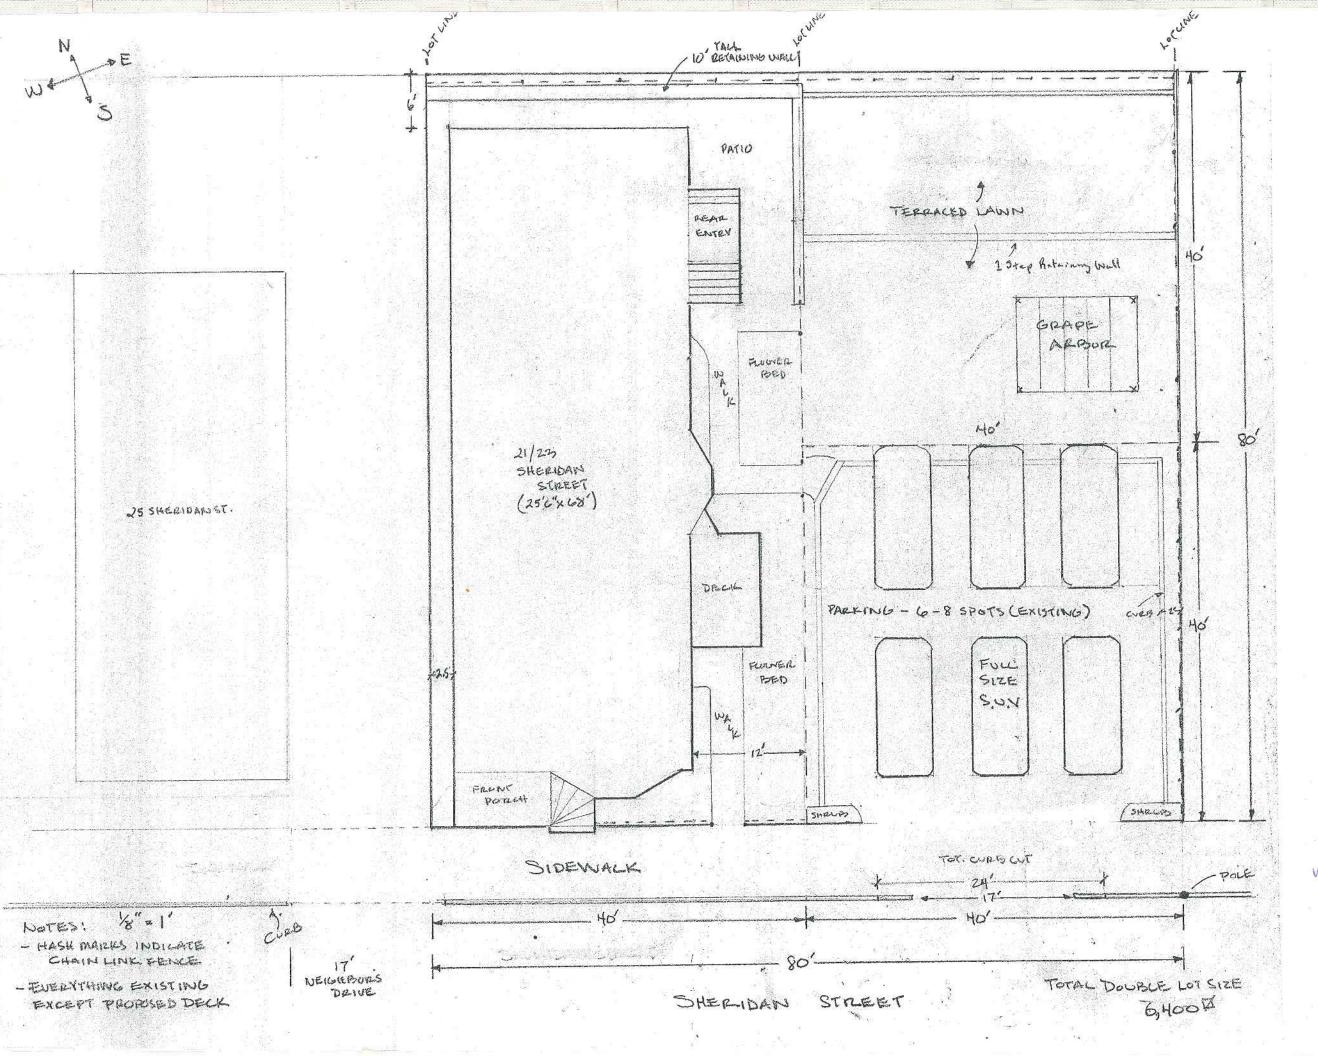

SITE PLAN 21/23 SHERIDAN ST. 17-f-Zu/21

when 3 units