# NEW HOUSE

## PROJECT INFORMATION

Client: Craig Bramley & Kim Simmons

**Architect:** Kaplan Thompson Architects

Contractor: Redfern Properties

Site legal description: CCRD Plan Book 211, Page 17

Project Address: 71 Quebec Street, Portland, ME, 04101,

### ZONING INFORMATION

**Zoning:** R6

Min. Allowable Lot size: 4,500 SF

**Actual Site Area:** +/- 4,519 SF (+/- 0.10 acre)

Min. Front Yard Setback: 10'-0" (but need not exceed the average depth of front yards on either side of the lot)

Min. Side Yard Setback: 10'-0" (per 3-storey building)

Min. Rear Yard Setback: 20'-0"

Max. Allowable Building Height: 45'-0" (to mid point of pitched roof)

**Applicable Building Codes:** IRC 2009 IEC 2009 NFPA -101 2009

#### PROPOSED STRUCTURE

**Proposed Occupancy:** Single Family Residential

**Proposed Floor Area:** 525 sf 1st. floor 1,295 sf 2nd. floor

1,080 sf 3rd. floor Half-story 400 sf

 $3,\overline{300}$  sf Total conditioned floor area

Garage (unconditioned)

Storage (unconditioned)
Total Floor Area of Structure (gross) 3,785 sf

**Proposed Sprinkler:** NFPA 13D throughout

Proposed Elevator: Residential, 3-stop

**Attached Garage:** Yes

Proposed Building Height:

3-Storeys (plus an additional Half-story above per Section 14-47)


A half story "... is a story situated under a sloping roof, the area which at a height four (4) feet above the floor does not exceed two-thirds of the floor area of the story immediately below it and which does not contain an independent apartment or dwelling unit."

**ISSUED FOR PERMIT** NOT FOR CONSTRUCTION CRAIG BRAMLEY & KIM SIMMONS, A

PROJECT: NEW HOUSE, FOR CRAIG BRAMLEY & KIM SIMMONS, AT DRAWING: COVER SHEET


REVISED: OCTOBER 06



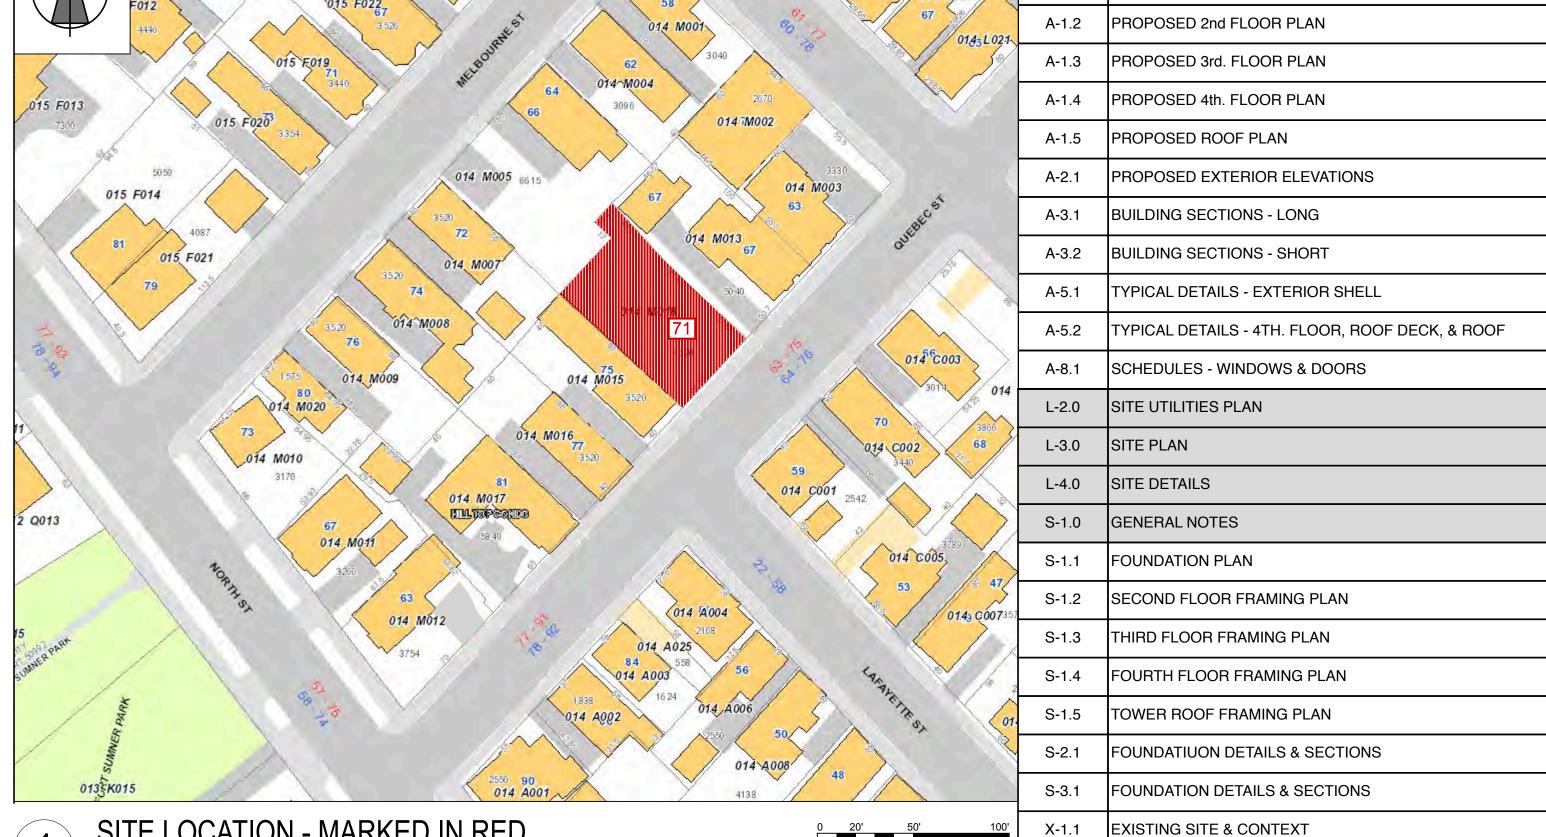


DRAWING INDEX

COVER SHEET

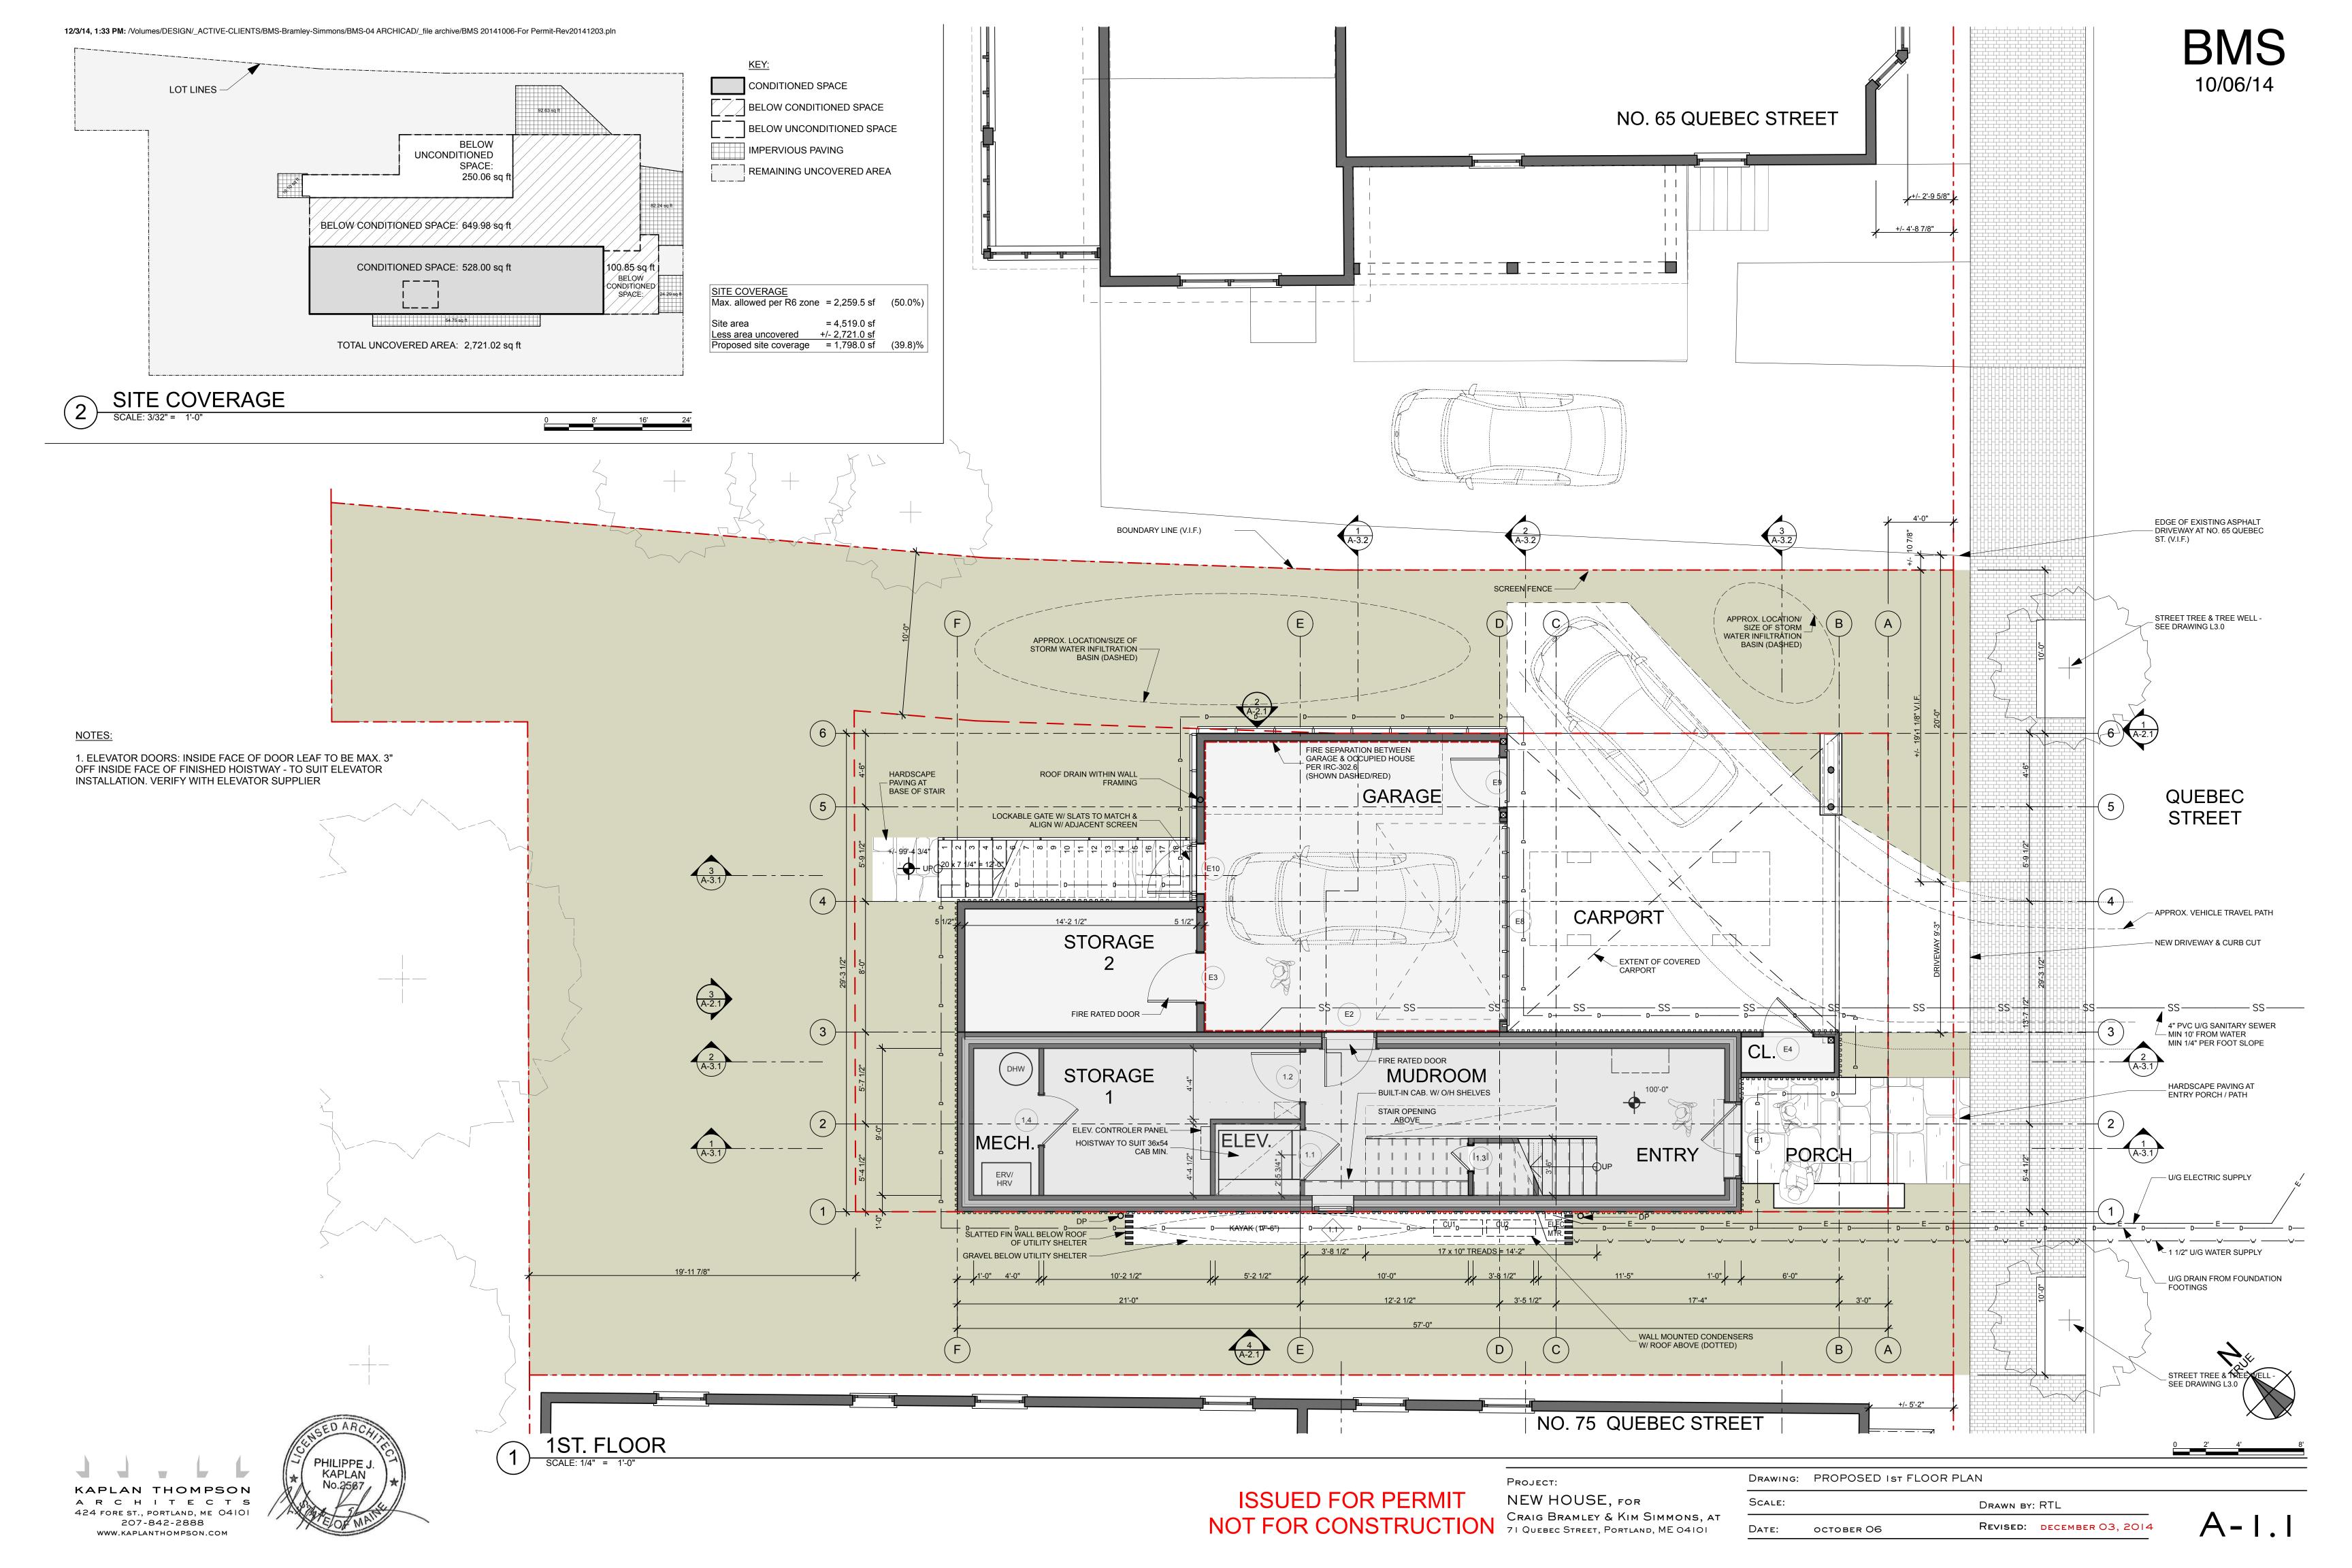




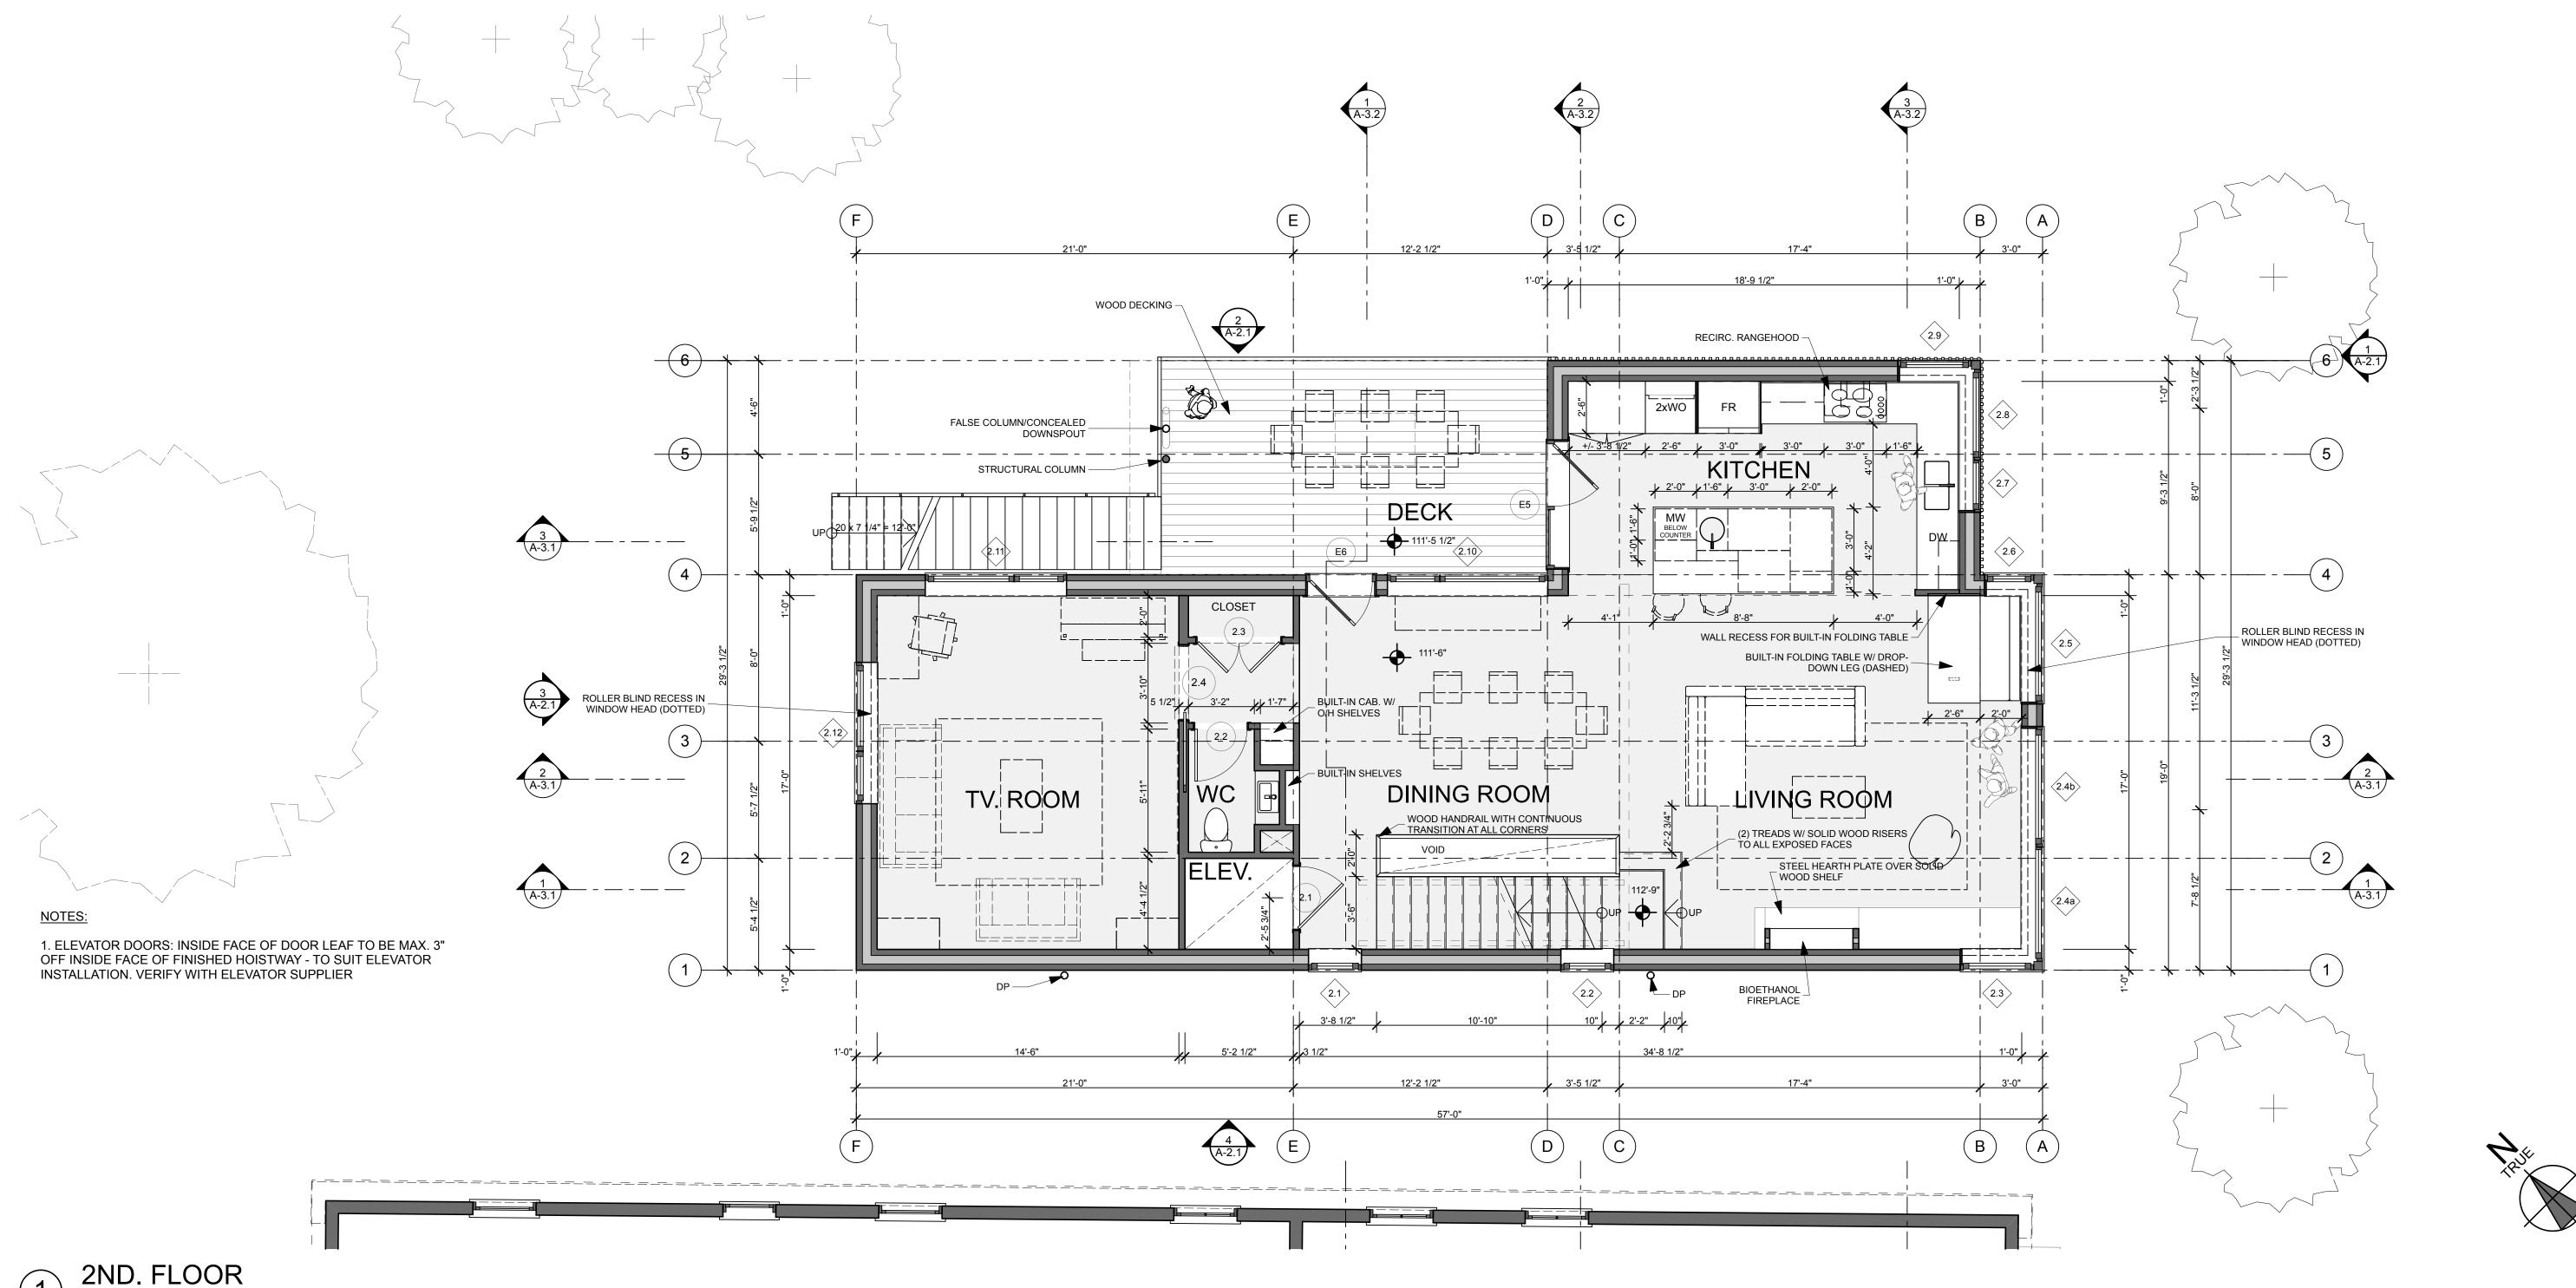

2ND. FLOOR

SCALE: 1/4" = 1'-0"

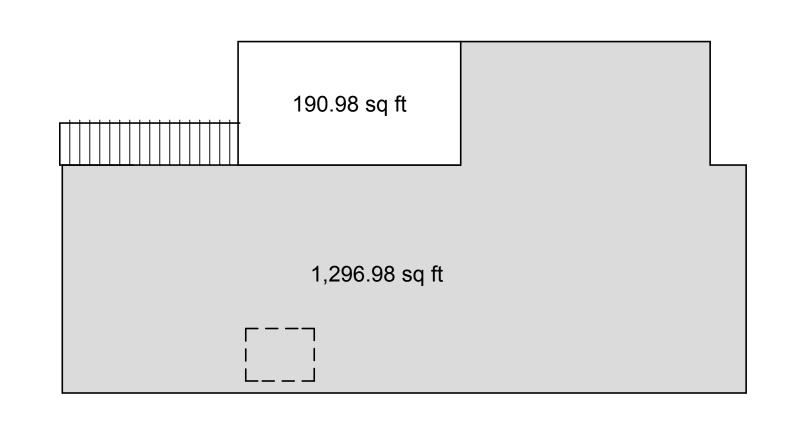

GROSS AREA

SCALE: 1/8" = 1'-0"




**ISSUED FOR PERMIT** NOT FOR CONSTRUCTION CRAIG BRAMLEY & KIM SIMMONS, AT 71 QUEBEC STREET, PORTLAND, ME 04101

PROJECT: NEW HOUSE, FOR

KITCHEN OPTION A Drawing: PROPOSED 2nd FLOOR PLAN DRAWN BY: RTL REVISED: Date: october 06



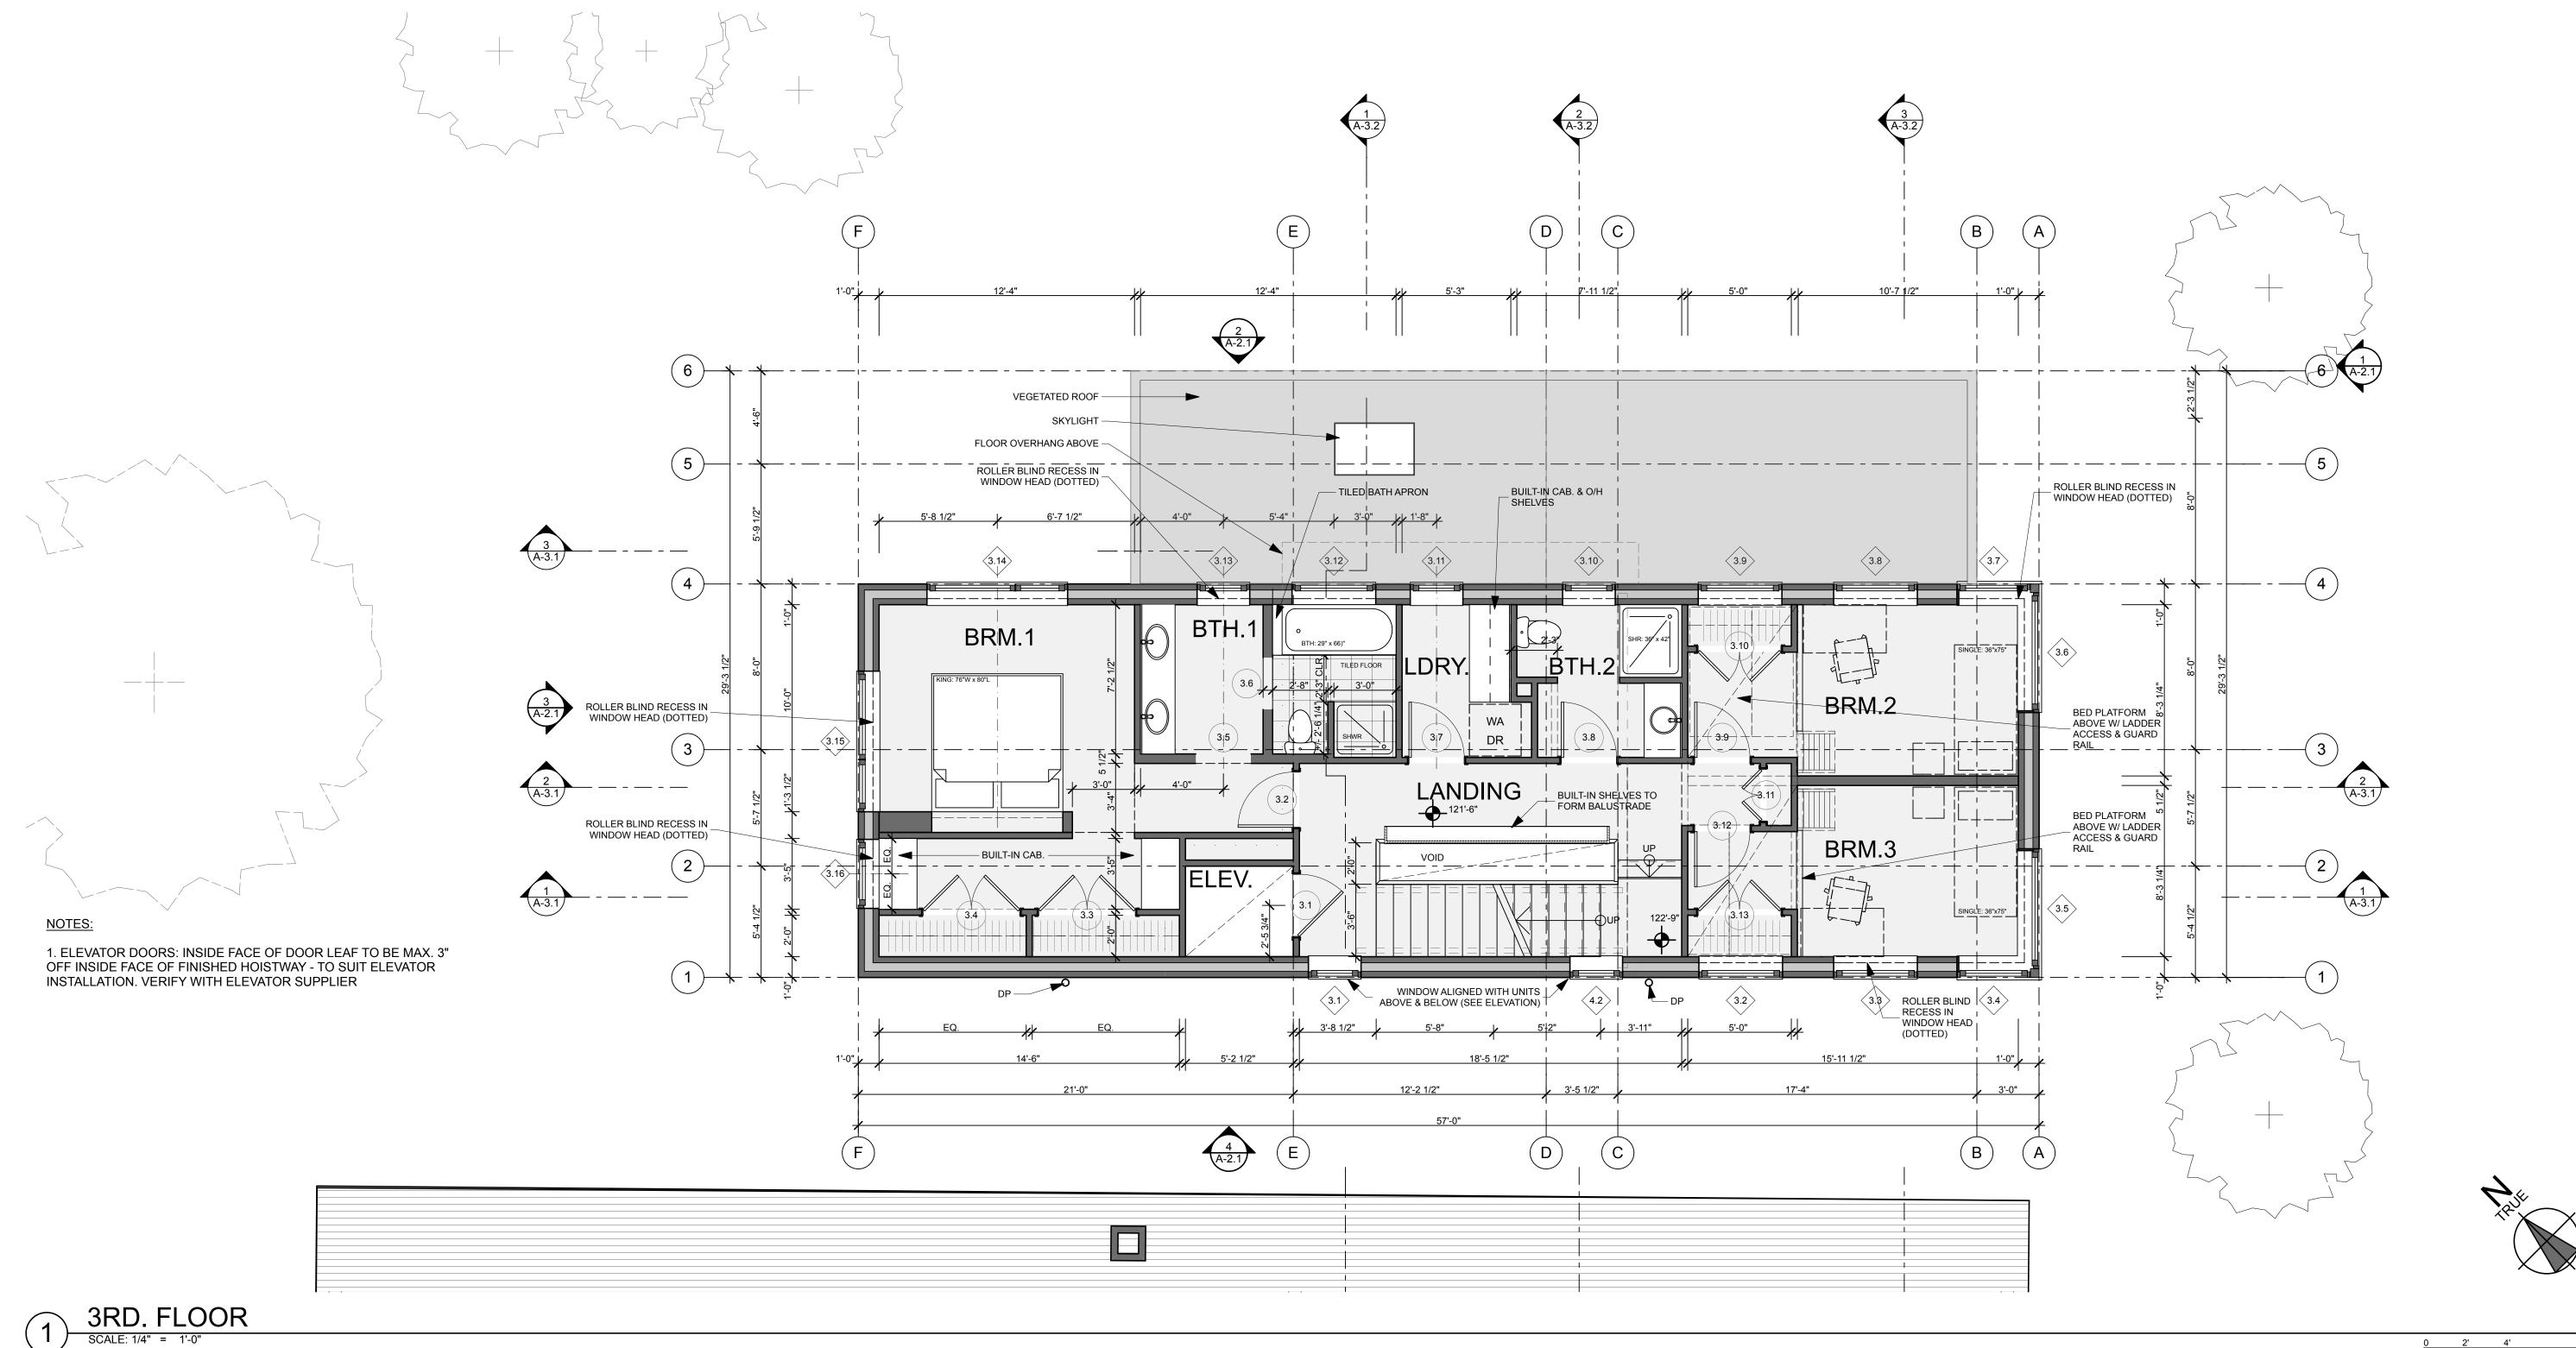

421.57 sq ft

1,083.00 sq ft

KAPLAN THOMPSON A R C H I T E C T S 424 FORE ST., PORTLAND, ME 04101 207-842-2888 WWW.KAPLANTHOMPSON.COM


GROSS AREA

SCALE: 1/8" = 1'-0" **ISSUED FOR PERMIT** 

PROJECT: NEW HOUSE, FOR NOT FOR CONSTRUCTION CRAIG BRAMLEY & KIM SIMMONS, AT 71 QUEBEC STREET, PORTLAND, ME 04101

DRAWING: PROPOSED 3RD. FLOOR PLAN DRAWN BY: RTL REVISED: Date: october 06



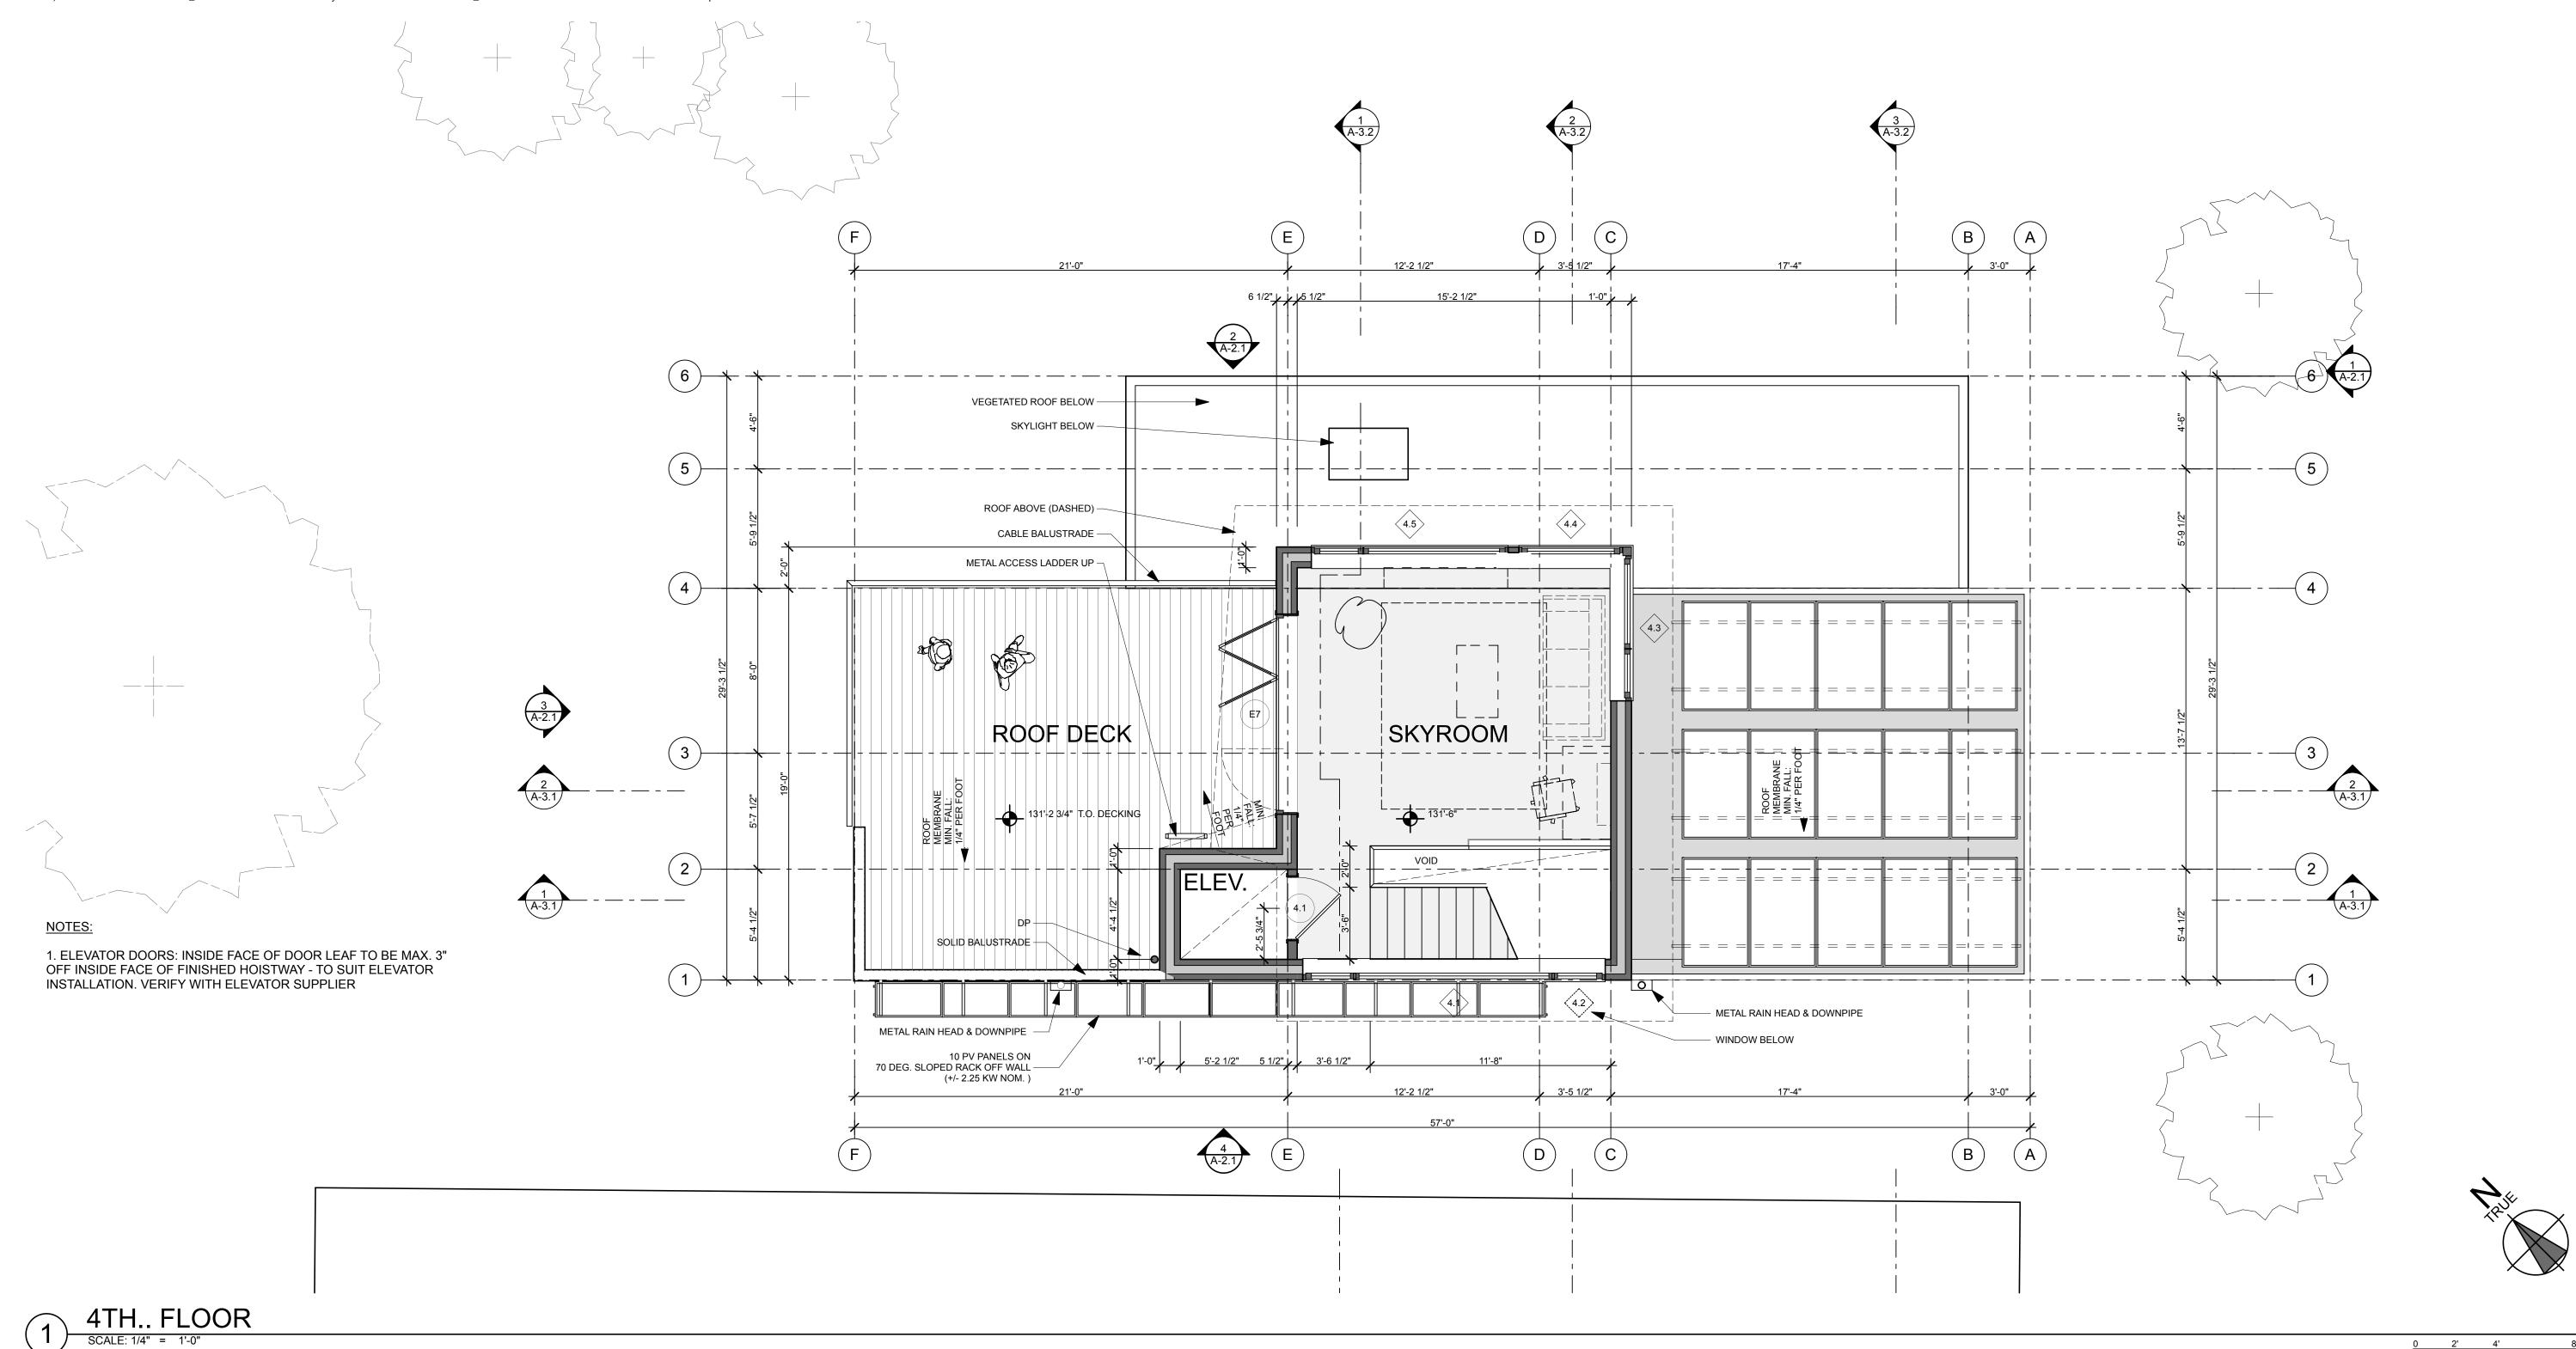

400.69 sq ft 367.33 sq ft 349.40 sq ft

KAPLAN THOMPSON
A R C H I T E C T S
424 FORE ST., PORTLAND, ME 04101
207-842-2888 WWW.KAPLANTHOMPSON.COM

GROSS AREA


SCALE: 1/8" = 1'-0"

Project: NEW HOUSE, FOR Drawing: PROPOSED 4th. FLOOR PLAN DRAWN BY: RTL REVISED: Date: october 06

A-1.4

ROOF PLAN

SCALE: 1/4" = 1'-0"

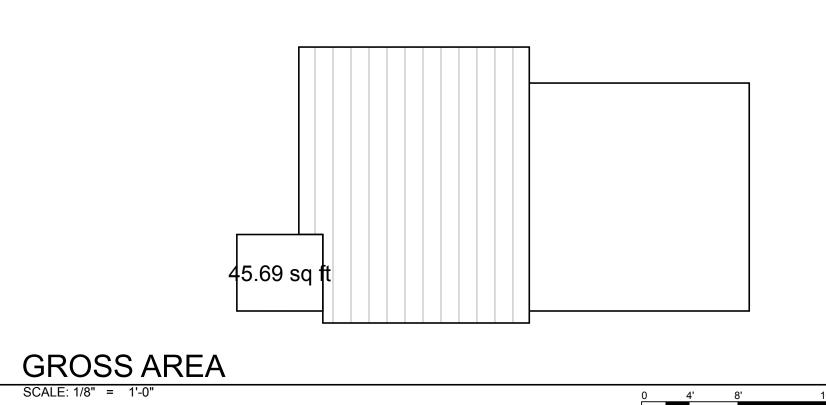




Project: NEW HOUSE, FOR

Drawing:	PROPOSED ROOF PLAN						
Scale:		Drawn by: RTL					
DATE:	OCTOBER O6	REVISED:					


A-1.5




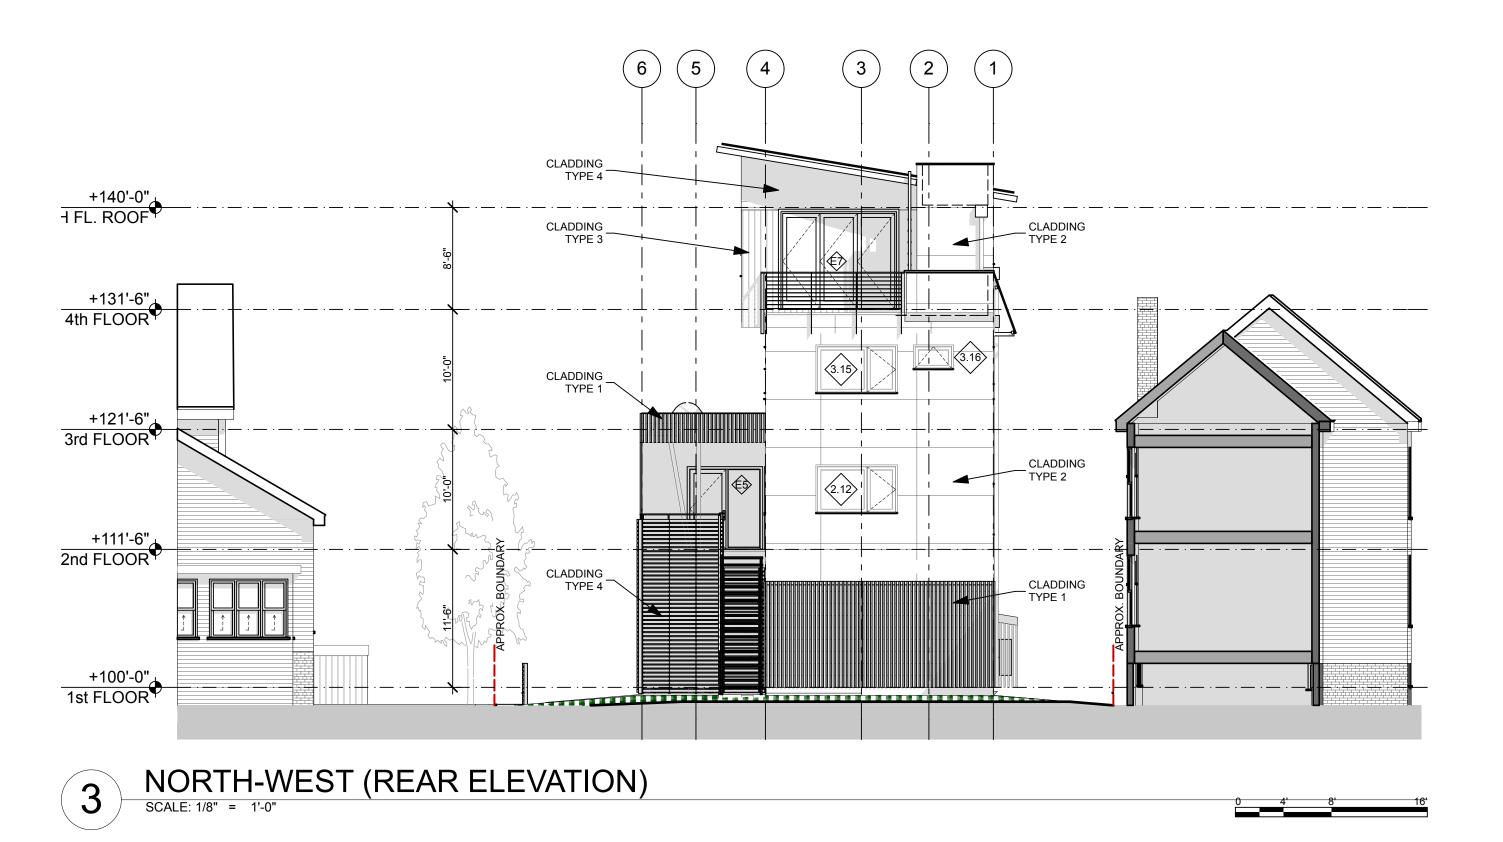


CLADDING TYPE 1: FIBER CEMENT BATTENS (VERTICAL), PAINT FINISH CLADDING TYPE 2: FIBER CEMENT PANELS (4'x8'), PAINT FINISH CLADDING TYPE 3: CEDAR BOARDS (VERT.), NATURAL FINISH CLADDING TYPE 4: CEDAR BOARDS (HORIZ.), NATURAL FINISH



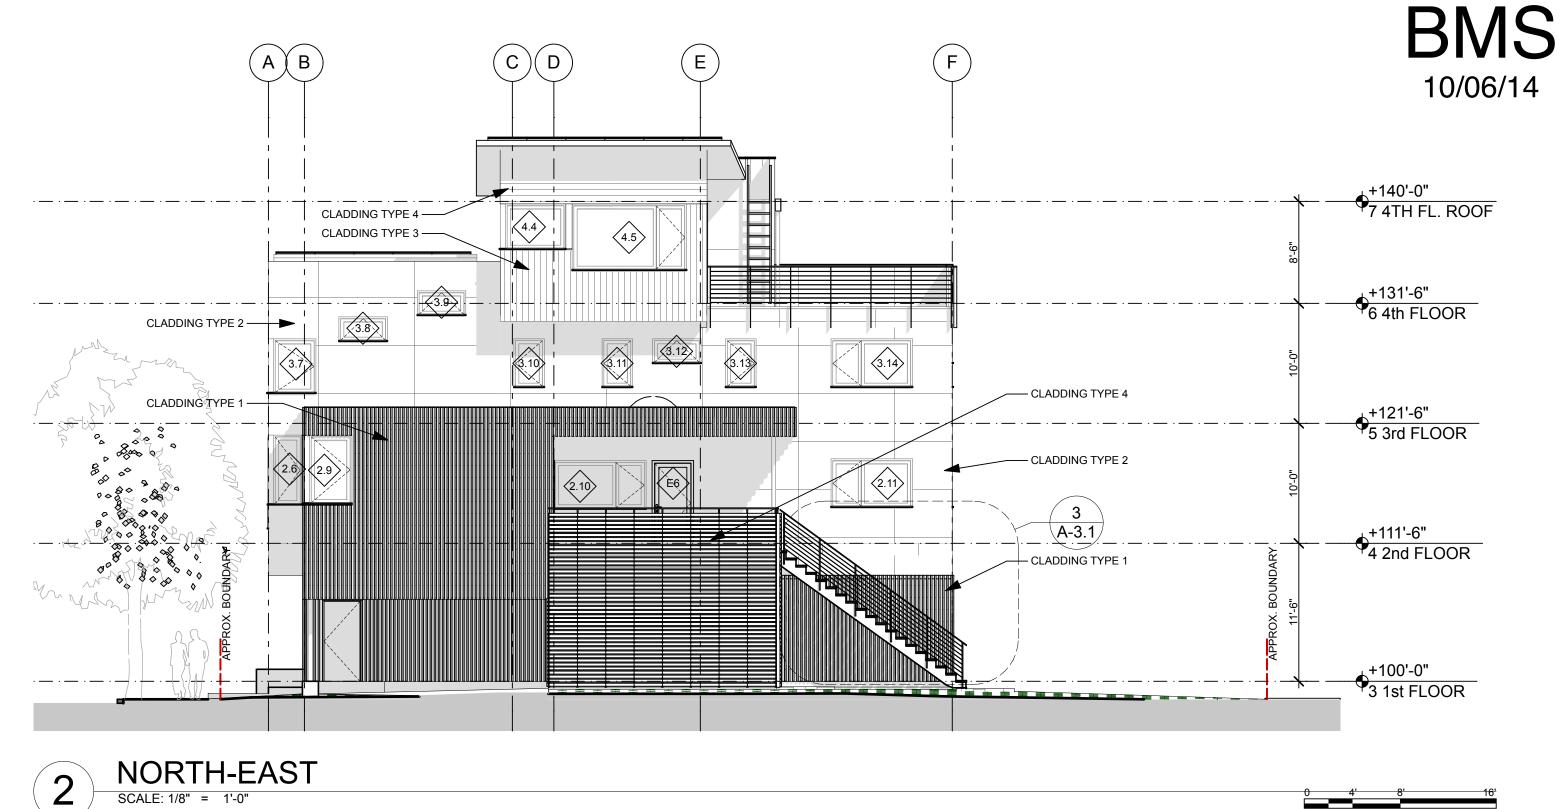


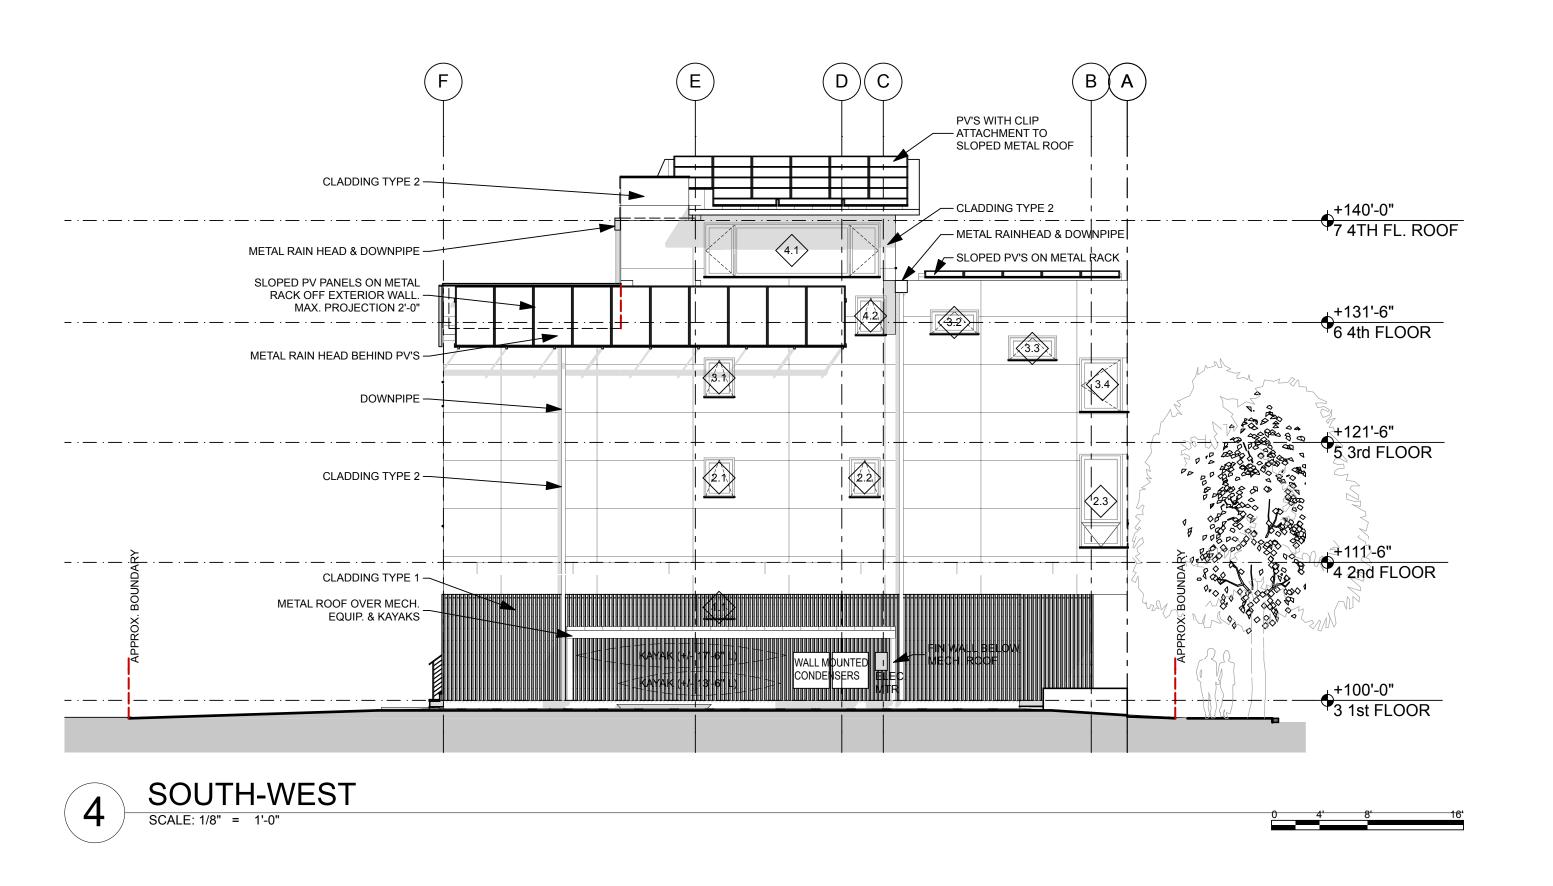

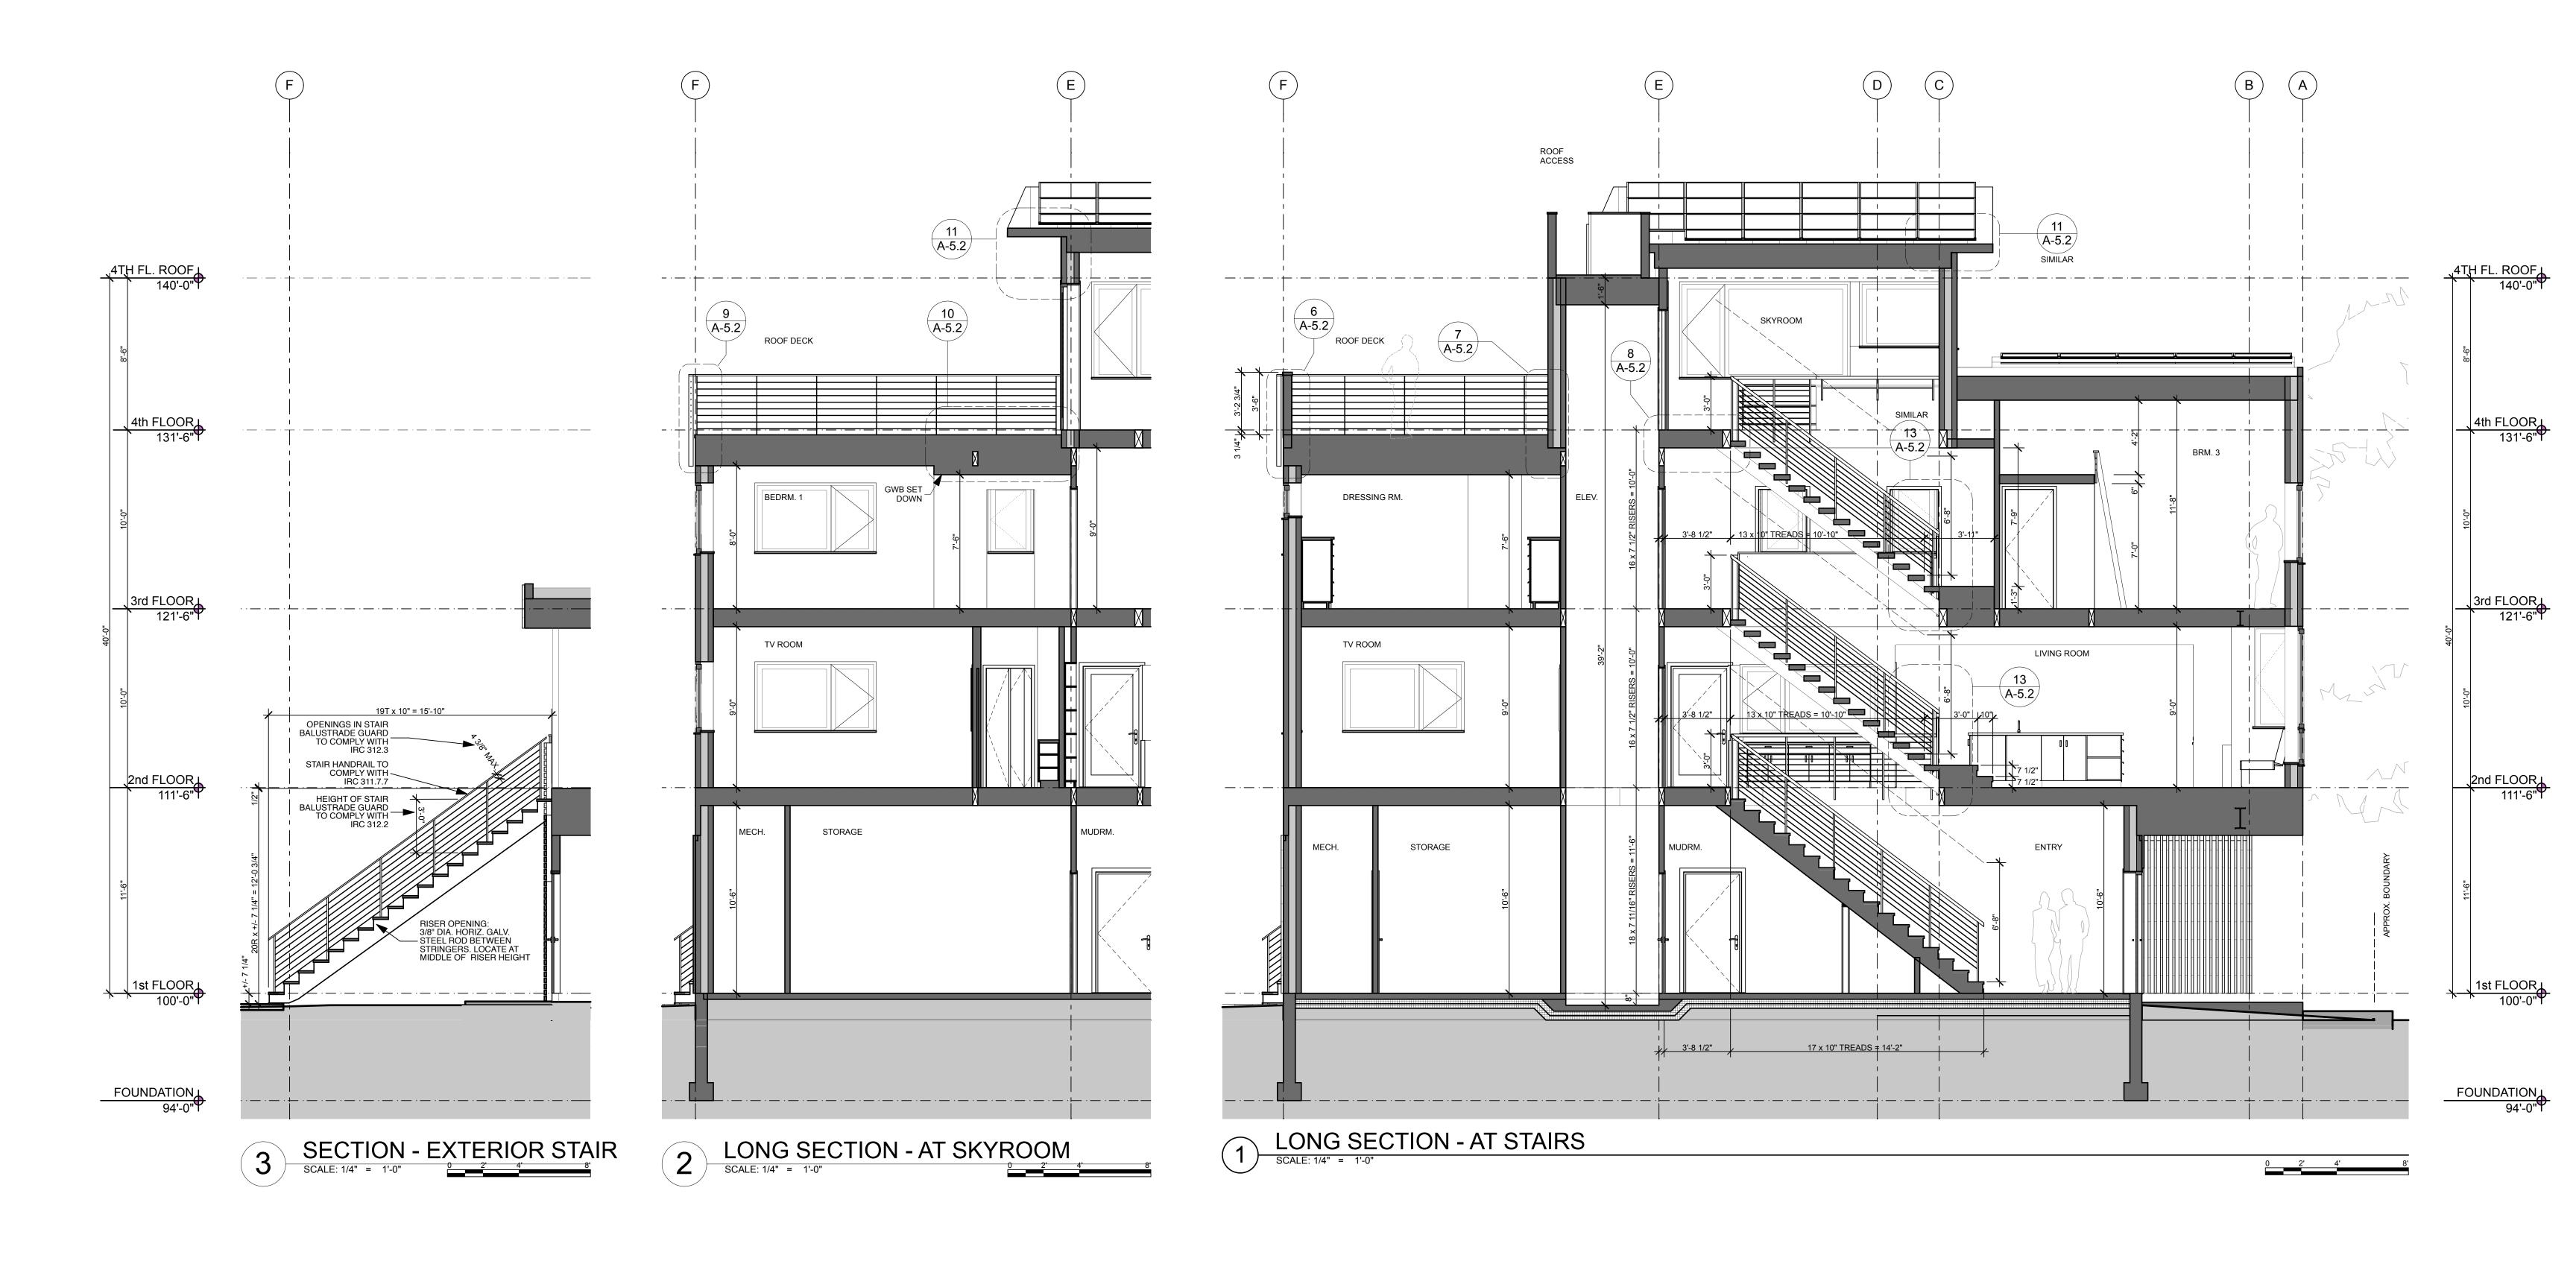



PROJECT: NEW HOUSE, FOR NOT FOR CONSTRUCTION CRAIG BRAMLEY & KIM SIMMONS, AT 71 QUEBEC STREET, PORTLAND, ME 04101 DRAWING: BUILDING SECTIONS - LONG DRAWN BY: RTL A-3.1 REVISED: Date: october 06

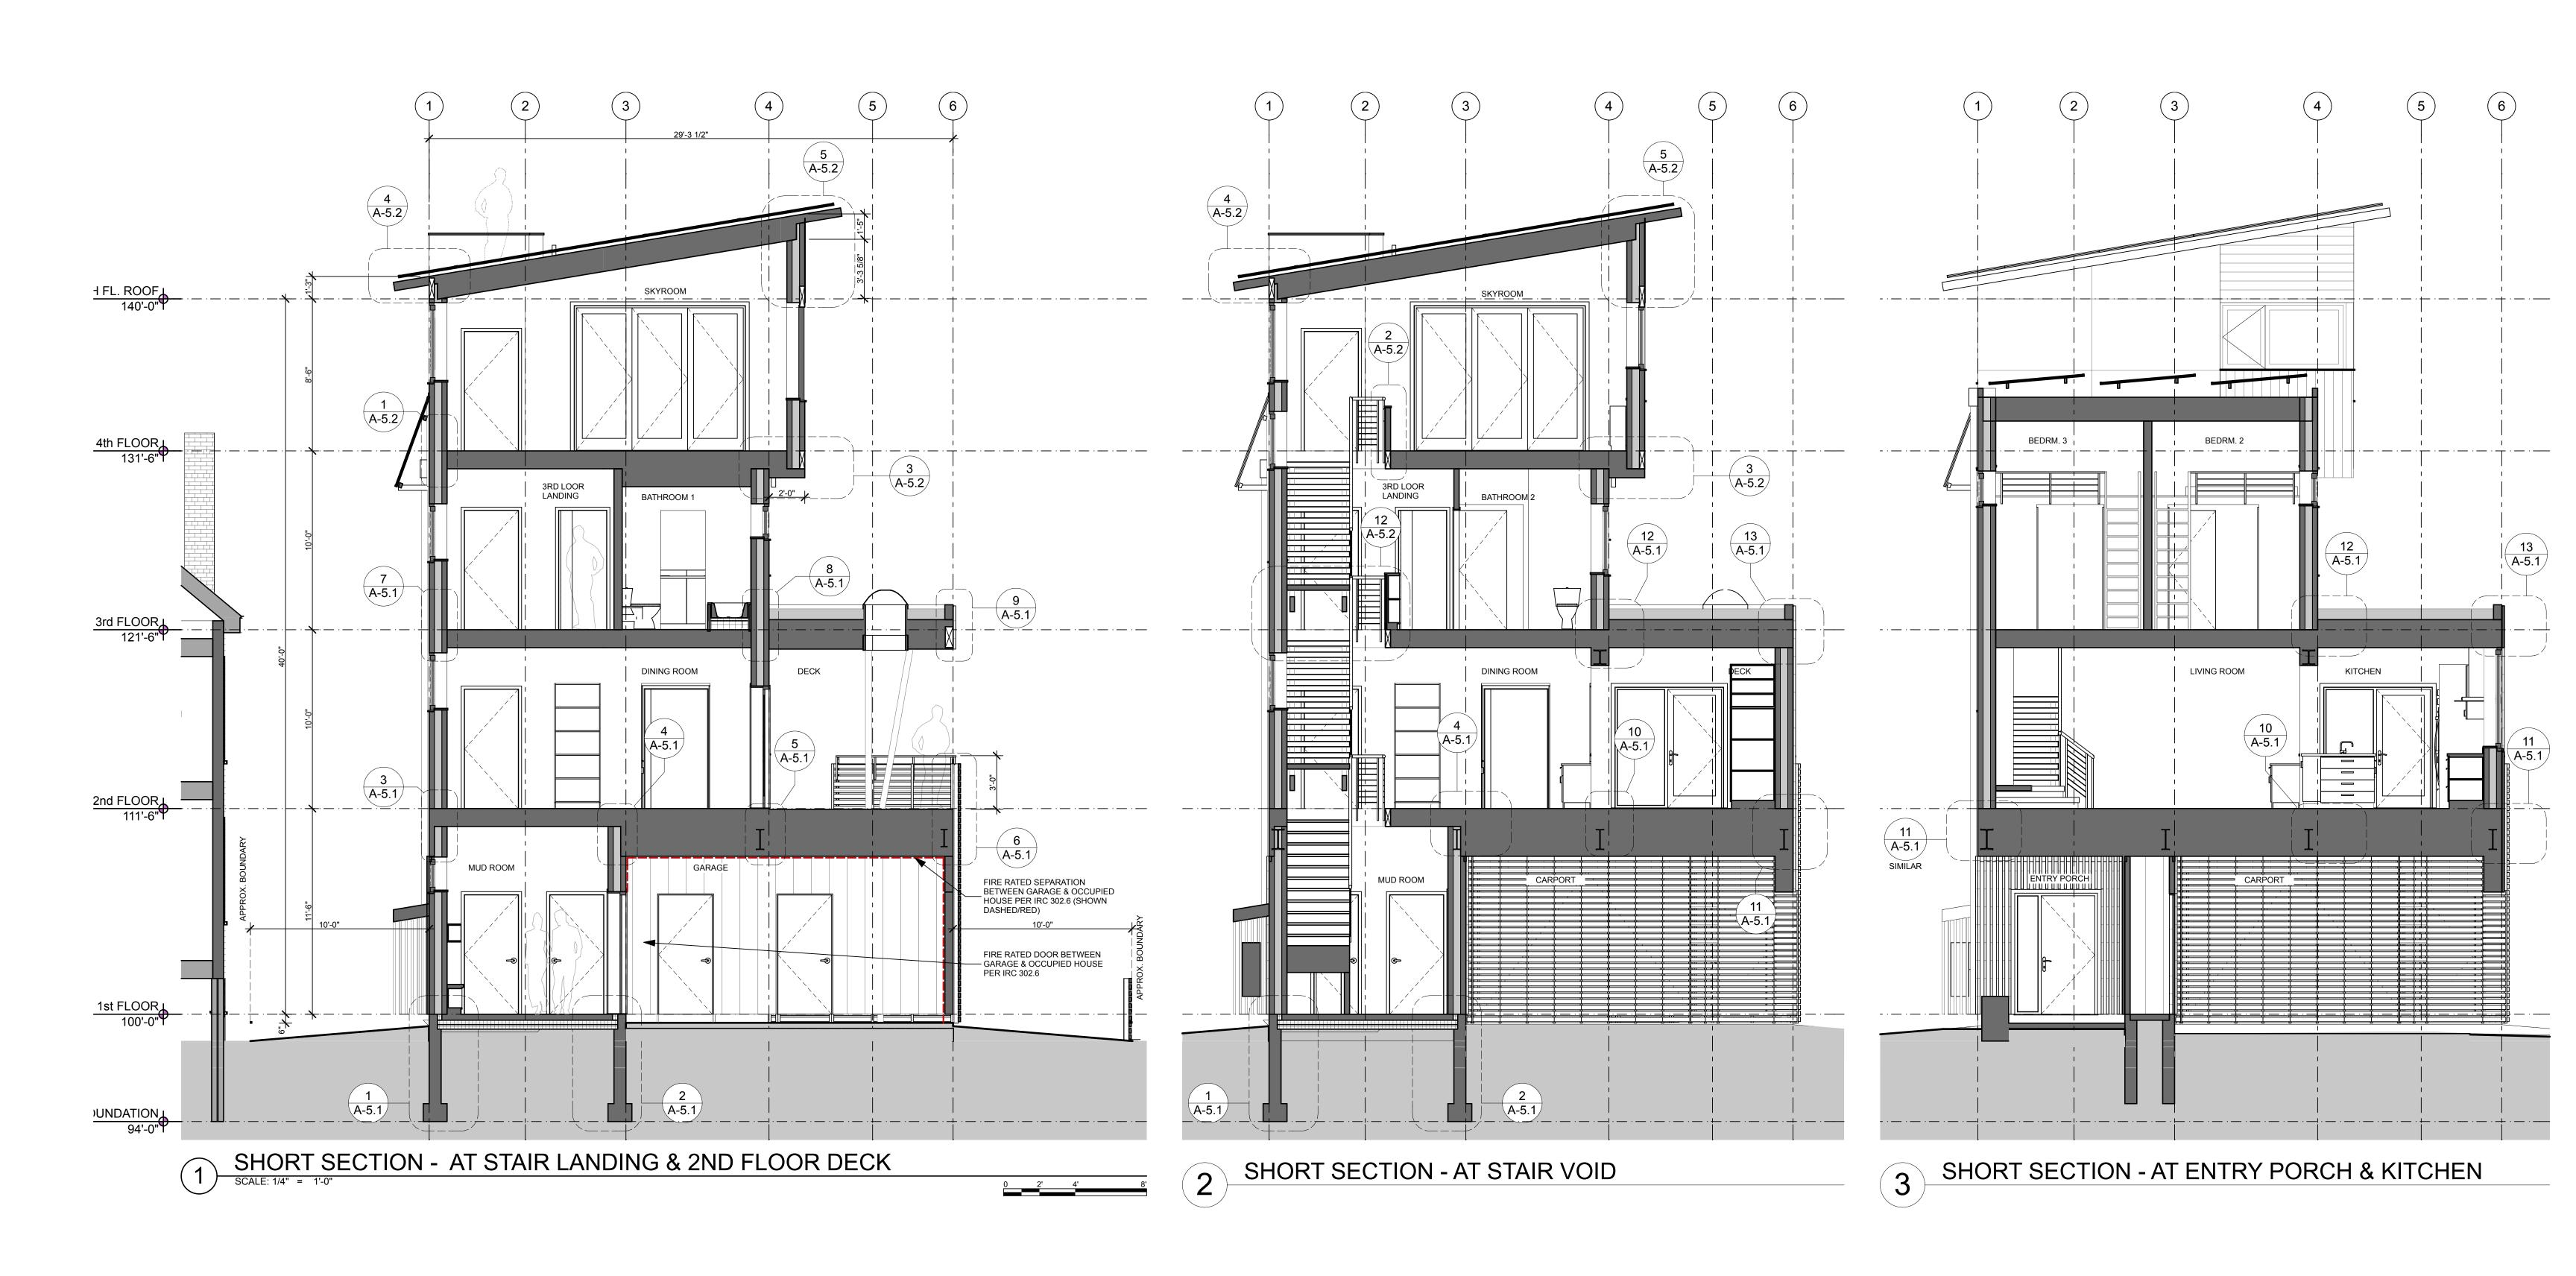



PROJECT:

ISSUED FOR PERMIT

NOT FOR CONSTRUCTION

PROJECT:


NEW HOUSE, FOR

CRAIG BRAMLEY & KIM SIMMONS, AT
71 QUEBEC STREET, PORTLAND, ME 04101

DRAWING: BUILDING SECTIONS - SHORT

Scale: Drawn by: RTL


Date: October 06 Revised: A-3.2

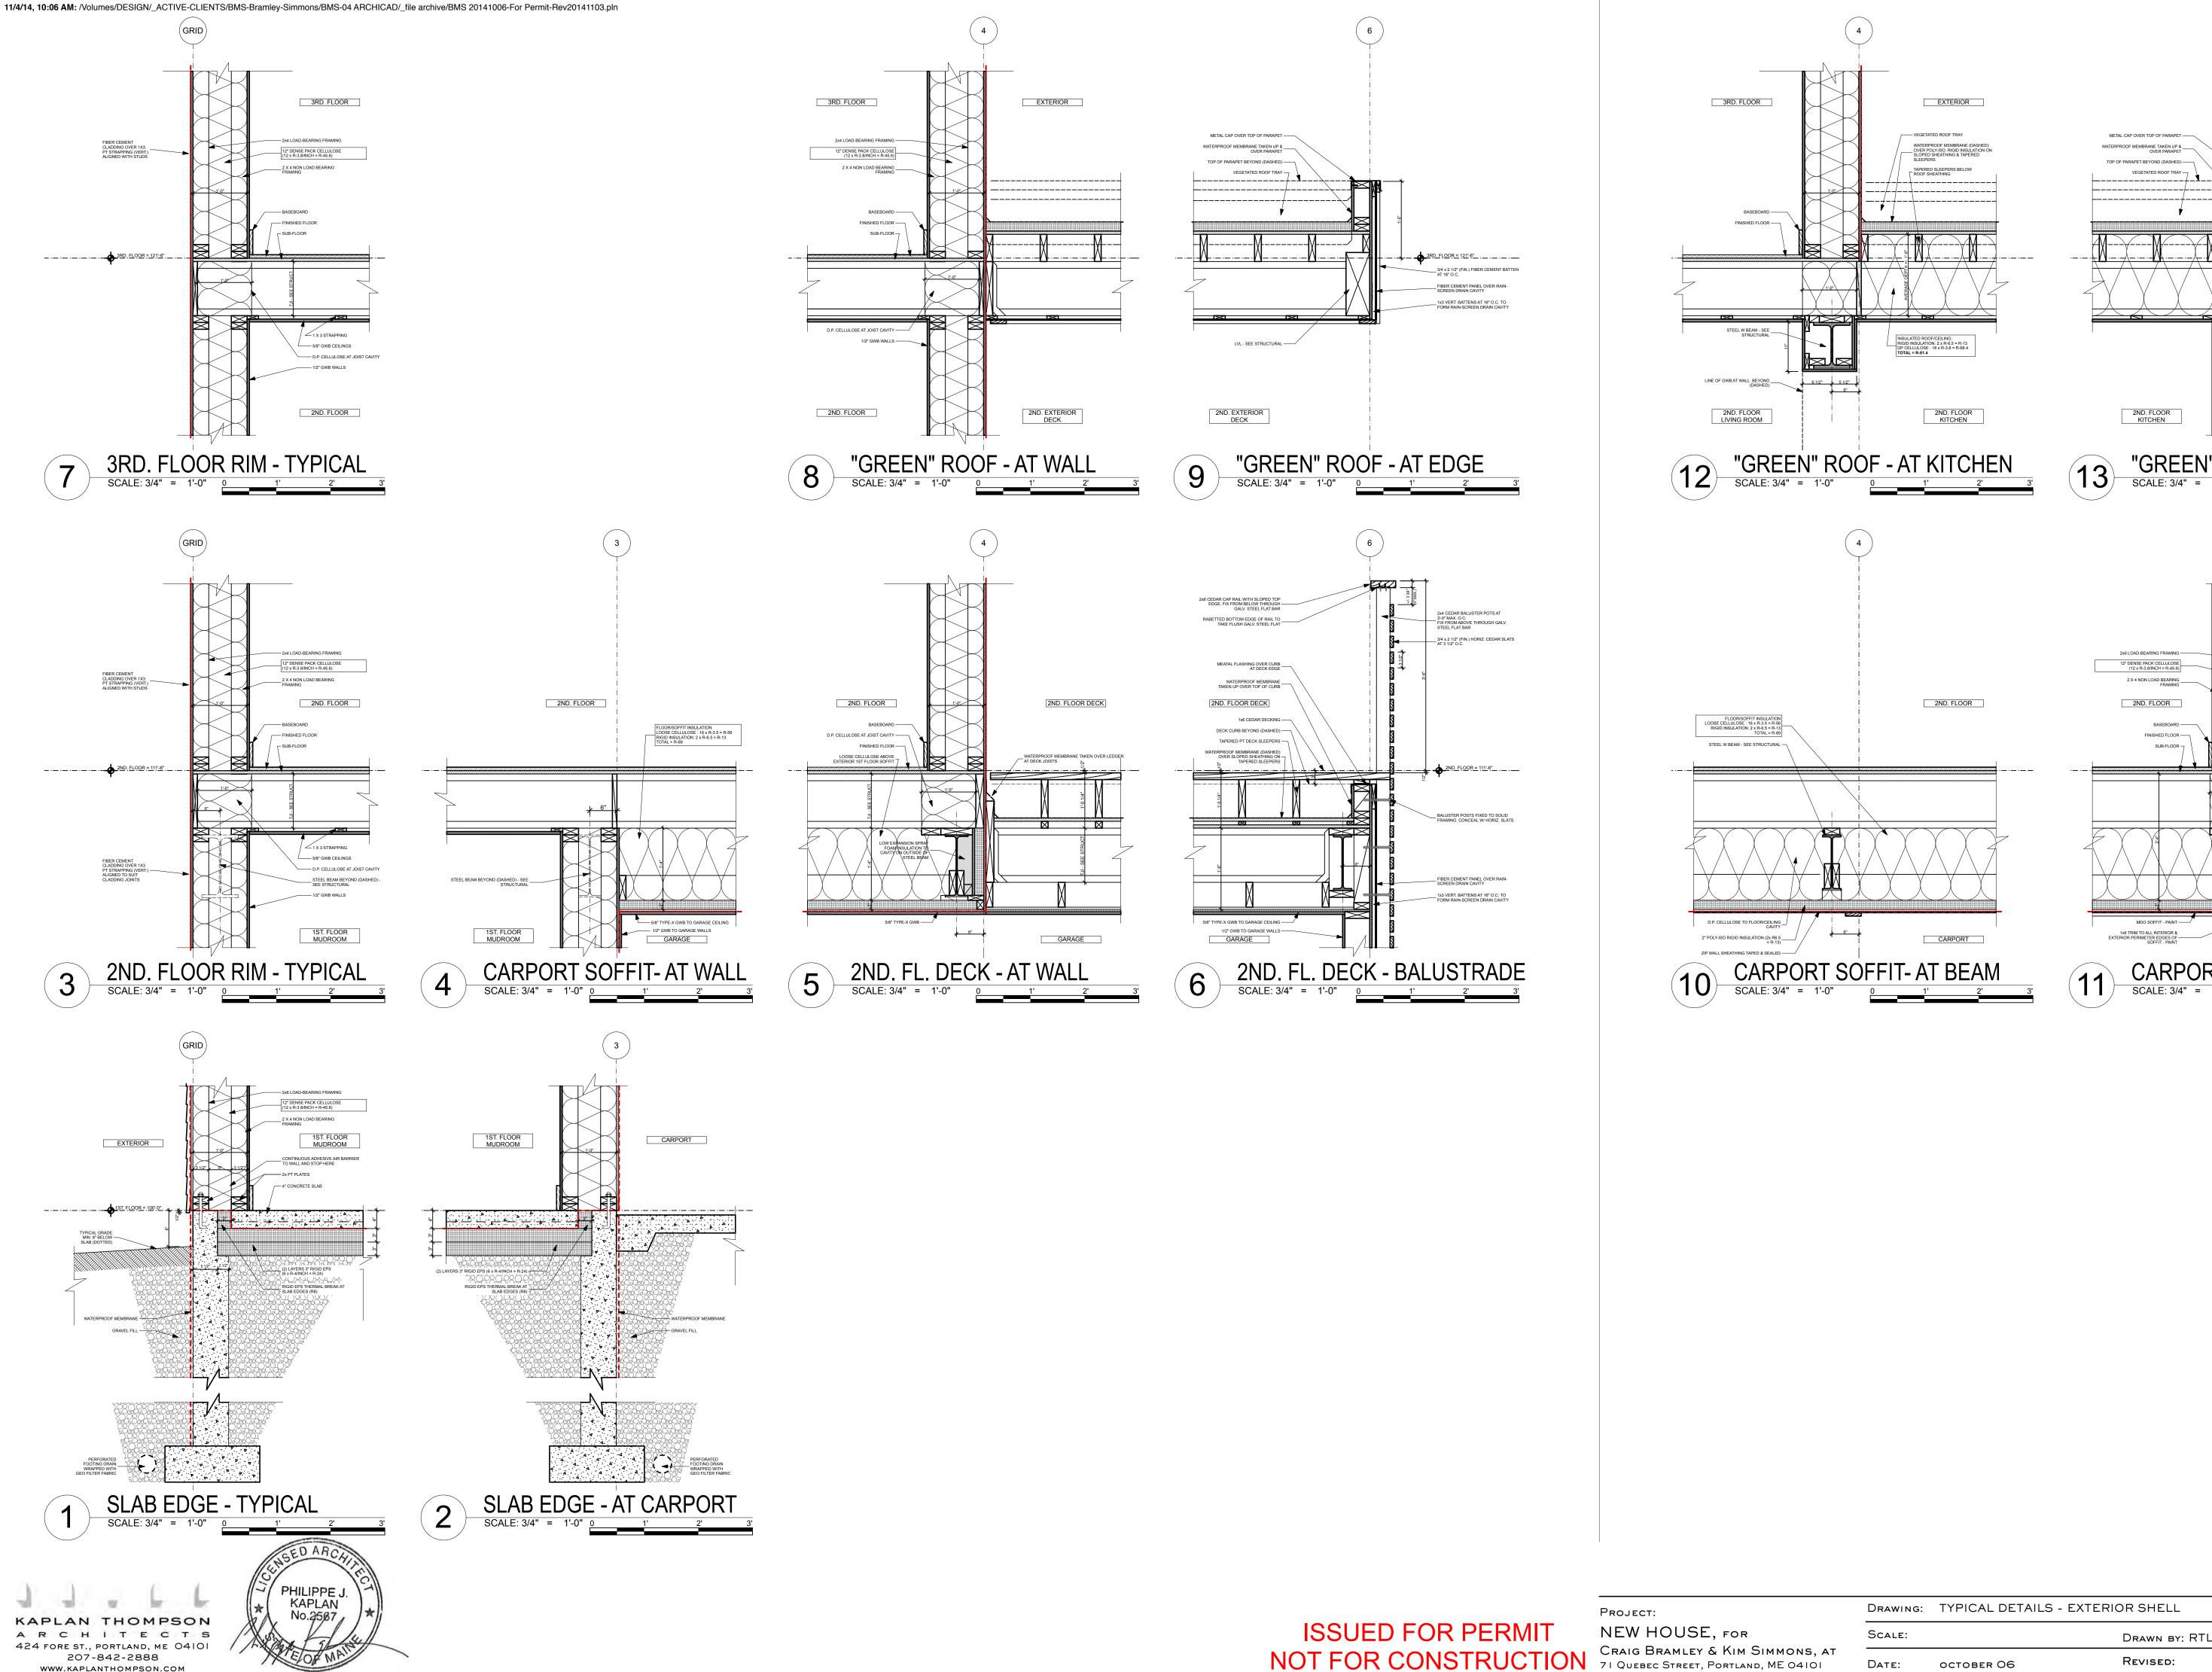

WWW.KAPLANTHOMPSON.COM

3RD. FLOOR = 121'-6" \_\_\_\_ 3/4 x 2 1/2" (FIN.) FIBER CEMENT BATTEN AT 16" O.C. 2ND. FLOOR KITCHEN 2 X 4 NON LOAD BEARING \_\_ FRAMING 2ND. FLOOR BASEBOARD ----FINISHED FLOOR — 2ND. FLOOR = 111'-6" CARPORT SOFFIT- AT EDGE

Date: october 06

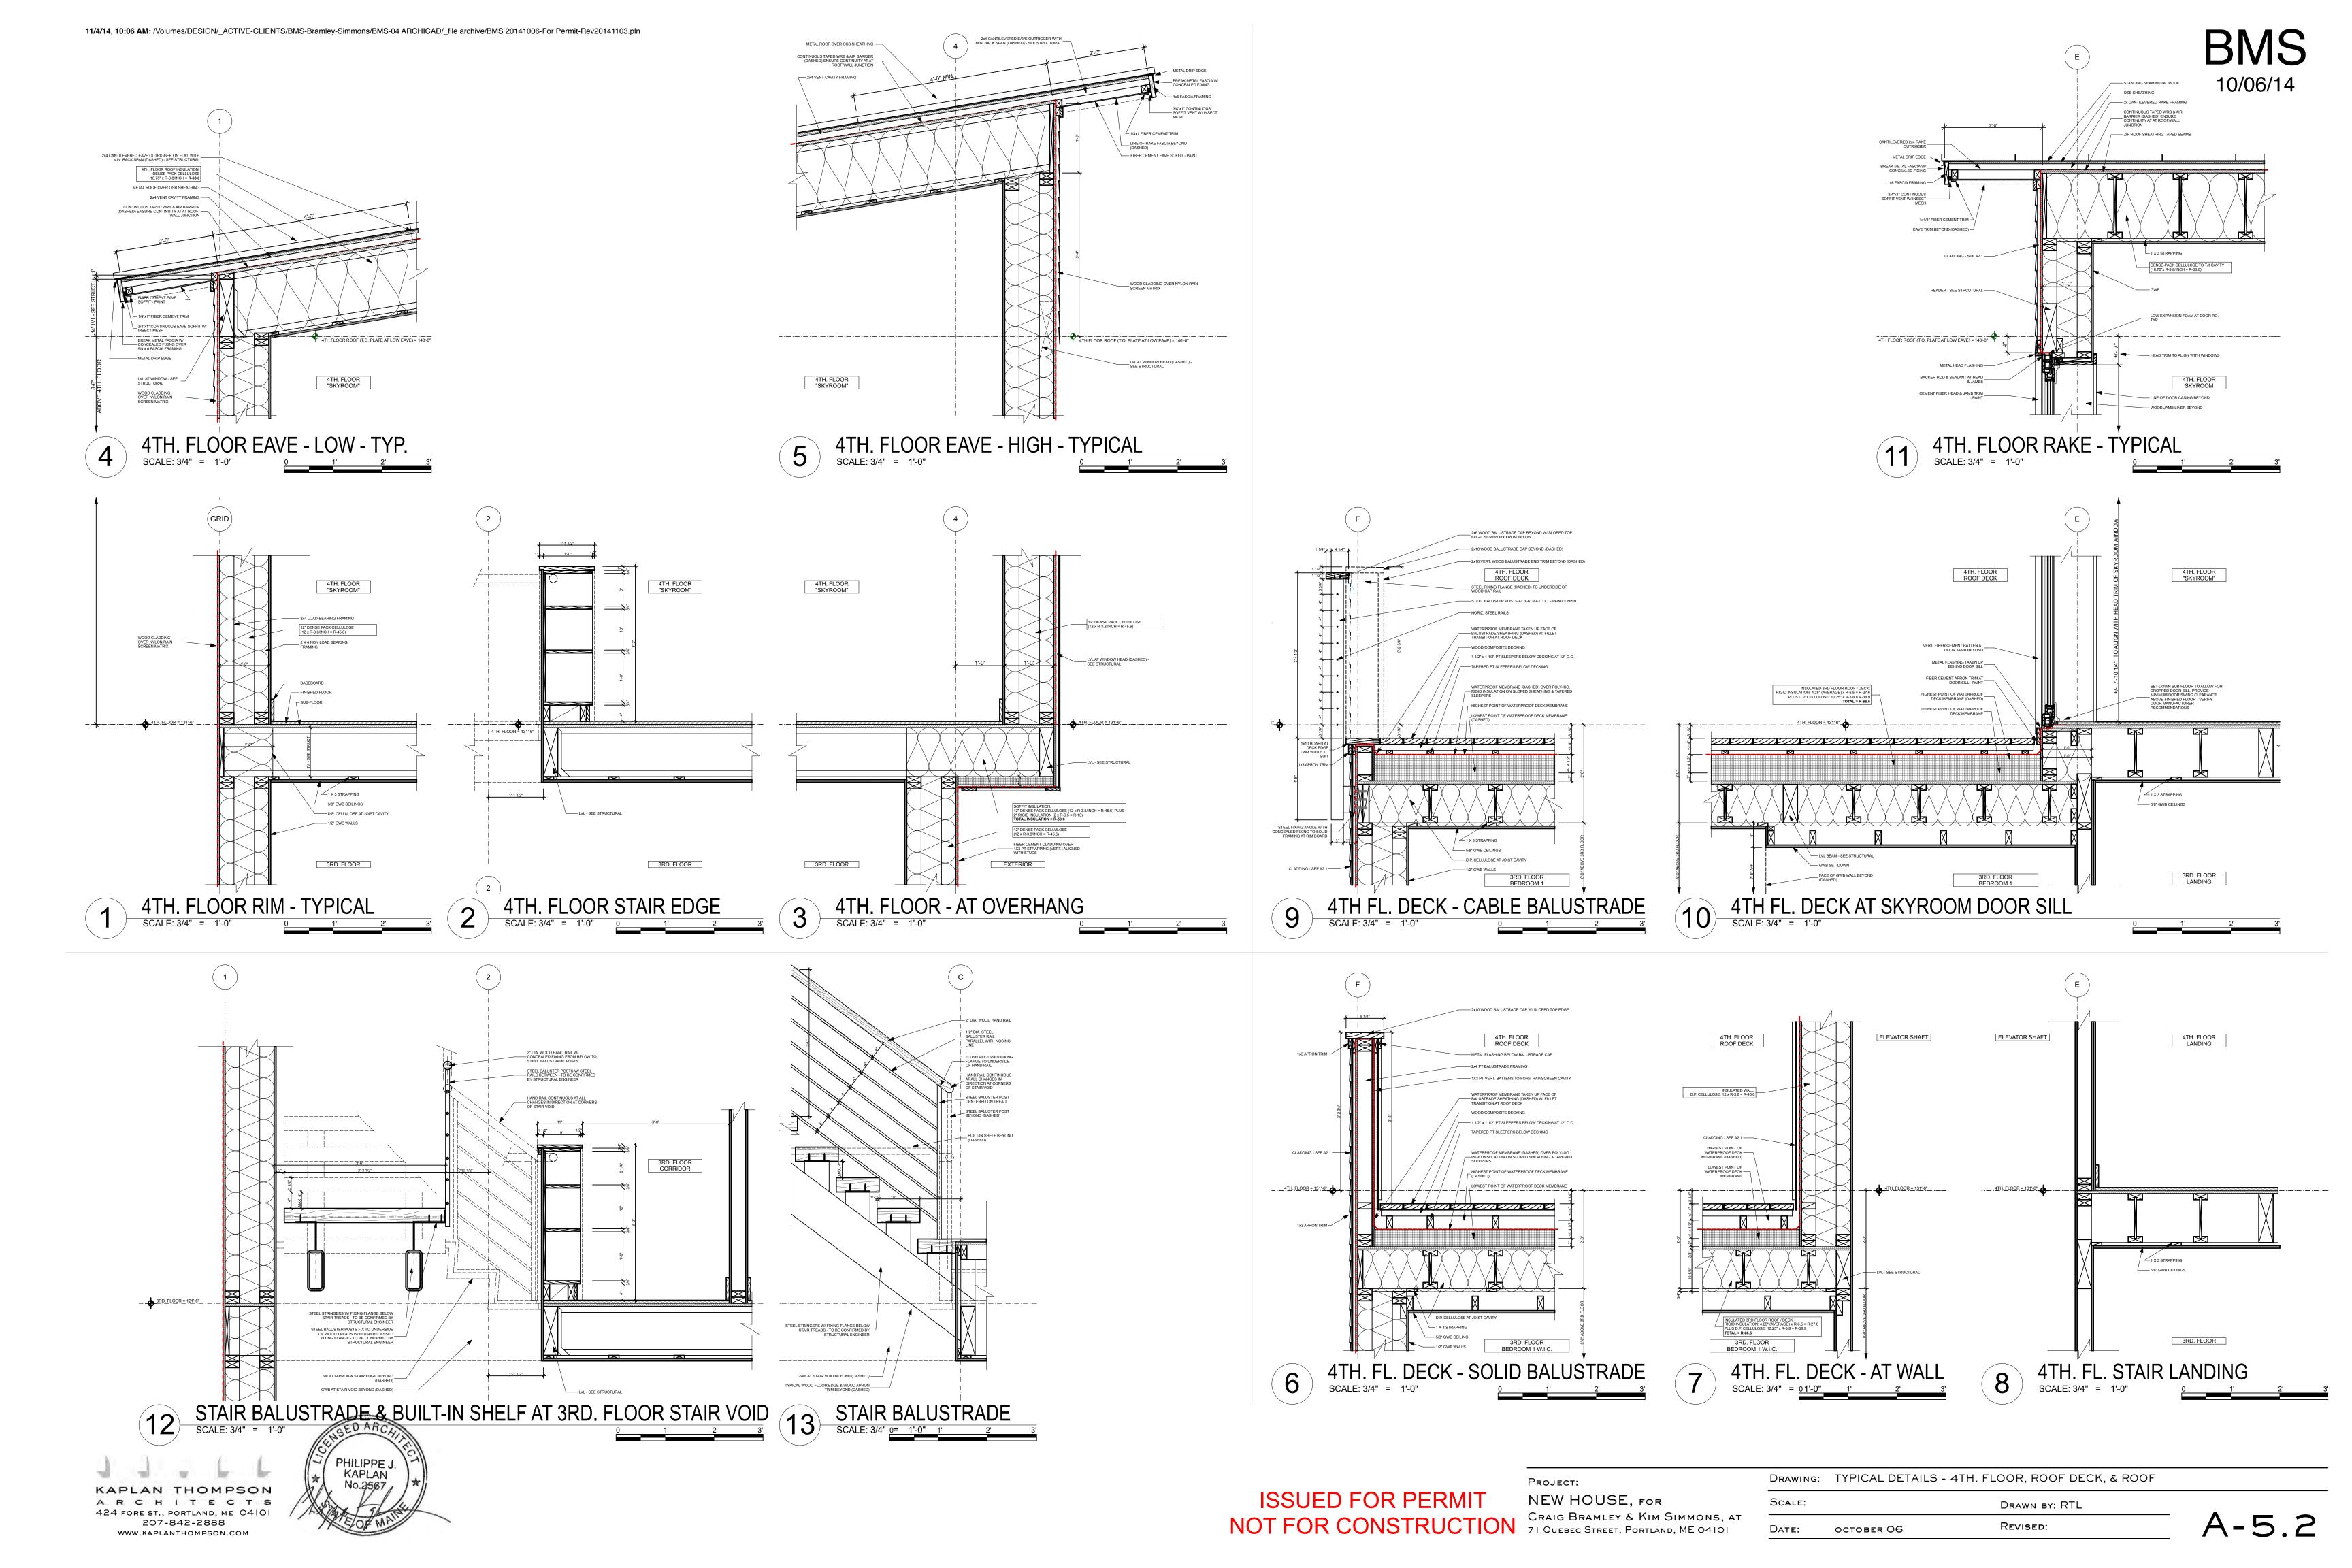







	WINDOW SCHEDULE									
UNIT ID	EXTERIOR VIEW	UNIT (W)	UNIT (H)	UNIT TYPE	QUANTITY	NOM. AREA	GLAZING	EGRESS	U-VALUE	NOTES
1.1		2'-6"	2'-0"	Tilt-turn	1	5.19			0.14	
2.1		2'-6"	3'-3"	Tilt-turn	1	8.37	Tempered		,,	
2.2		2'-6"	3'-3"	Tilt-turn	1	8.37	Tempered		,,	
2.3		3'-6"	7'-9 1/4"	Fixed / Tilt-turn	1	29.79			11	
2.4a		5'-9"	7'-9 1/4"	Fixed / Tilt-turn	1	47.36			,,	
2.4b		5'-9"	7'-9 1/4"	Fixed / Tilt-turn	1	45.25			,,	
2.5		5'-9"	5'-9 1/4"	Fixed	1	35.24			,,	
2.6		2'-4"	5'-9 1/4"	Tilt-turn	1	15.38			,,	
2.7		2'-9"	5'-9 1/4"	Tilt-turn	1	16.23			"	
2.8		4'-4"	5'-9 1/4"	Tilt-turn	1	27.00			,,	
2.9		3'-6"	5'-9 1/4"	Tilt-turn	1	22.16			,	
2.10		7'-8"	4'-0"	Fixed / Tilt-turn	1	31.15	Tempered		"	
2.11		6'-9"	4'-0"	Fixed / Tilt-turn	1	27.45			"	
2.12		6'-9"	4'-0"	Fixed / Tilt-turn	1	27.45		Yes	,,	
3.1		2'-6"	3'-3"	Tilt-turn	1	8.37	Tempered		,,	
3.2		4'-0"	2'-0"	Tilt-turn	1	8.25	Tempered		,,	
3.3		4'-0"	2'-0"	Tilt-turn	1	8.25			"	
3.4		3'-6"	4'-6"	Tilt-turn	1	17.32		Yes	"	
3.5		5'-9"	4'-6"	Fixed	1	27.53			,,	
3.6		5'-9"	4'-6"	Fixed	1	27.53			,,	
3.7		3'-6"	4'-6"	Tilt-turn	1	17.32		Yes	,,	
3.8		4'-0"	2'-0"	Tilt-turn	1	8.25			,,	
3.9		4'-0"	2'-0"	Tilt-turn	1	8.25	Tempered		,,	
3.10		2'-6"	4'-0"	Tilt-turn	1	10.27	Tempered		,,	
3.11		2'-6"	4'-0"	Tilt-turn	1	10.27			,,	
3.12		4'-0"	2'-0"	Tilt-turn	1	8.25	Tempered		,,	
3.13		2'-6"	4'-0"	Tilt-turn	1	10.27	Tempered		,,	
3.14		6'-9"	4'-0"	Fixed / Tilt-turn	1	27.45			"	
3.15		6'-9"	4'-0"	Fixed / Tilt-turn	1	27.45		Yes	"	
3.16		3'-3 1/2"	2'-0"	Tilt-turn	1	6.81			"	
4.1		14'-7 1/2"	4'-6"	Fixed / Tilt-turn	1	66.61	Tempered		"	
4.2		2'-6"	3'-3"	Tilt-turn	1	8.37	Tempered		,,	
4.3		7'-0"	3'-9"	Fixed / Tilt-turn	1	27.73			,,	
4.4		5'-0"	3'-9"	Fixed	1	20.14			,,	
4.5		9'-6"	5'-6"	Fixed / Tilt-turn	1	52.88			,,	
					35	753.96 sq ft				


	DOOR SCHEDULE						
UNIT ID	EXTERIOR VIEW	LEAF (W)	LEAF (H)	UNIT TYPE	QUANTITY	GLAZING	NOTES
1.1		3'-0"	6'-8"		1		Elevator
1.2		3'-0"	6'-8"		1		
1.3		1'-6"	4'-10"		1		
1.4		3'-0"	6'-8"		1		
2.1		3'-0"	6'-8"		1		Elevator
2.2		2'-6"	6'-8"		1		
2.3		4'-0"	6'-8"		1		
2.4		3'-6"	6'-8"	Pocket Slider	1		
3.1		3'-0"	6'-8"		1		Elevator
3.2		2'-8"	6'-8"		1		
3.3		4'-8"	6'-8"		1		
3.4		4'-8"	6'-8"		1		
3.5		2'-8"	6'-8"	Pocket Slider	1		
3.6	_	2'-6"	6'-8"	Pocket Slider	1		
3.7		2'-8"	6'-8"		1		
3.8		2'-8"	6'-8"		1		
3.9	Ш	2'-8"	6'-8"		1		
3.10	<u> </u>	4'-0"	6'-8"		1		
3.11		2'-6"	6'-8"		1		
3.12	Щ	2'-8"	6'-8"		1		
3.13	<u> </u>	4'-0"	6'-8"		1		
4.1	<u> </u>	3'-0"	6'-8"		1		Elevator
E1	1	3'-0"	6'-8"	2' Sidelight	1	Tempered	
E2	<u> </u>	3'-0"	6'-8"		1		Fire Rating: 1/3 Hour min.
E3		3'-0"	6'-8"		1		Fire Rating: 1/3 Hour min.
E4		3'-0"	6'-8"		1		
E5	Щ	3'-0"	6'-8"	3' Sidelight	1	Tempered	
E6	<del>  <u> </u> </del>	3'-0"	6'-8"	D.C	1	Tempered	
E7	Щ	9'-4"	8'-0"	Bifold	1	Tempered	
E8		12'-0"	8'-0"	O/H Garage	1		
E9	<u>                                     </u>	3'-0"	6'-8"		1		
E10	<u> </u>	3'-0"	6'-8"		1		
					32		

ISSUED FOR PERMIT
NEW HOUSE, FOR
CRAIG BRAMLEY & KIM SIMMONS, AT
71 QUEBEC STREET, PORTLAND, ME 04101

Project:

DRAWING: SCHEDULES - WINDOWS & DOORS

Scale: DRAWN BY: RTL REVISED: NOVEMBER 03, 2014 Date: october 06

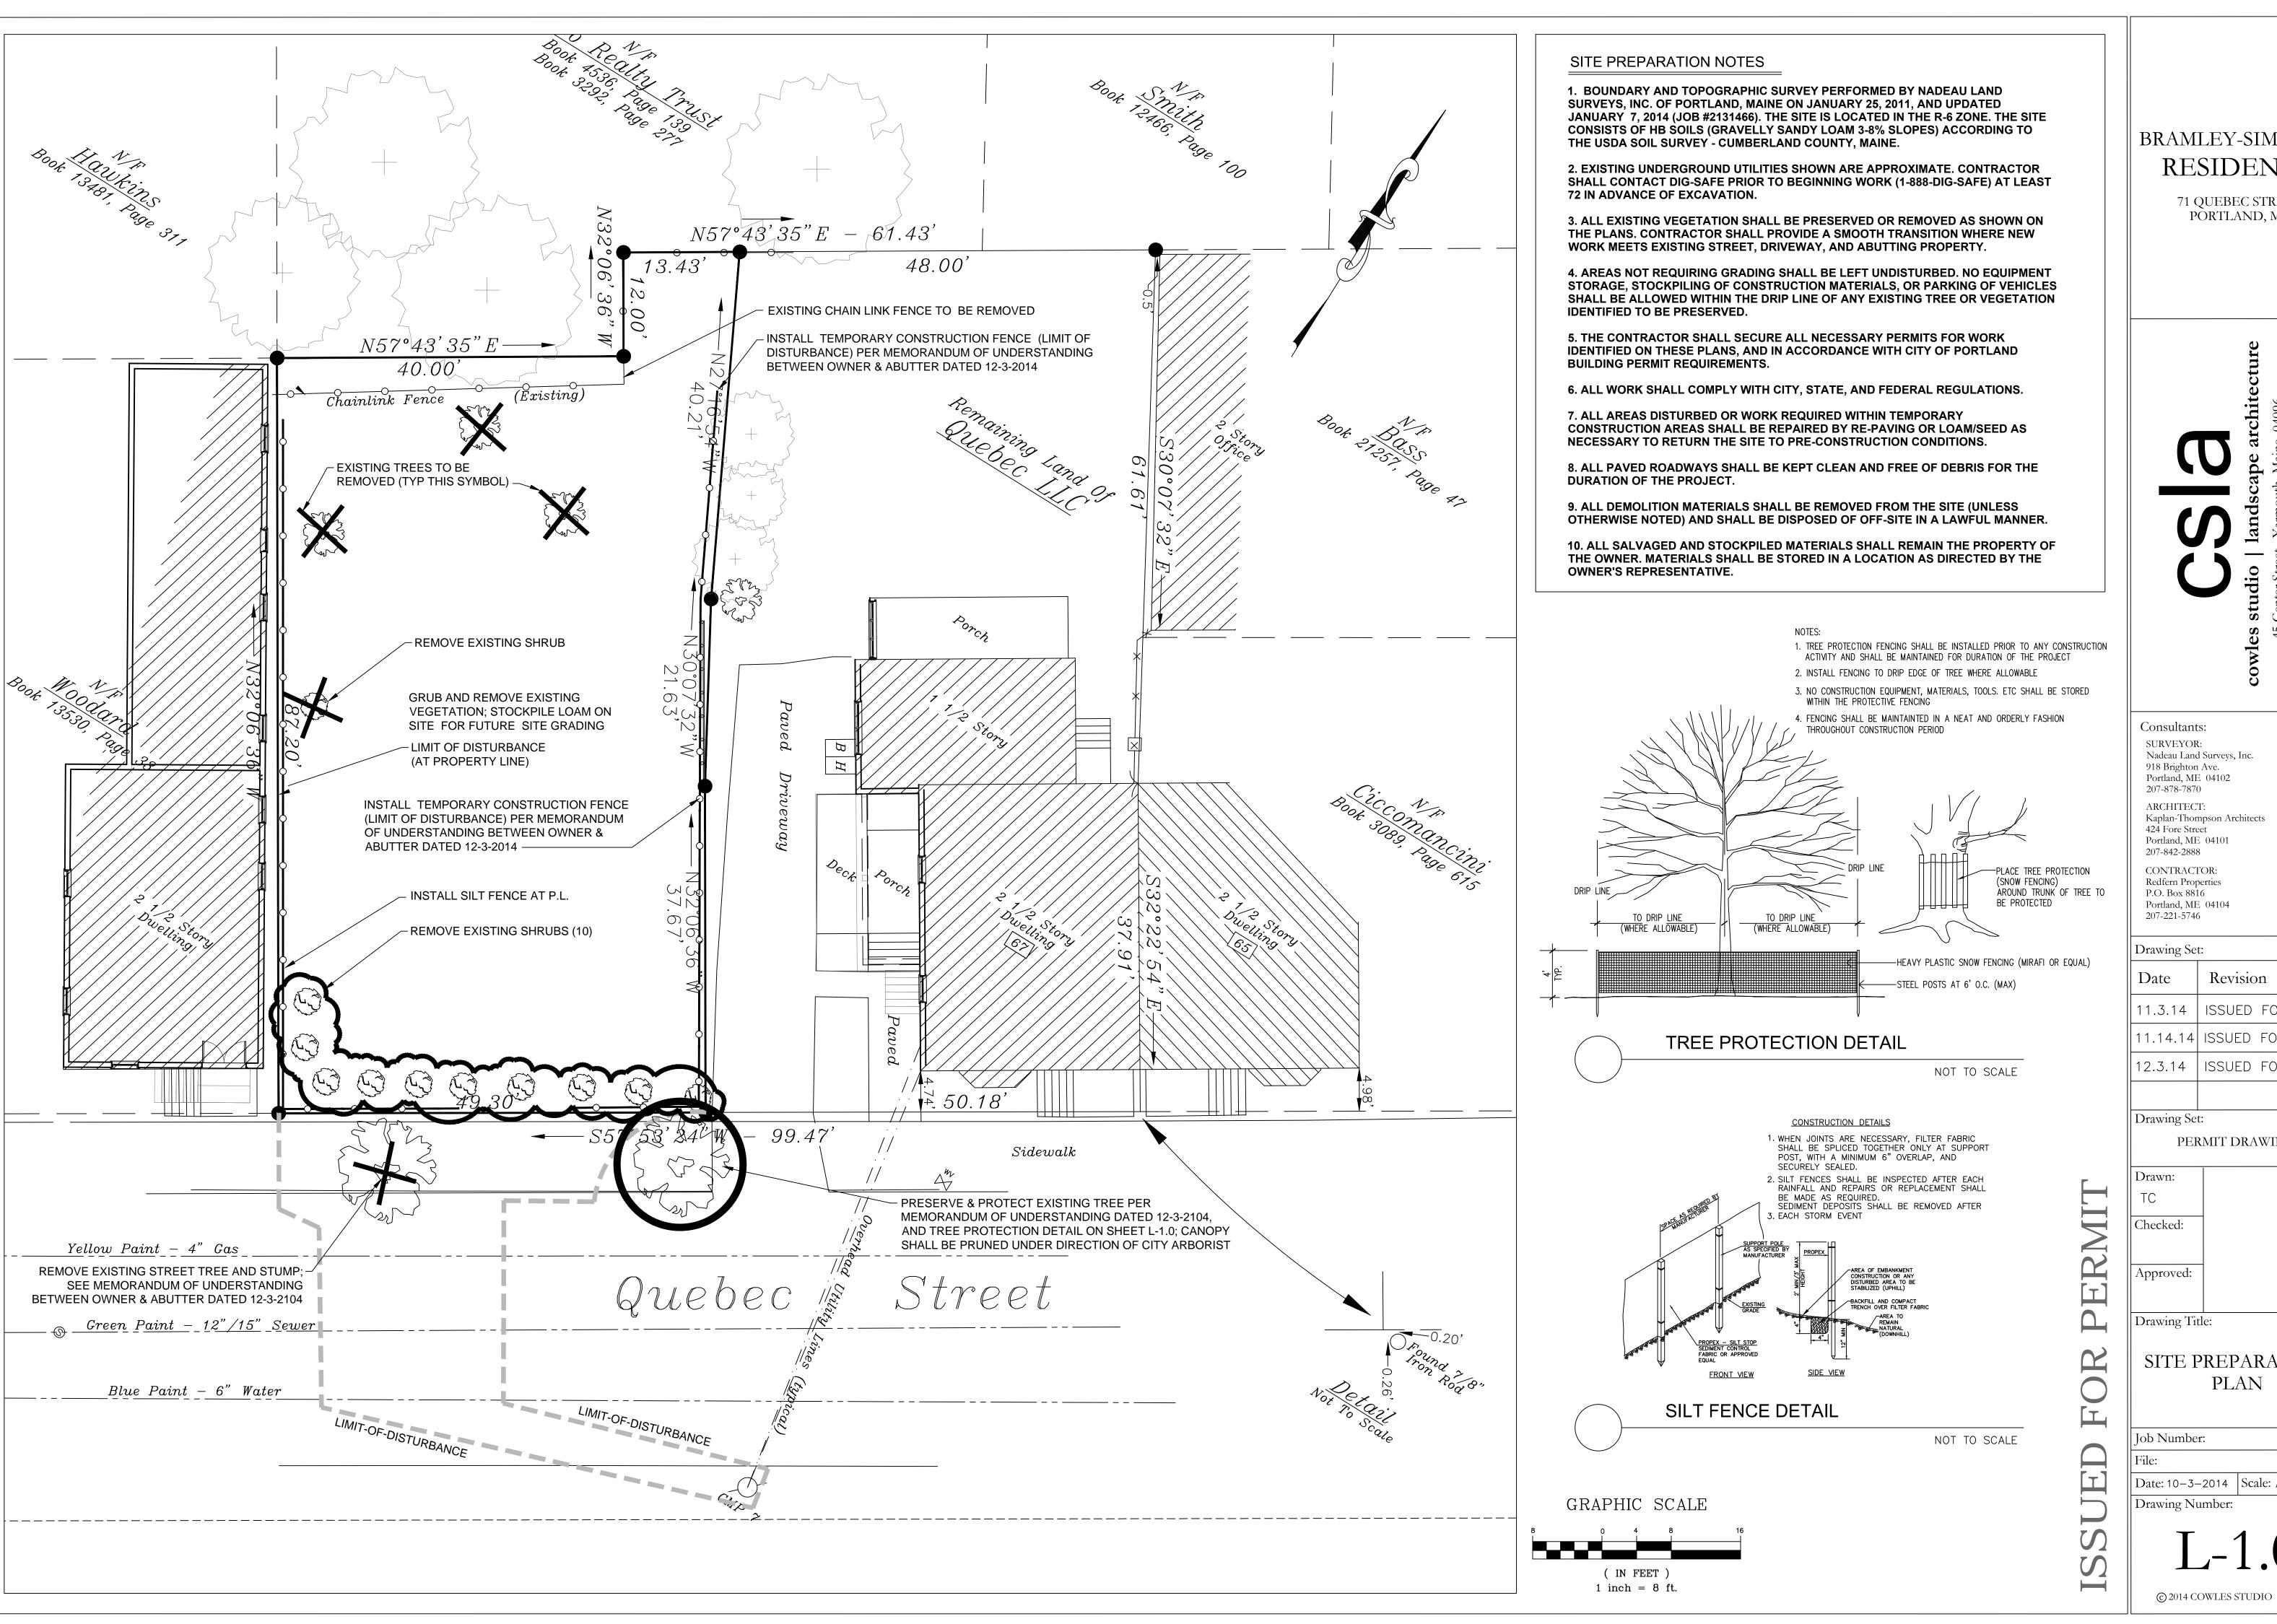

#### **BRAMLEY-SIMMONS** RESIDENCE

71 QUEBEC STREET PORTLAND, ME

Consultants: SURVEYOR: Nadeau Land Surveys, Inc. 918 Brighton Ave. Portland, ME 04102 207-878-7870 ARCHITECT: Kaplan-Thompson Architects 424 Fore Street 207-842-2888 CONTRACTOR: Redfern Properties P.O. Box 8816

Drawing Set: Revision ISSUED FOR PERMIT 11.14.14 ISSUED FOR PERMIT 12.3.14 | ISSUED FOR PERMIT Drawing Set: PERMIT DRAWINGS

Approved:


Drawing Title:

SITE PREPARATION PLAN

Job Number:

Date: 10-3-2014 | Scale: AS SHOWN

Drawing Number:

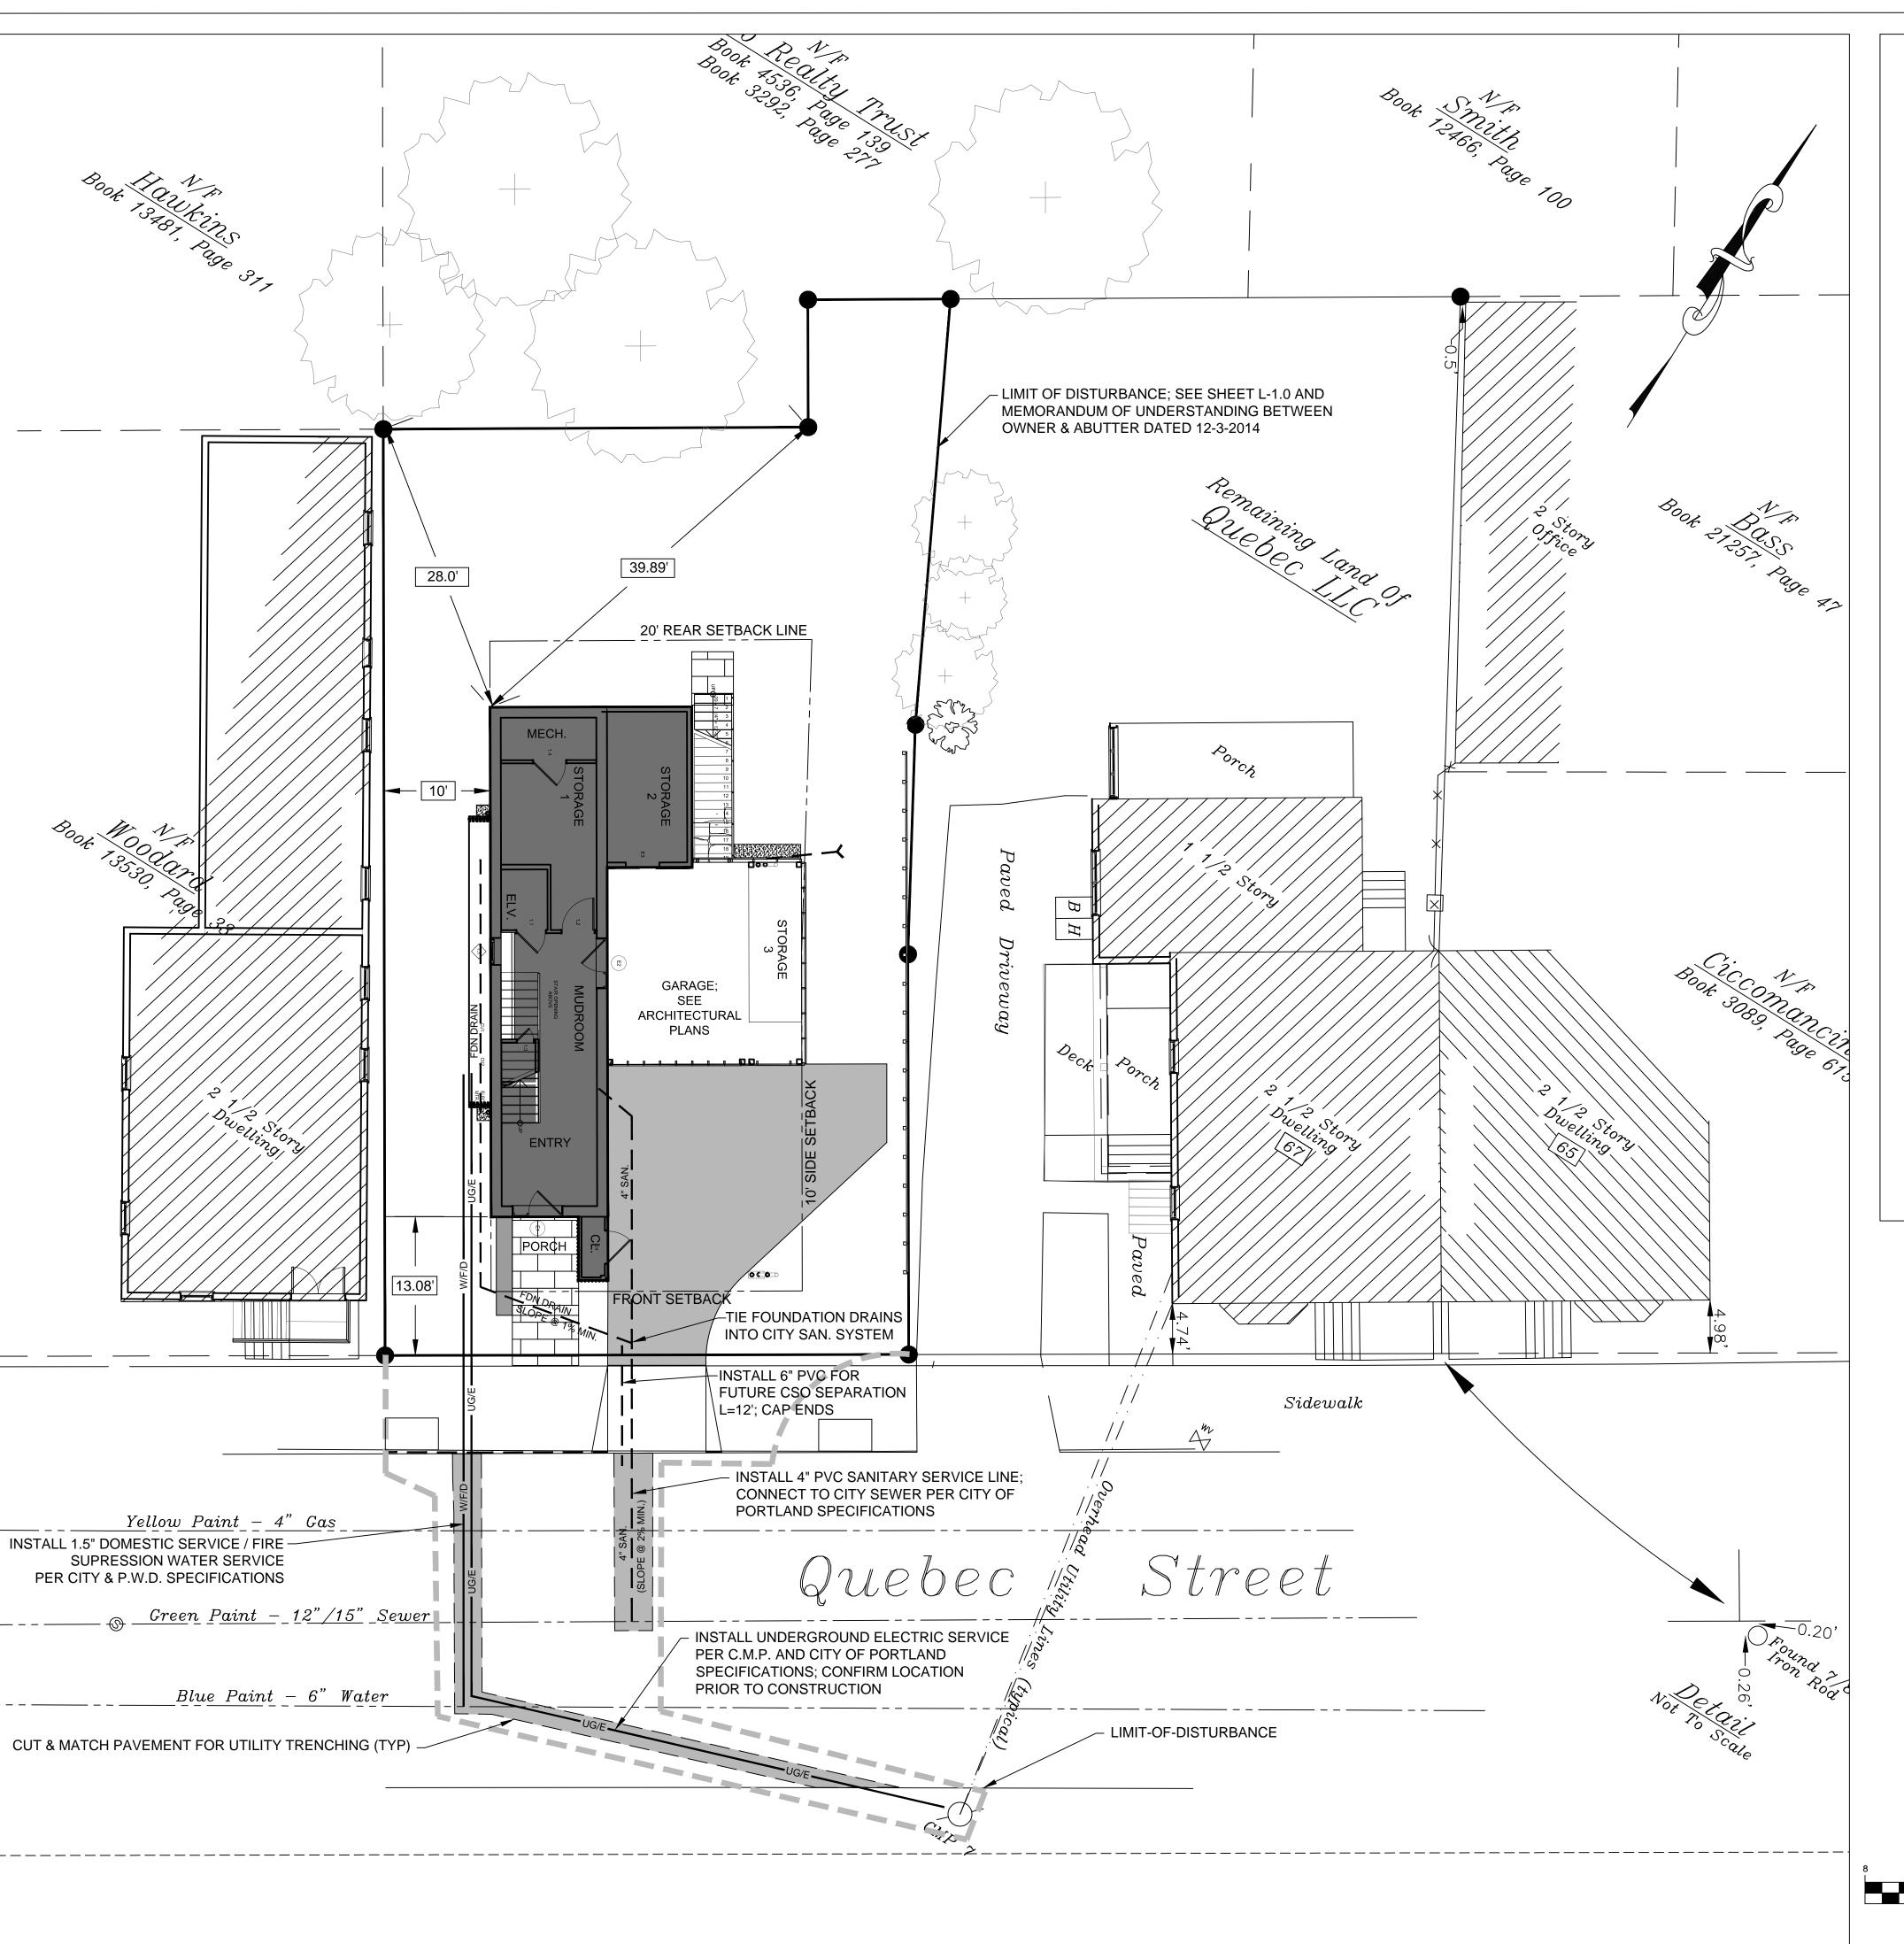

#### **GENERAL NOTES**

- 1. BOUNDARY AND TOPOGRAPHIC SURVEY PERFORMED BY NADEAU LAND SURVEYS, INC. OF PORTLAND, MAINE ON JANUARY 25, 2011, AND UPDATED JANUARY 7, 2014 (JOB #2131466). THE SITE IS LOCATED IN THE R-6 ZONE. THE SITE CONSISTS OF HB SOILS (GRAVELLY SANDY LOAM 3-8% SLOPES) ACCORDING TO THE USDA SOIL SURVEY - CUMBERLAND COUNTY, MAINE.
- 2. CONTRACTOR SHALL VERIFY ALL DIMENSIONS AND GRADES IN FIELD, AND NOTIFY THE ARCHITECT IMMEDIATELY OF ANY DISCREPANCIES.
- 3. ALL DIMENSIONS SHOWN ARE TO FACE OF WALLS, BUILDINGS, AND OTHER SITE **ELEMENTS UNLESS OTHERWISE NOTED.**
- 4. EXISTING UNDERGROUND UTILITIES SHOWN ARE APPROXIMATE. CONTRACTOR SHALL CONTACT DIG-SAFE PRIOR TO BEGINNING WORK (1-888-DIG-SAFE) AT LEAST 72 IN ADVANCE OF EXCAVATION.
- 5. ALL EXISTING VEGETATION SHALL BE PRESERVED AS SHOWN ON THE PLANS. CONTRACTOR SHALL PROVIDE A SMOOTH TRANSITION WHERE NEW WORK MEETS EXISTING STREET, DRIVEWAY, AND ABUTTING PROPERTY.
- 6. AREAS NOT REQUIRING GRADING SHALL BE LEFT UNDISTURBED. NO EQUIPMENT STORAGE, STOCKPILING OF CONSTRUCTION MATERIALS, OR PARKING OF VEHICLES SHALL BE ALLOWED WITHIN THE DRIP LINE OF ANY EXISTING TREE OR VEGETATION IDENTIFIED TO BE PRESERVED.
- 7. THE CONTRACTOR SHALL SECURE ALL NECESSARY PERMITS FOR WORK IDENTIFIED ON THESE PLANS, AND IN ACCORDANCE WITH CITY OF PORTLAND **BUILDING PERMIT REQUIREMENTS.**
- 8. ALL WORK SHALL COMPLY WITH CITY, STATE, AND FEDERAL REGULATIONS.
- 9. WATERLINE SERVICE INSTALLATION SHALL CONFORM TO REQUIREMENTS OF THE PORTLAND WATER DISTRICT.
- 10. ALL UTILITY CONNECTIONS SHALL BE COMPLETED IN ACCORDANCE WITH THE CITY OF PORTLAND SPECIFICATIONS AND REQUIREMENTS OF THE RESPECTIVE UTILITY COMPANY.
- 11. ALL WORK PERFORMED IN STREET OR CITY RIGHT-OF-WAY SHALL CONFORM TO CITY OF PORTLAND REQUIREMENTS AND CONSTRUCTION DETAILS.
- 12. ALL AREAS DISTURBED OR WORK REQUIRED WITHIN TEMPORARY CONSTRUCTION AREAS SHALL BE REPAIRED BY RE-PAVING OR LOAM/SEED AS NECESSARY TO RETURN THE SITE TO PRE-CONSTRUCTION CONDITIONS.
- 13. ALL PAVED ROADWAYS SHALL BE KEPT CLEAN AND FREE OF DEBRIS FOR THE DURATION OF THE PROJECT.
- 14. ALL DEMOLITION MATERIALS SHALL BE REMOVED FROM THE SITE (UNLESS OTHERWISE NOTED) AND SHALL BE DISPOSED OF OFF-SITE IN A LAWFUL MANNER.
- 15. ALL SALVAGED AND STOCKPILED MATERIALS SHALL REMAIN THE PROPERTY OF THE OWNER. MATERIALS SHALL BE STORED IN A LOCATION AS DIRECTED BY THE OWNER'S REPRESENTATIVE.
- 16. LOAM SHALL BE SPREAD ON THE SITE TO A DEPTH OF 6" IN AREAS IDENTIFIED FOR NEW LAWN. PLANTING AREAS SHALL RECEIVE LOAM/COMPOST MIXTURE TO A DEPTH OF 10". THE FINISHED SITE SHALL BE GRADED SMOOTH TO REMOVE ALL RIDGES, SWALES, MOUNDS AND DEPRESSIONS UNLESS OTHERWISE NOTED ON THE PLANS. THE CONTRACTOR SHALL ENSURE POSITIVE DRAINAGE AWAY FROM THE STRUCTURE ACCORDING TO SPOT GRADES PROVIDED ON THE PLAN.
- 17. CONTRACTOR SHALL SUBMIT SOIL TEST RESULTS TO THE LANDSCAPE ARCHITECT FOR APPROVAL PRIOR TO IMPORTING OR SPREADING LOAM ON SITE. A SOIL TESTING KIT CAN BE OBTAINED BY THE UNIVERSITY OF MAINE COOPERATIVE EXTENSION SERVICE, 75 CLEARWATER DRIVE- FALMOUTH, MAINE.
- 18. AREAS IDENTIFIED FOR SEEDING SHALL USE A PERMANENT SEED MIX WHICH SHALL BE APPROVED BY THE LANDSCAPE ARCHITECT PRIOR TO INSTALLATION.

#### BRAMLEY-SIMMONS RESIDENCE

71 QUEBEC STREET PORTLAND, ME

Consultants: SURVEYOR: Nadeau Land Surveys, Inc. 918 Brighton Ave. Portland, ME 04102 207-878-7870

ARCHITECT: Kaplan-Thompson Architects 424 Fore Street 207-842-2888

CONTRACTOR: Redfern Properties P.O. Box 8816

Portland, ME 04104 207-221-5746

Drawing Set:							
Date	Revision						
11.3.14	ISSUED FOR PERMIT						
11.14.14	ISSUED FOR PERMIT						
12.3.14	ISSUED FOR PERMIT						
Drawing Se	t:						
PER	RMIT DRAWINGS						
Drawn:							
TC							
Checked:							
Approved:							

Drawing Title: SITE LAYOUT & UTILITIES PLAN


Job Number:

Drawing Number:


Date: 10-3-2014 | Scale: AS SHOWN

© 2014 COWLES STUDIO

GRAPHIC SCALE

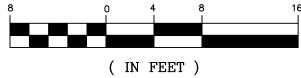

1 inch = 8 ft.

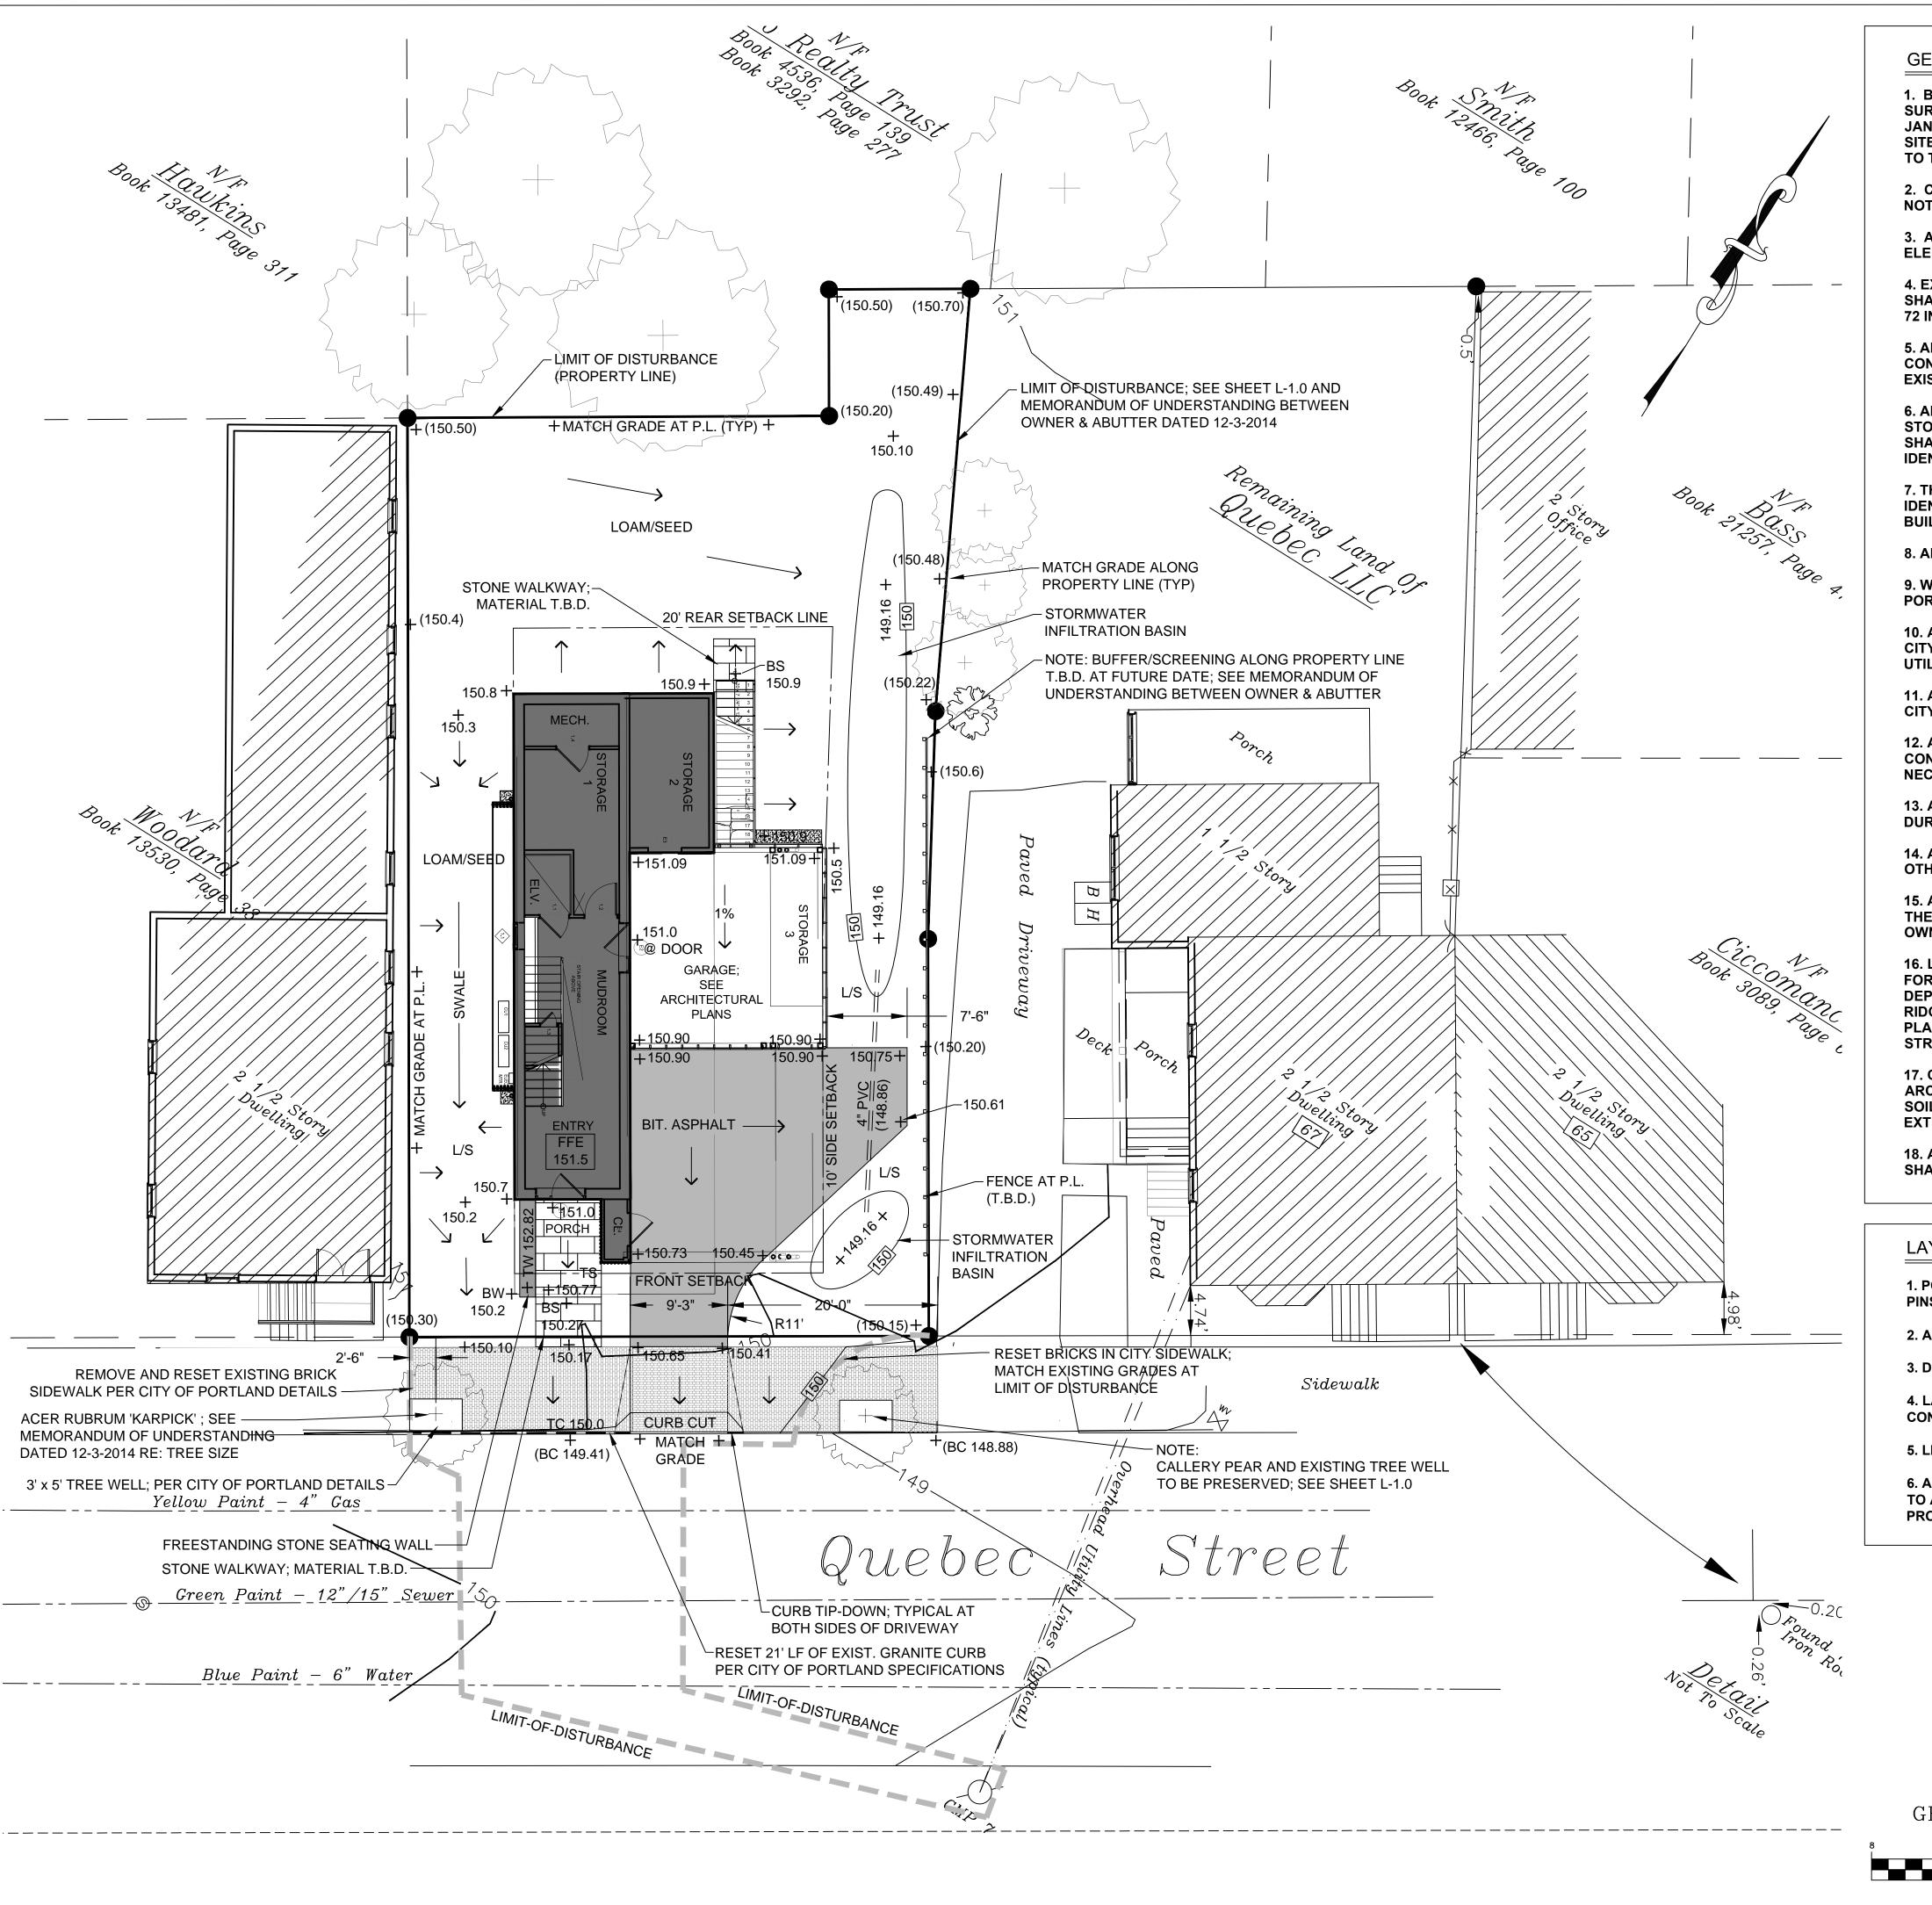

#### **GENERAL NOTES**


- 1. BOUNDARY AND TOPOGRAPHIC SURVEY PERFORMED BY NADEAU LAND SURVEYS, INC. OF PORTLAND, MAINE ON JANUARY 25, 2011, AND UPDATED JANUARY 7, 2014 (JOB #2131466). THE PROJECT IS LOCATED IN THE R-6 ZONE. THE SITE CONSISTS OF HB SOILS (GRAVELLY SANDY LOAM 3-8% SLOPES) ACCORDING TO THE USDA SOIL SURVEY - CUMBERLAND COUNTY, MAINE.
- 2. CONTRACTOR SHALL VERIFY ALL DIMENSIONS AND GRADES IN FIELD, AND NOTIFY THE ARCHITECT IMMEDIATELY OF ANY DISCREPANCIES.
- 3. ALL DIMENSIONS SHOWN ARE TO FACE OF WALLS, BUILDINGS, AND OTHER SITE **ELEMENTS UNLESS OTHERWISE NOTED.**
- 4. EXISTING UNDERGROUND UTILITIES SHOWN ARE APPROXIMATE. CONTRACTOR SHALL CONTACT DIG-SAFE PRIOR TO BEGINNING WORK (1-888-DIG-SAFE) AT LEAST 72 IN ADVANCE OF EXCAVATION.
- 5. ALL EXISTING VEGETATION SHALL BE PRESERVED AS SHOWN ON THE PLANS. CONTRACTOR SHALL PROVIDE A SMOOTH TRANSITION WHERE NEW WORK MEETS **EXISTING STREET, DRIVEWAY, AND ABUTTING PROPERTY.**
- 6. AREAS NOT REQUIRING GRADING SHALL BE LEFT UNDISTURBED. NO EQUIPMENT STORAGE, STOCKPILING OF CONSTRUCTION MATERIALS, OR PARKING OF VEHICLES SHALL BE ALLOWED WITHIN THE DRIP LINE OF ANY EXISTING TREE OR VEGETATION IDENTIFIED TO BE PRESERVED.
- 7. THE CONTRACTOR SHALL SECURE ALL NECESSARY PERMITS FOR WORK IDENTIFIED ON THESE PLANS, AND IN ACCORDANCE WITH CITY OF PORTLAND **BUILDING PERMIT REQUIREMENTS.**
- 8. ALL WORK SHALL COMPLY WITH CITY, STATE, AND FEDERAL REGULATIONS.
- 9. WATERLINE SERVICE INSTALLATION SHALL CONFORM TO REQUIREMENTS OF THE PORTLAND WATER DISTRICT.
- 10. ALL UTILITY CONNECTIONS SHALL BE COMPLETED IN ACCORDANCE WITH THE CITY OF PORTLAND SPECIFICATIONS AND REQUIREMENTS OF THE RESPECTIVE UTILITY COMPANY.
- 11. ALL WORK PERFORMED IN STREET OR CITY RIGHT-OF-WAY SHALL CONFORM TO CITY OF PORTLAND REQUIREMENTS AND CONSTRUCTION DETAILS.
- 12. ALL AREAS DISTURBED OR WORK REQUIRED WITHIN TEMPORARY CONSTRUCTION AREAS SHALL BE REPAIRED BY RE-PAVING OR LOAM/SEED AS NECESSARY TO RETURN THE SITE TO PRE-CONSTRUCTION CONDITIONS.
- 13. ALL PAVED ROADWAYS SHALL BE KEPT CLEAN AND FREE OF DEBRIS FOR THE **DURATION OF THE PROJECT.**
- 14. ALL DEMOLITION MATERIALS SHALL BE REMOVED FROM THE SITE (UNLESS OTHERWISE NOTED) AND SHALL BE DISPOSED OF OFF-SITE IN A LAWFUL MANNER.
- 15. ALL SALVAGED AND STOCKPILED MATERIALS SHALL REMAIN THE PROPERTY OF THE OWNER. MATERIALS SHALL BE STORED IN A LOCATION AS DIRECTED BY THE OWNER'S REPRESENTATIVE.
- 16. LOAM SHALL BE SPREAD ON THE SITE TO A DEPTH OF 6" IN AREAS IDENTIFIED FOR NEW LAWN. PLANTING AREAS SHALL RECEIVE LOAM/COMPOST MIXTURE TO A DEPTH OF 10". THE FINISHED SITE SHALL BE GRADED SMOOTH TO REMOVE ALL RIDGES, SWALES, MOUNDS AND DEPRESSIONS UNLESS OTHERWISE NOTED ON THE PLANS. THE CONTRACTOR SHALL ENSURE POSITIVE DRAINAGE AWAY FROM THE STRUCTURE ACCORDING TO SPOT GRADES PROVIDED ON THE PLAN.
- 17. CONTRACTOR SHALL SUBMIT SOIL TEST RESULTS TO THE LANDSCAPE ARCHITECT FOR APPROVAL PRIOR TO IMPORTING OR SPREADING LOAM ON SITE. A SOIL TESTING KIT CAN BE OBTAINED BY THE UNIVERSITY OF MAINE COOPERATIVE EXTENSION SERVICE, 75 CLEARWATER DRIVE- FALMOUTH, MAINE.
- 18. AREAS IDENTIFIED FOR SEEDING SHALL USE A PERMANENT SEED MIX WHICH SHALL BE PROVIDED BY THE LANDSCAPE ARCHITECT PRIOR TO INSTALLATION.

#### LAYOUT NOTES

- 1. POINT-OF-BEGINNING (POB) FOR ALL CONSTRUCTION LAYOUT SHALL BE FROM CORNER PINS SET BY LICENSED SURVEYOR.
- 2. ALL WRITTEN DIMENSIONS SHALL PREVAIL; DO NOT SCALE FROM DRAWINGS.
- 3. DISTANCES SHOWN OF THE PLAN ARE HORIZONTAL DISTANCES.
- 4. LAYOUT OF HOUSE CORNERS SHALL BE APPROVED BY THE ARCHITECT PRIOR TO CONSTRUCTION.
- 5. LIMIT OF WORK SHALL BE AT PROPERTY LINES UNLESS OTHERWISE NOTED.
- 6. A BENCH MARK FOR THE PROJECT SHALL BE ESTABLISHED BY THE SURVEYOR IN ORDER TO ACCURATELY ESTABLISH THE PROPOSED FINISH FLOOR ELEVATION (FFE) AND ALL PROPOSED GRADING PRIOR TO CONSTRUCTION.

## ISSUED FOR PERMIT

GRAPHIC SCALE

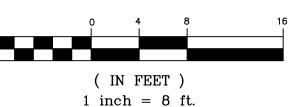

#### **BRAMLEY-SIMMONS** RESIDENCE

71 QUEBEC STREET PORTLAND, ME

Consultants: SURVEYOR: Nadeau Land Surveys, Inc. 918 Brighton Ave. Portland, ME 04102 207-878-7870

> Kaplan-Thompson Architects 424 Fore Street

207-842-2888 CONTRACTOR: Redfern Properties P.O. Box 8816

Portland, ME 04104 207-221-5746

Drawing S	Set:
-----------	------

Revision Date

ISSUED FOR PERMIT 11.3.14

11.14.14 ISSUED FOR PERMIT

12.3.14 | ISSUED FOR PERMIT

Drawing Set:

PERMIT DRAWINGS

|| Drawn:

Checked:

Approved:

Drawing Title:


SITE PLAN

Job Number:

Date: 10-3-2014 | Scale: AS SHOWN

Drawing Number:

© 2014 COWLES STUDIO

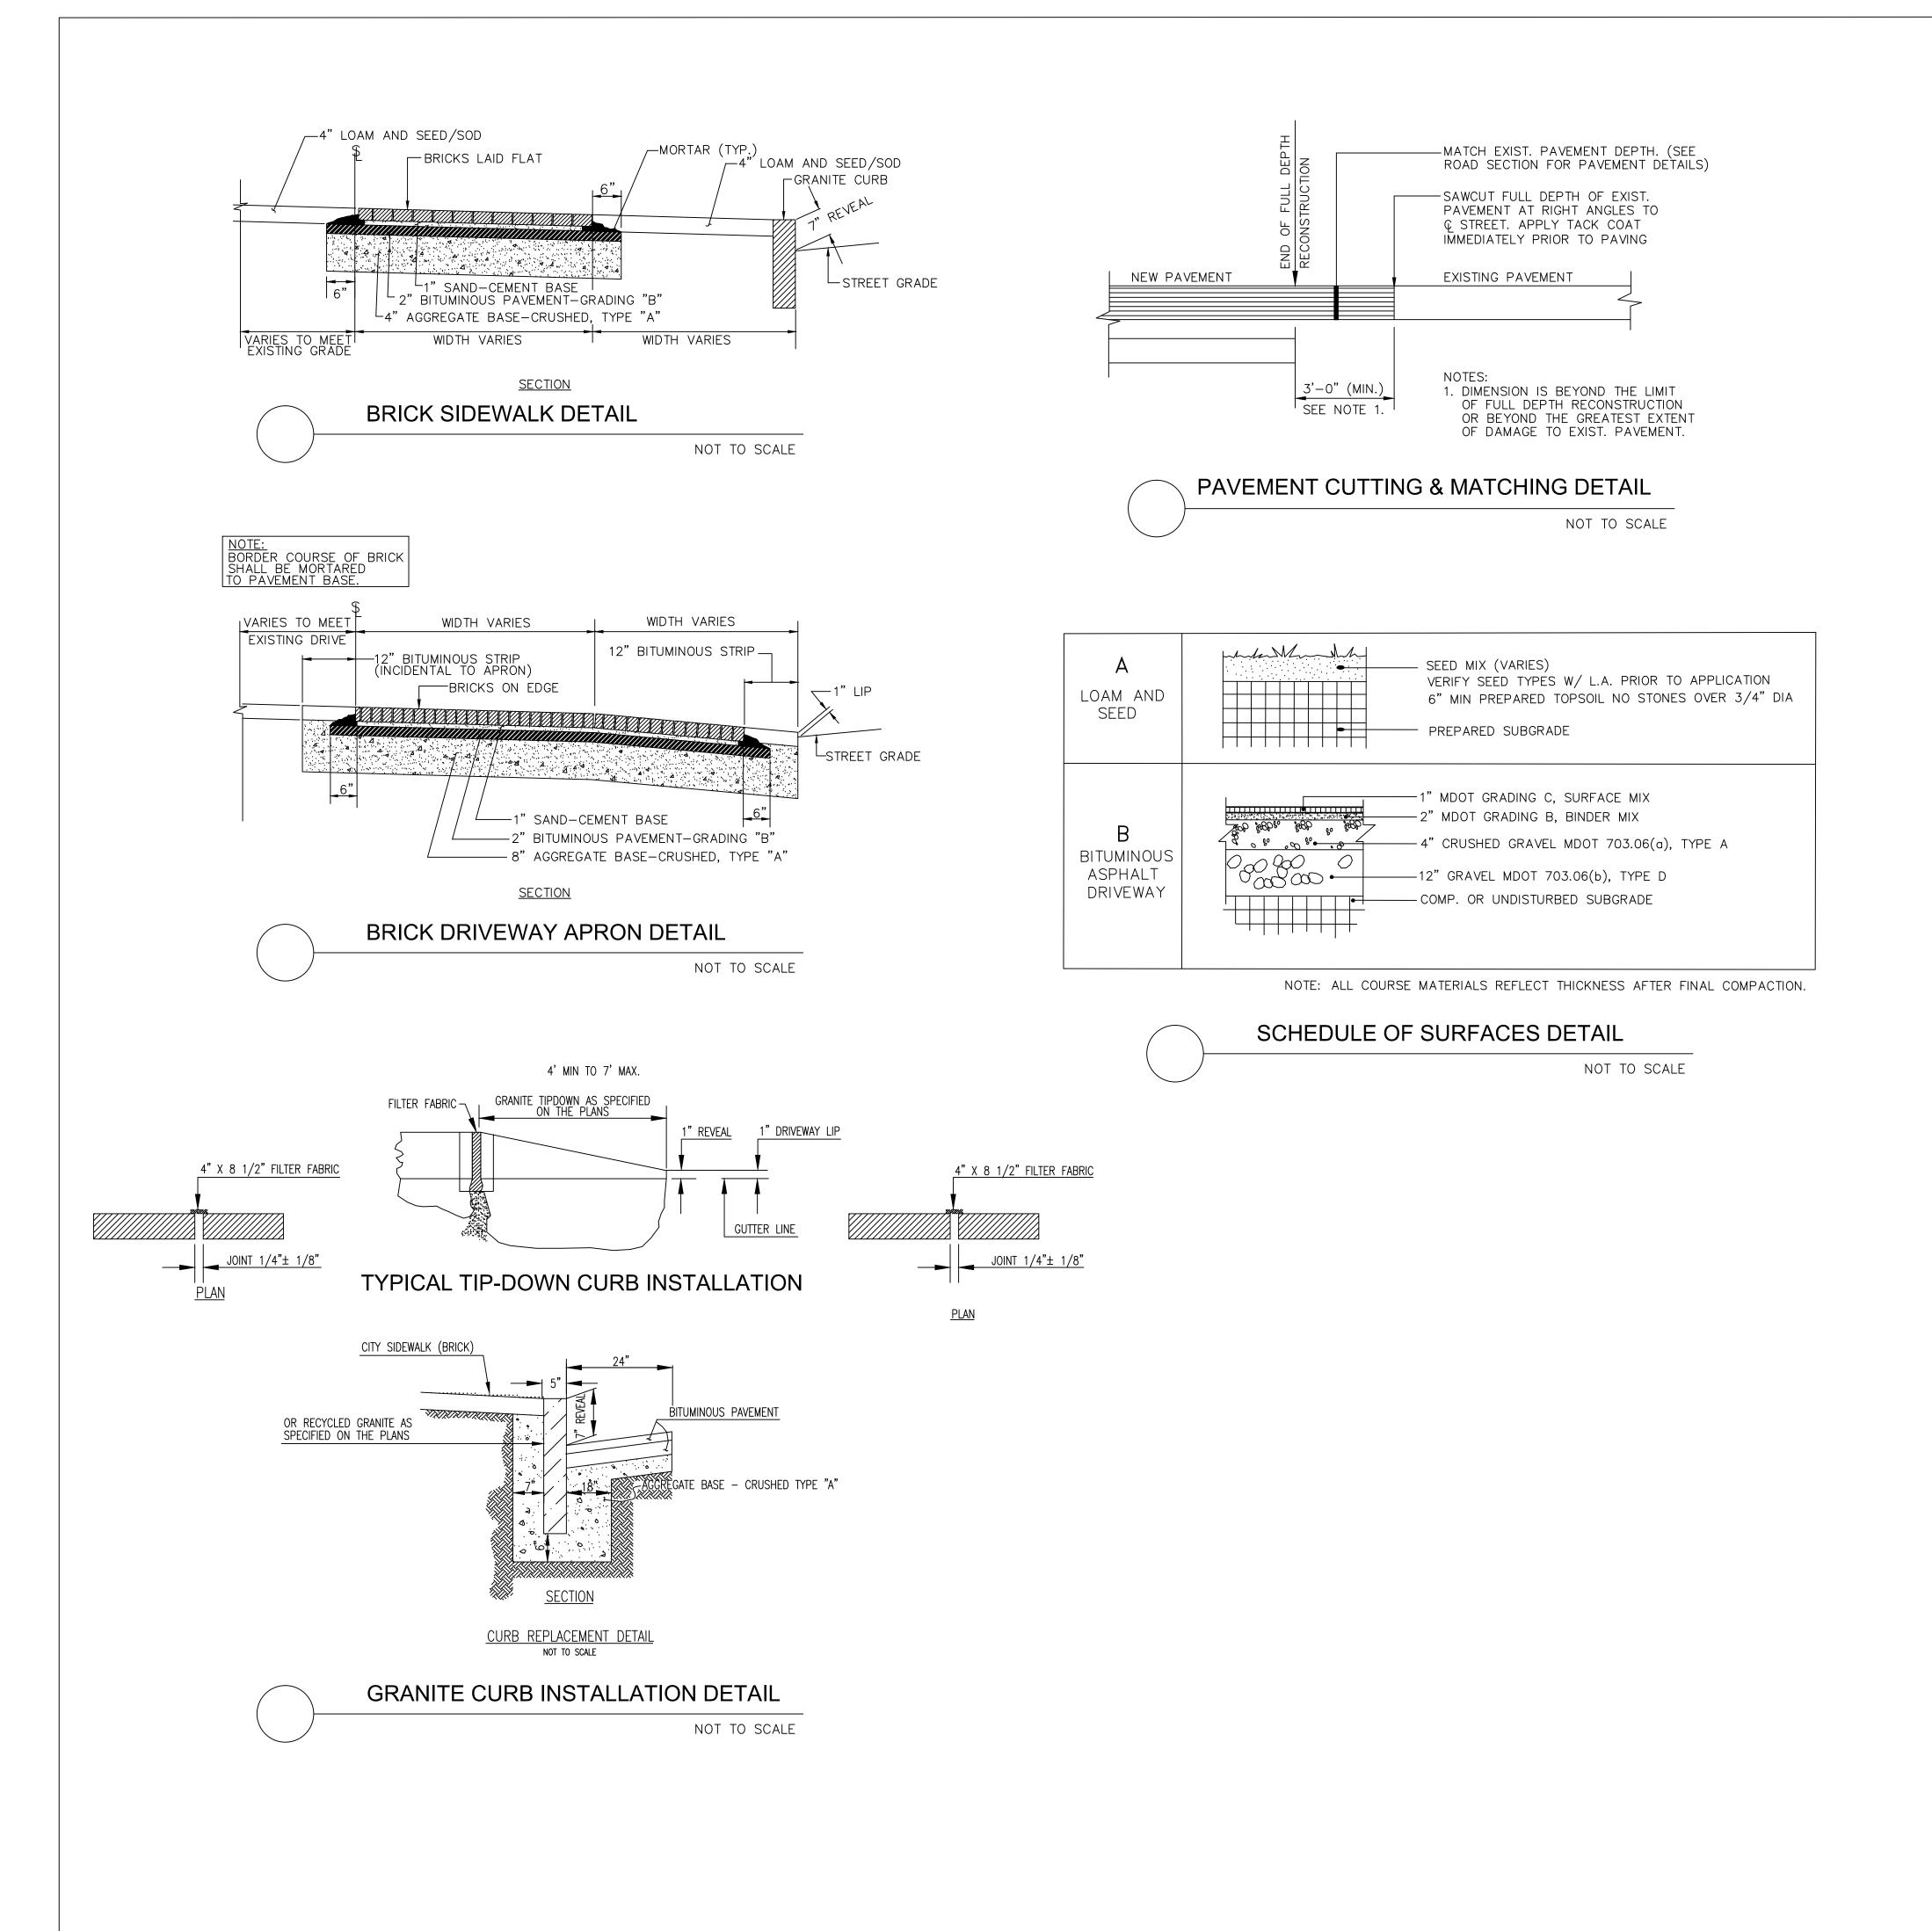

## BRAMLEY-SIMMONS RESIDENCE 71 OUEBEC STREET

71 QUEBEC STREET PORTLAND, ME

cowles studio | landscape architecture
45 Center Street Yarmouth, Maine 04096
207.415.4332 www.cowles-studio.com

Consultants:

SURVEYOR:
Nadeau Land Surveys, Inc.
918 Brighton Ave.
Portland, ME 04102
207-878-7870

ARCHITECT:
Kaplan-Thompson Archited

ARCHITECT:
Kaplan-Thompson Architects
424 Fore Street
Portland, ME 04101
207-842-2888

CONTRACTOR:
Redfern Properties
P.O. Box 8816
Portland, ME 04104
207-221-5746

Drawing Set:

ERMI

Date Revision

11.3.14 ISSUED FOR PERMIT

11.14.14 ISSUED FOR PERMIT

12.3.14 ISSUED FOR PERMIT

Drawing Set:

PERMIT DRAWINGS

Drawn:
TC
Checked:
Approved:
Drawing Title:

SITE DETAILS

Job Number:

Date: 10–3–2014 | Scale: AS SHOWN | Drawing Number:

L-4.0

© 2014 COWLES STUDIO