


MECHANICAL NOTES -

1. HUS/R PIPING SHALL BE 3/4" UNLESS NOTED OTHERWISE.
2. RANGE HOOD BY OTHERS.
3. CONNECT RANGE HOODS AND BATH FANS TO EXISTING DUCTWORK AND BRICK VENT UNLESS NOTED OTHERWISE.
4. HUS/R VALVES SHALL BE LOCATED UNDER FTR COVER.

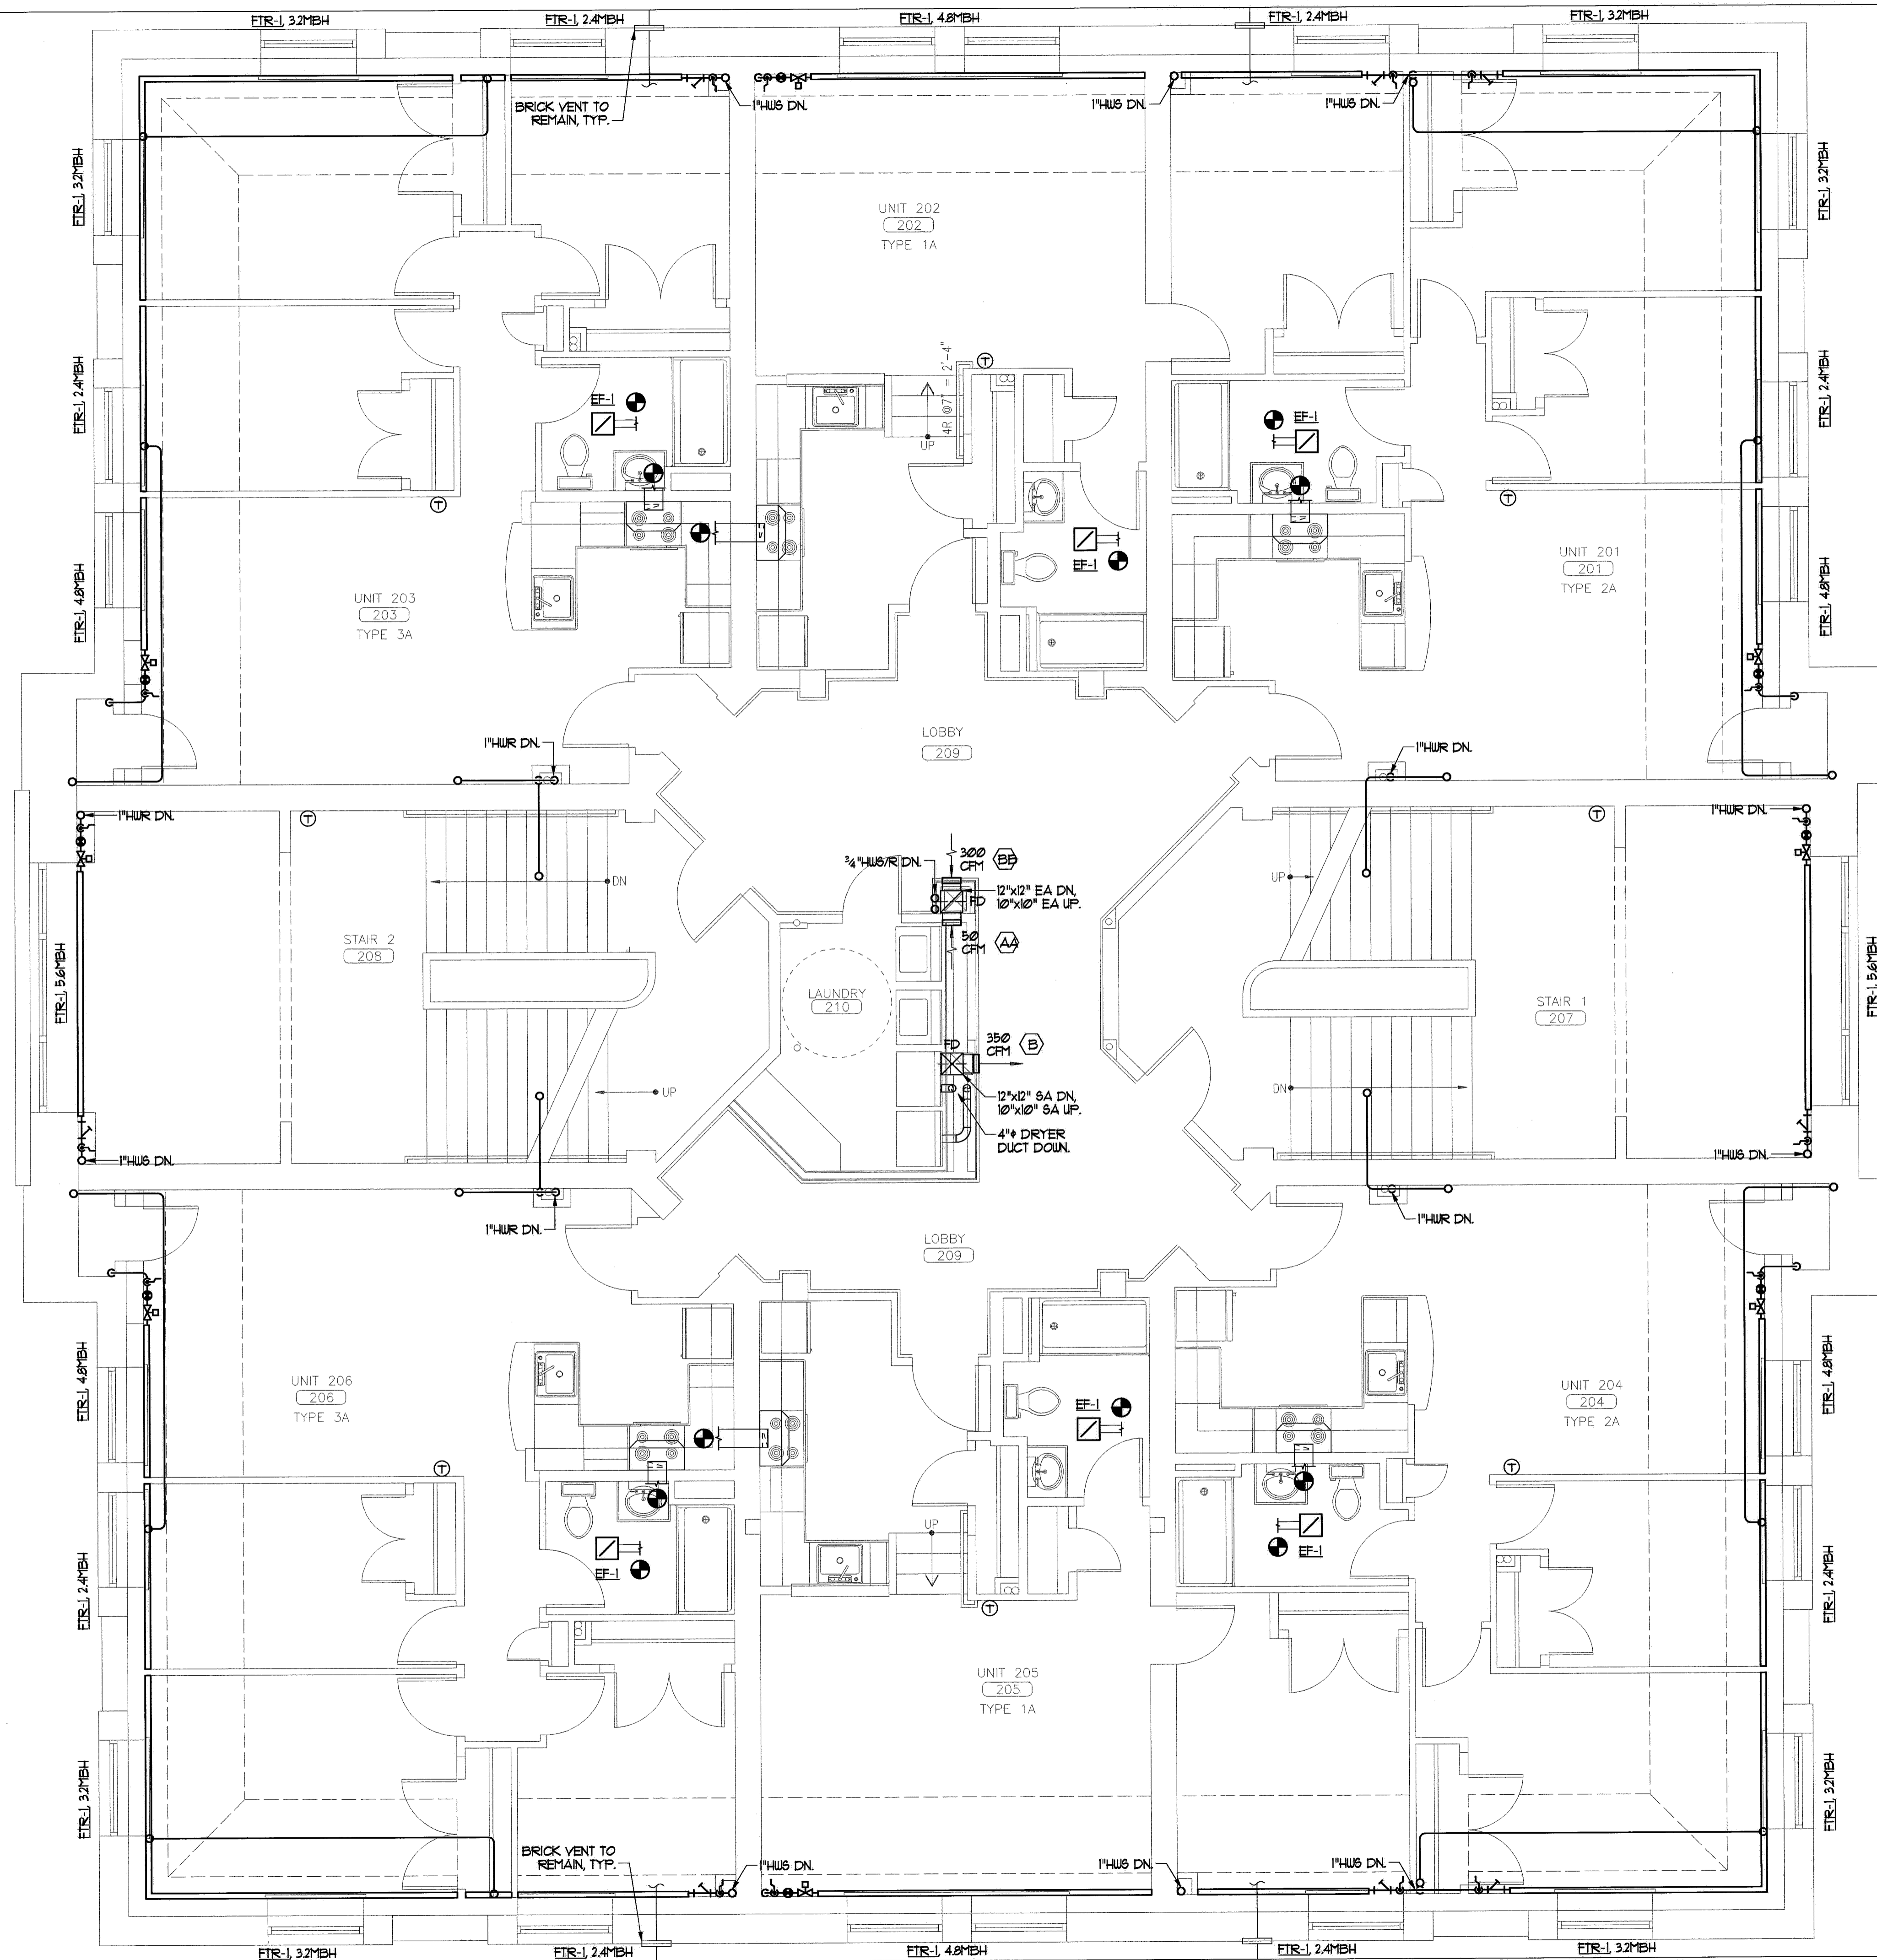

1 SECOND FLOOR MECHANICAL PLAN
REFERENCED FROM:

SCALE: 1/4" = 1'-0"



CWS Architects


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**Munjoy Commons
Apartments**

Portland, Maine

Project No: 07429

Drawing Title:
**EMERSON
SECOND FLOOR
MECHANICAL PLAN**

Scale: 1/4" = 1'-0"

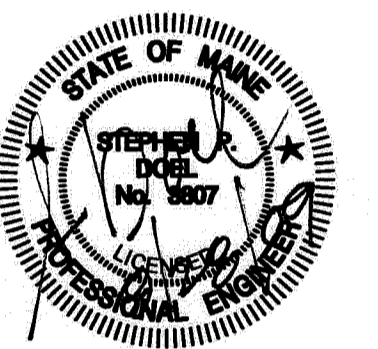Date: August 28, 2009

Revisions:

- △
- △
- △
- △
- △

Drawing Number:
**EMERSON
M1.3**