


**MECHANICAL NOTES -**

1. HUS/R PIPING SHALL BE 3/4" UNLESS NOTED OTHERWISE.
2. RANGE HOOD BY OTHERS.
3. CONNECT RANGE HOODS AND BATH FANS TO EXISTING DUCTWORK AND BRICK VENT UNLESS NOTED OTHERWISE.
4. HUS/R VALVES SHALL BE LOCATED UNDER FTR COVER.

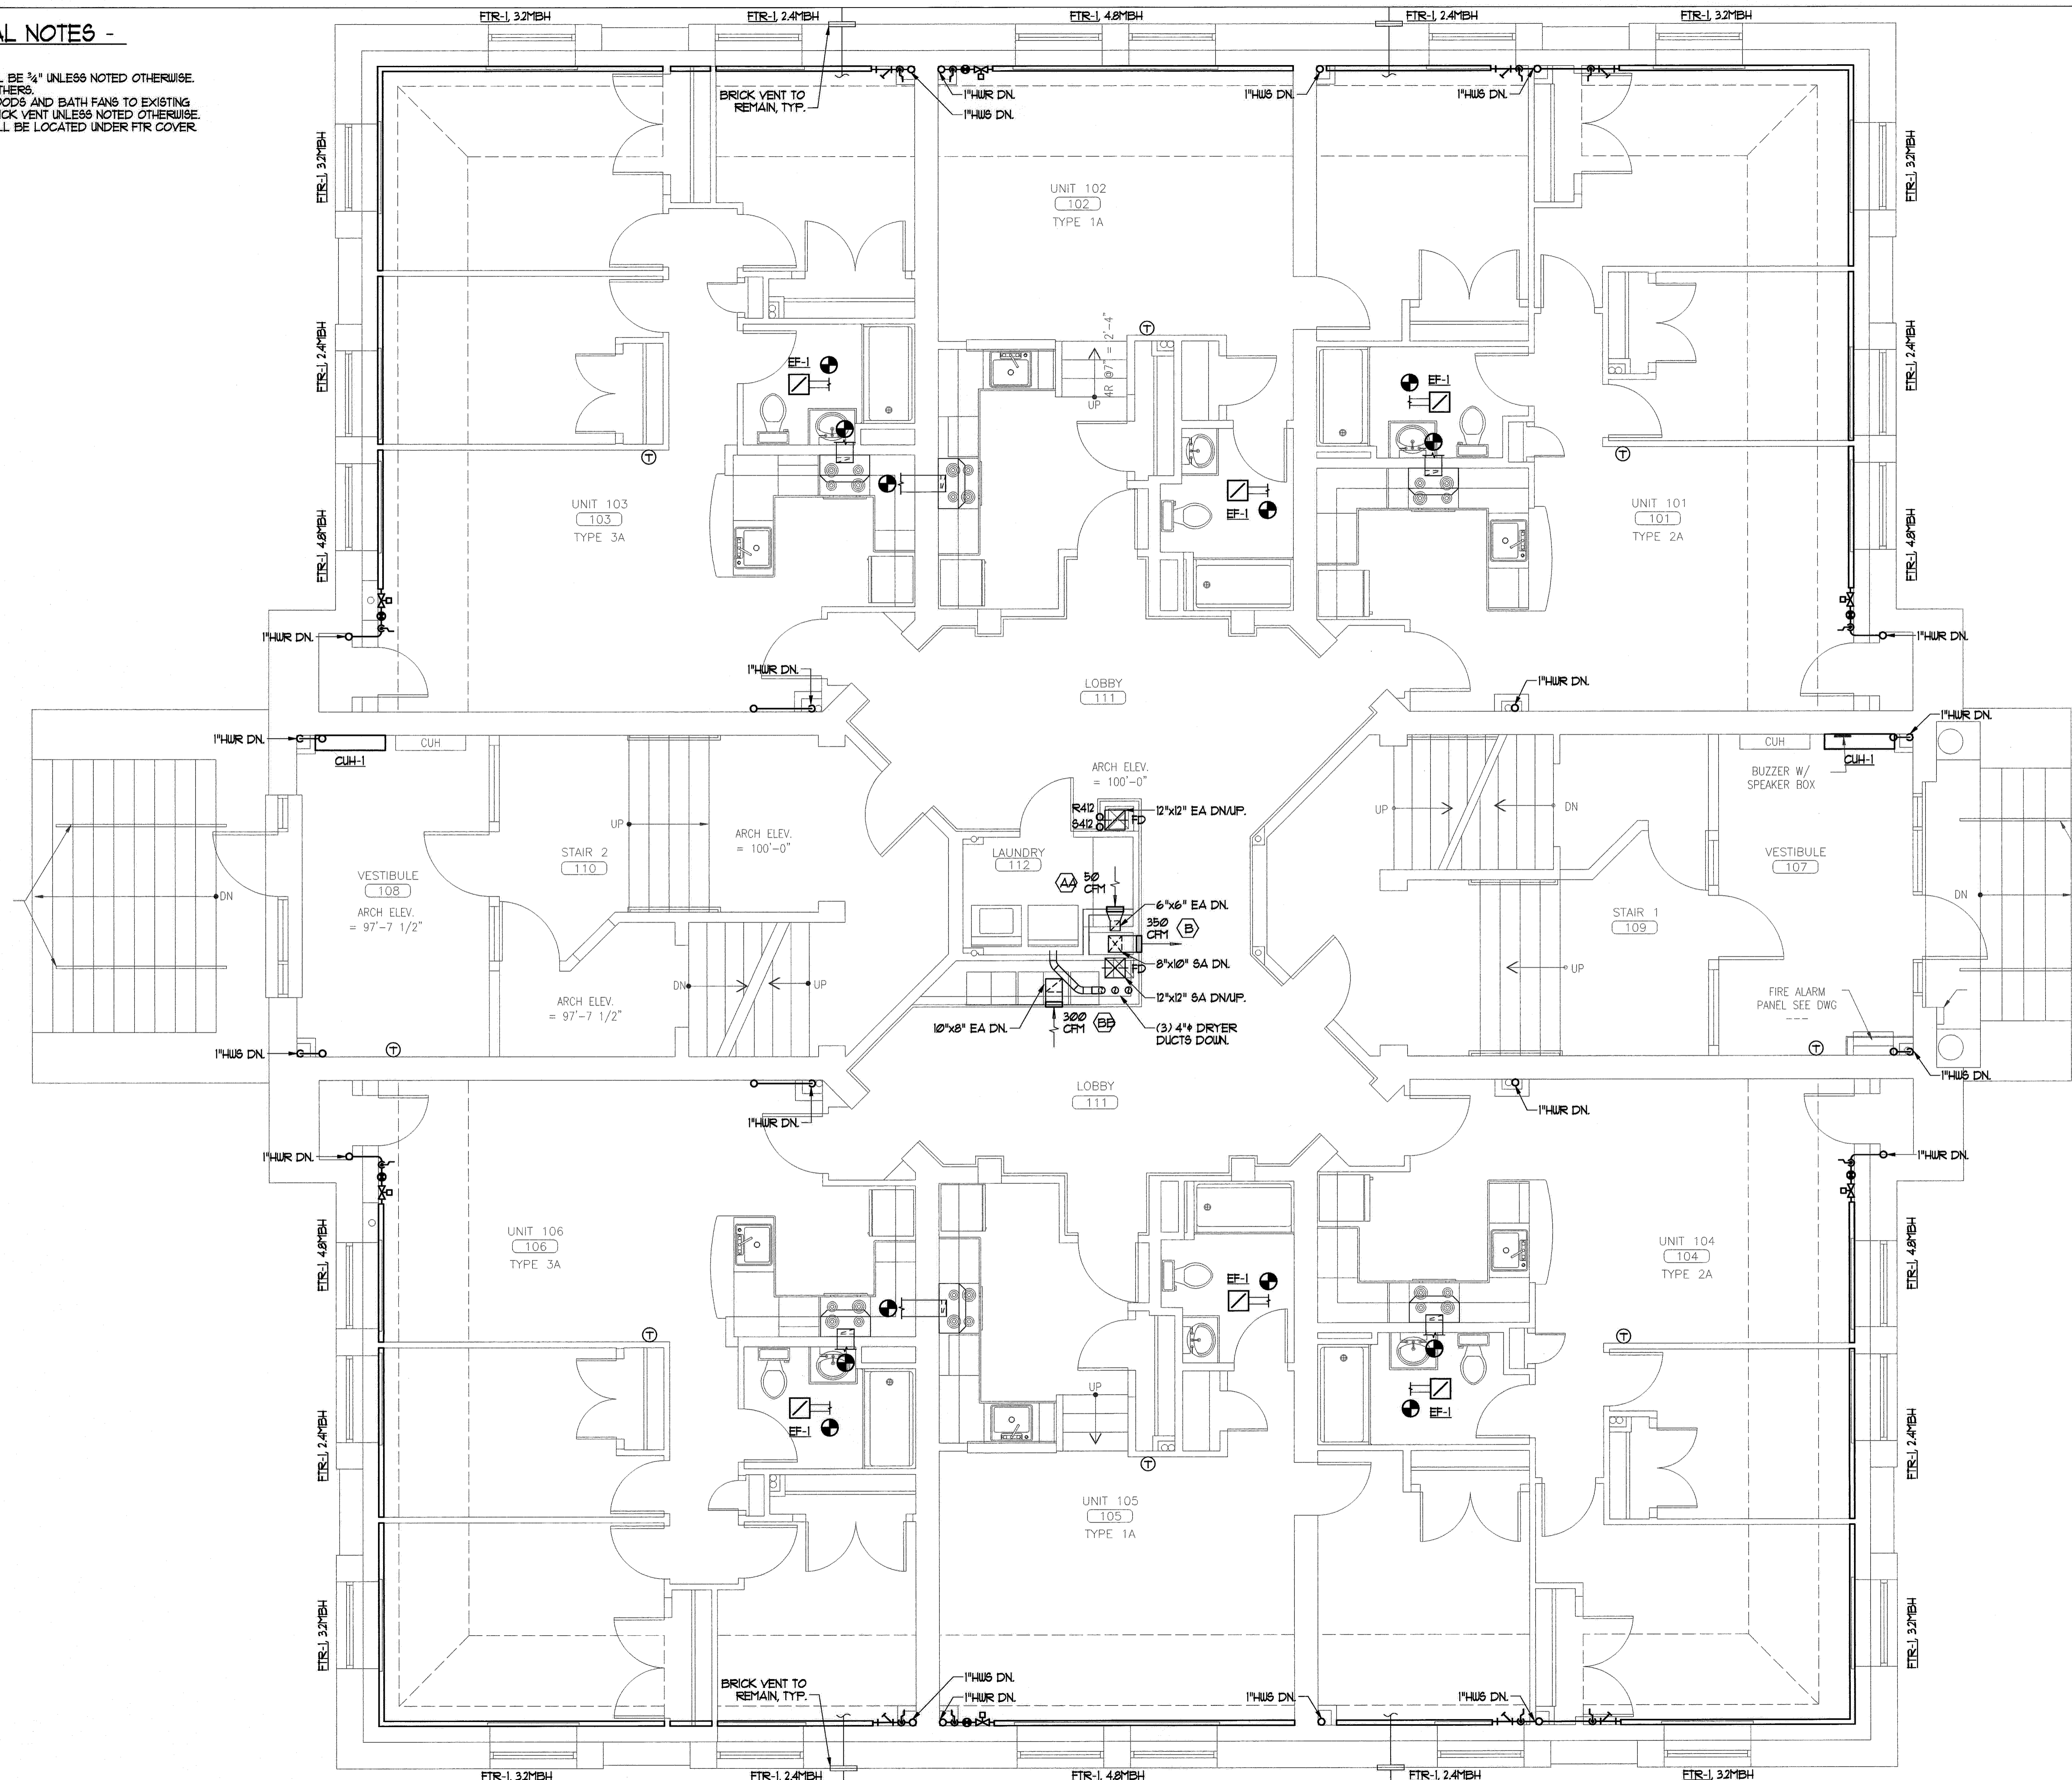

**1** FIRST FLOOR MECHANICAL PLAN  
REFERENCED FROM:

SCALE: 1/4" = 1'-0"

**CWS**  
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Space Planning  
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434 Cumberland Avenue  
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Portland, Maine

Project No: 07429

Drawing Title:  
**EMERSON  
FIRST FLOOR  
MECHANICAL PLAN**

Scale: 1/4" = 1'-0"  
Date: August 28, 2009  
Revisions:

Drawing Number:  
**EMERSON  
M1.2**