



Renovations to  
 49 Merrill  
 Street

Portland, Maine


**MATERIALS SCHEDULE**

- A Cast in Place Concrete
- A1 Concrete Slab on Grade
- A2 Concrete Masonry Units
- A3 Brick
- A4 Field Stone
- A5 Cut Granite
- B Wood Construction
- B1 Plywood
- B2 Wood Siding
- B3 Wood Trim, Painted
- B4 Interior Wood Trim
- B5 Douglas Fir Brackets, Painted
- B6 Fir Siding
- B7 6" x 6" Douglas Fir Column, Pt
- B8 Wood Siding, Paint
- C Red Cedar Sheetrock, Paint
- C1 Fiberglass Screen
- D Cellulose Insulation
- D1 Rigid Insulation
- D2 Reroofing
- D3 Waterproof Underlayment
- E Fiberglass Roof Shingles
- E1 Copper Roof Edge
- E2 Copper Flashing
- E3 Ridge Vent
- F Vapor Barrier
- F1 Air Infiltration Barrier
- F2 Felt Underlayment
- G Aluminum Clad Wood Window
- H Wood Siding
- J Gypsum Board
- J1 Fire Retardant Gypsum Board
- K Wood Strip Flooring
- K1 Ceramic Tile
- K2 Wood Siding
- K3 Porcelain Tile
- K4 Exterior Wood Siding
- L Wall to Wall Carpet
- L1 Stone Counter-top
- M Aluminum Louver, Painted
- M1 Corrugated PVC Soffit vent
- N Painted Finish
- N1 Stain and Clear Finish
- O Crushed Stone
- O1 Compacted Fill
- O2 Foundation Drain
- P Blue Stone Paving
- P1 Sealant
- R Bituminous Asphalt Paving
- S Cedar Handrail, Painted
- S1 Cedar Railing, Painted

MERRILL STREET

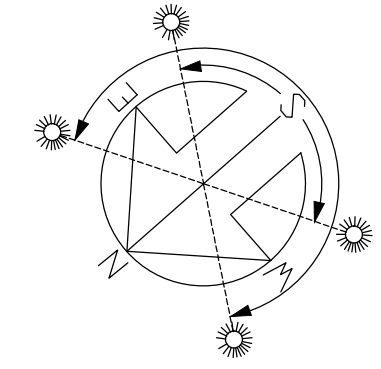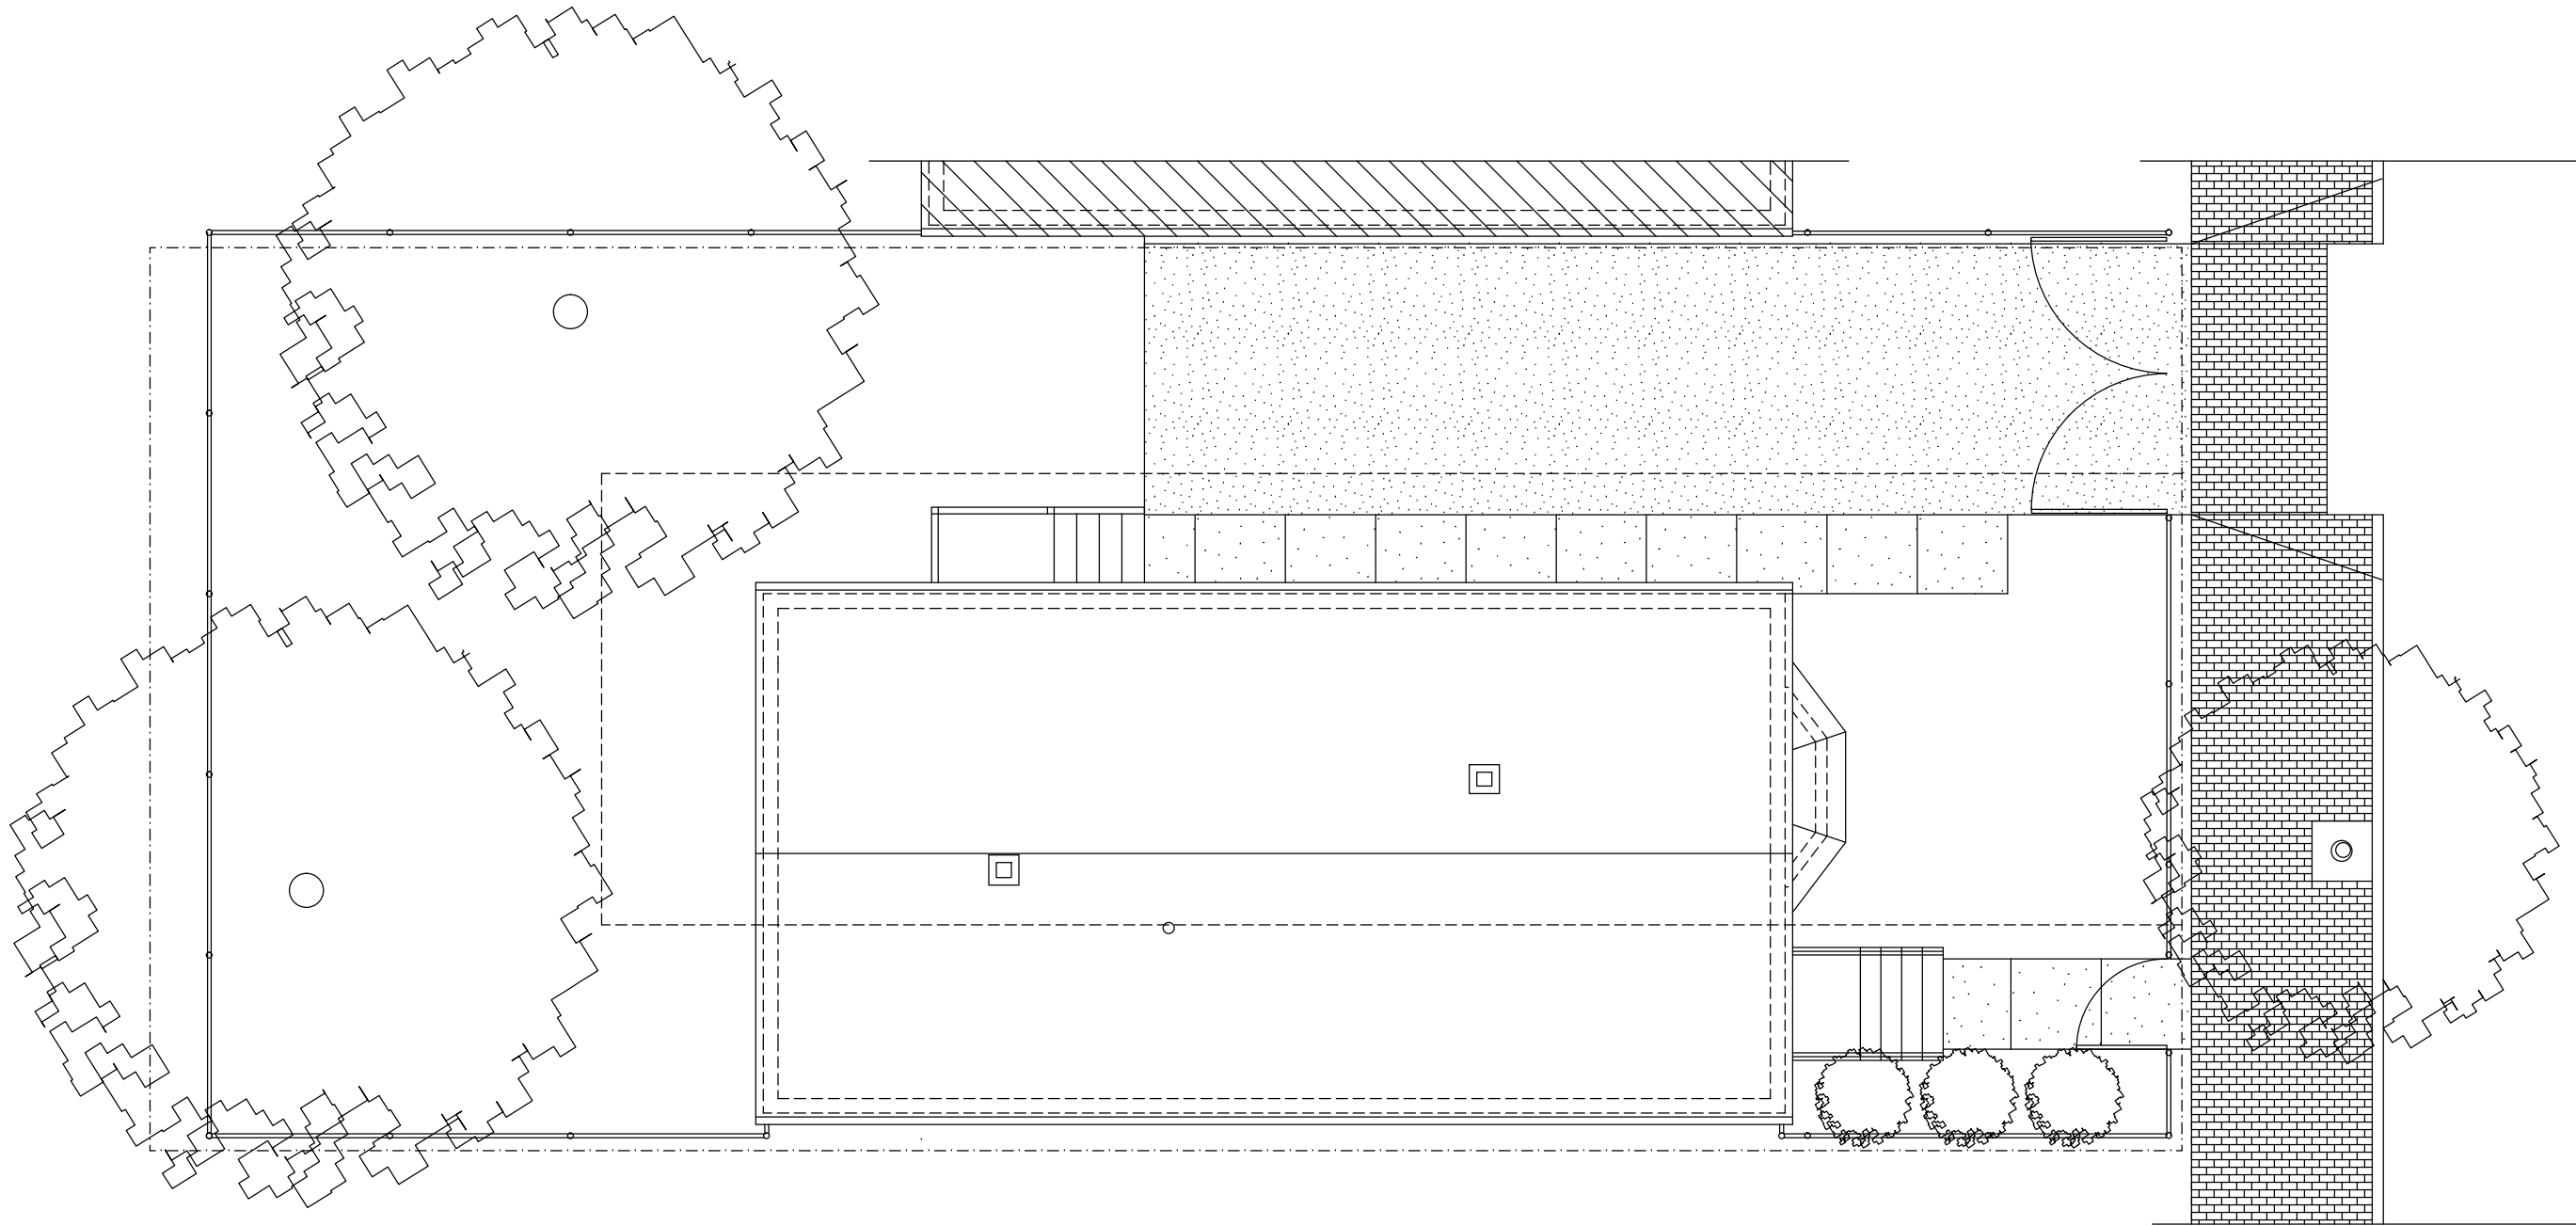

EXISTING SITE PLAN

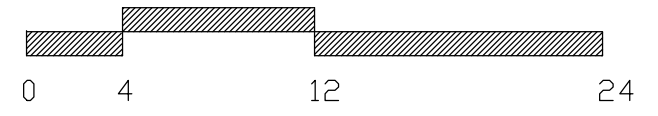

Revision

Issue PROGRESS SET

Title Existing Condition Site Plan

Date: / 9 / 2010  
 Scale: 1/8" = 1'-0"  
 Drawn By: [blank]  
 Checked By: [blank]  
 Approved By: [blank]  
 Project No: 2010

SWS NO EC1.0