


## FIRE SPRINKLER RISER DETAIL SCALE: N.T.S.

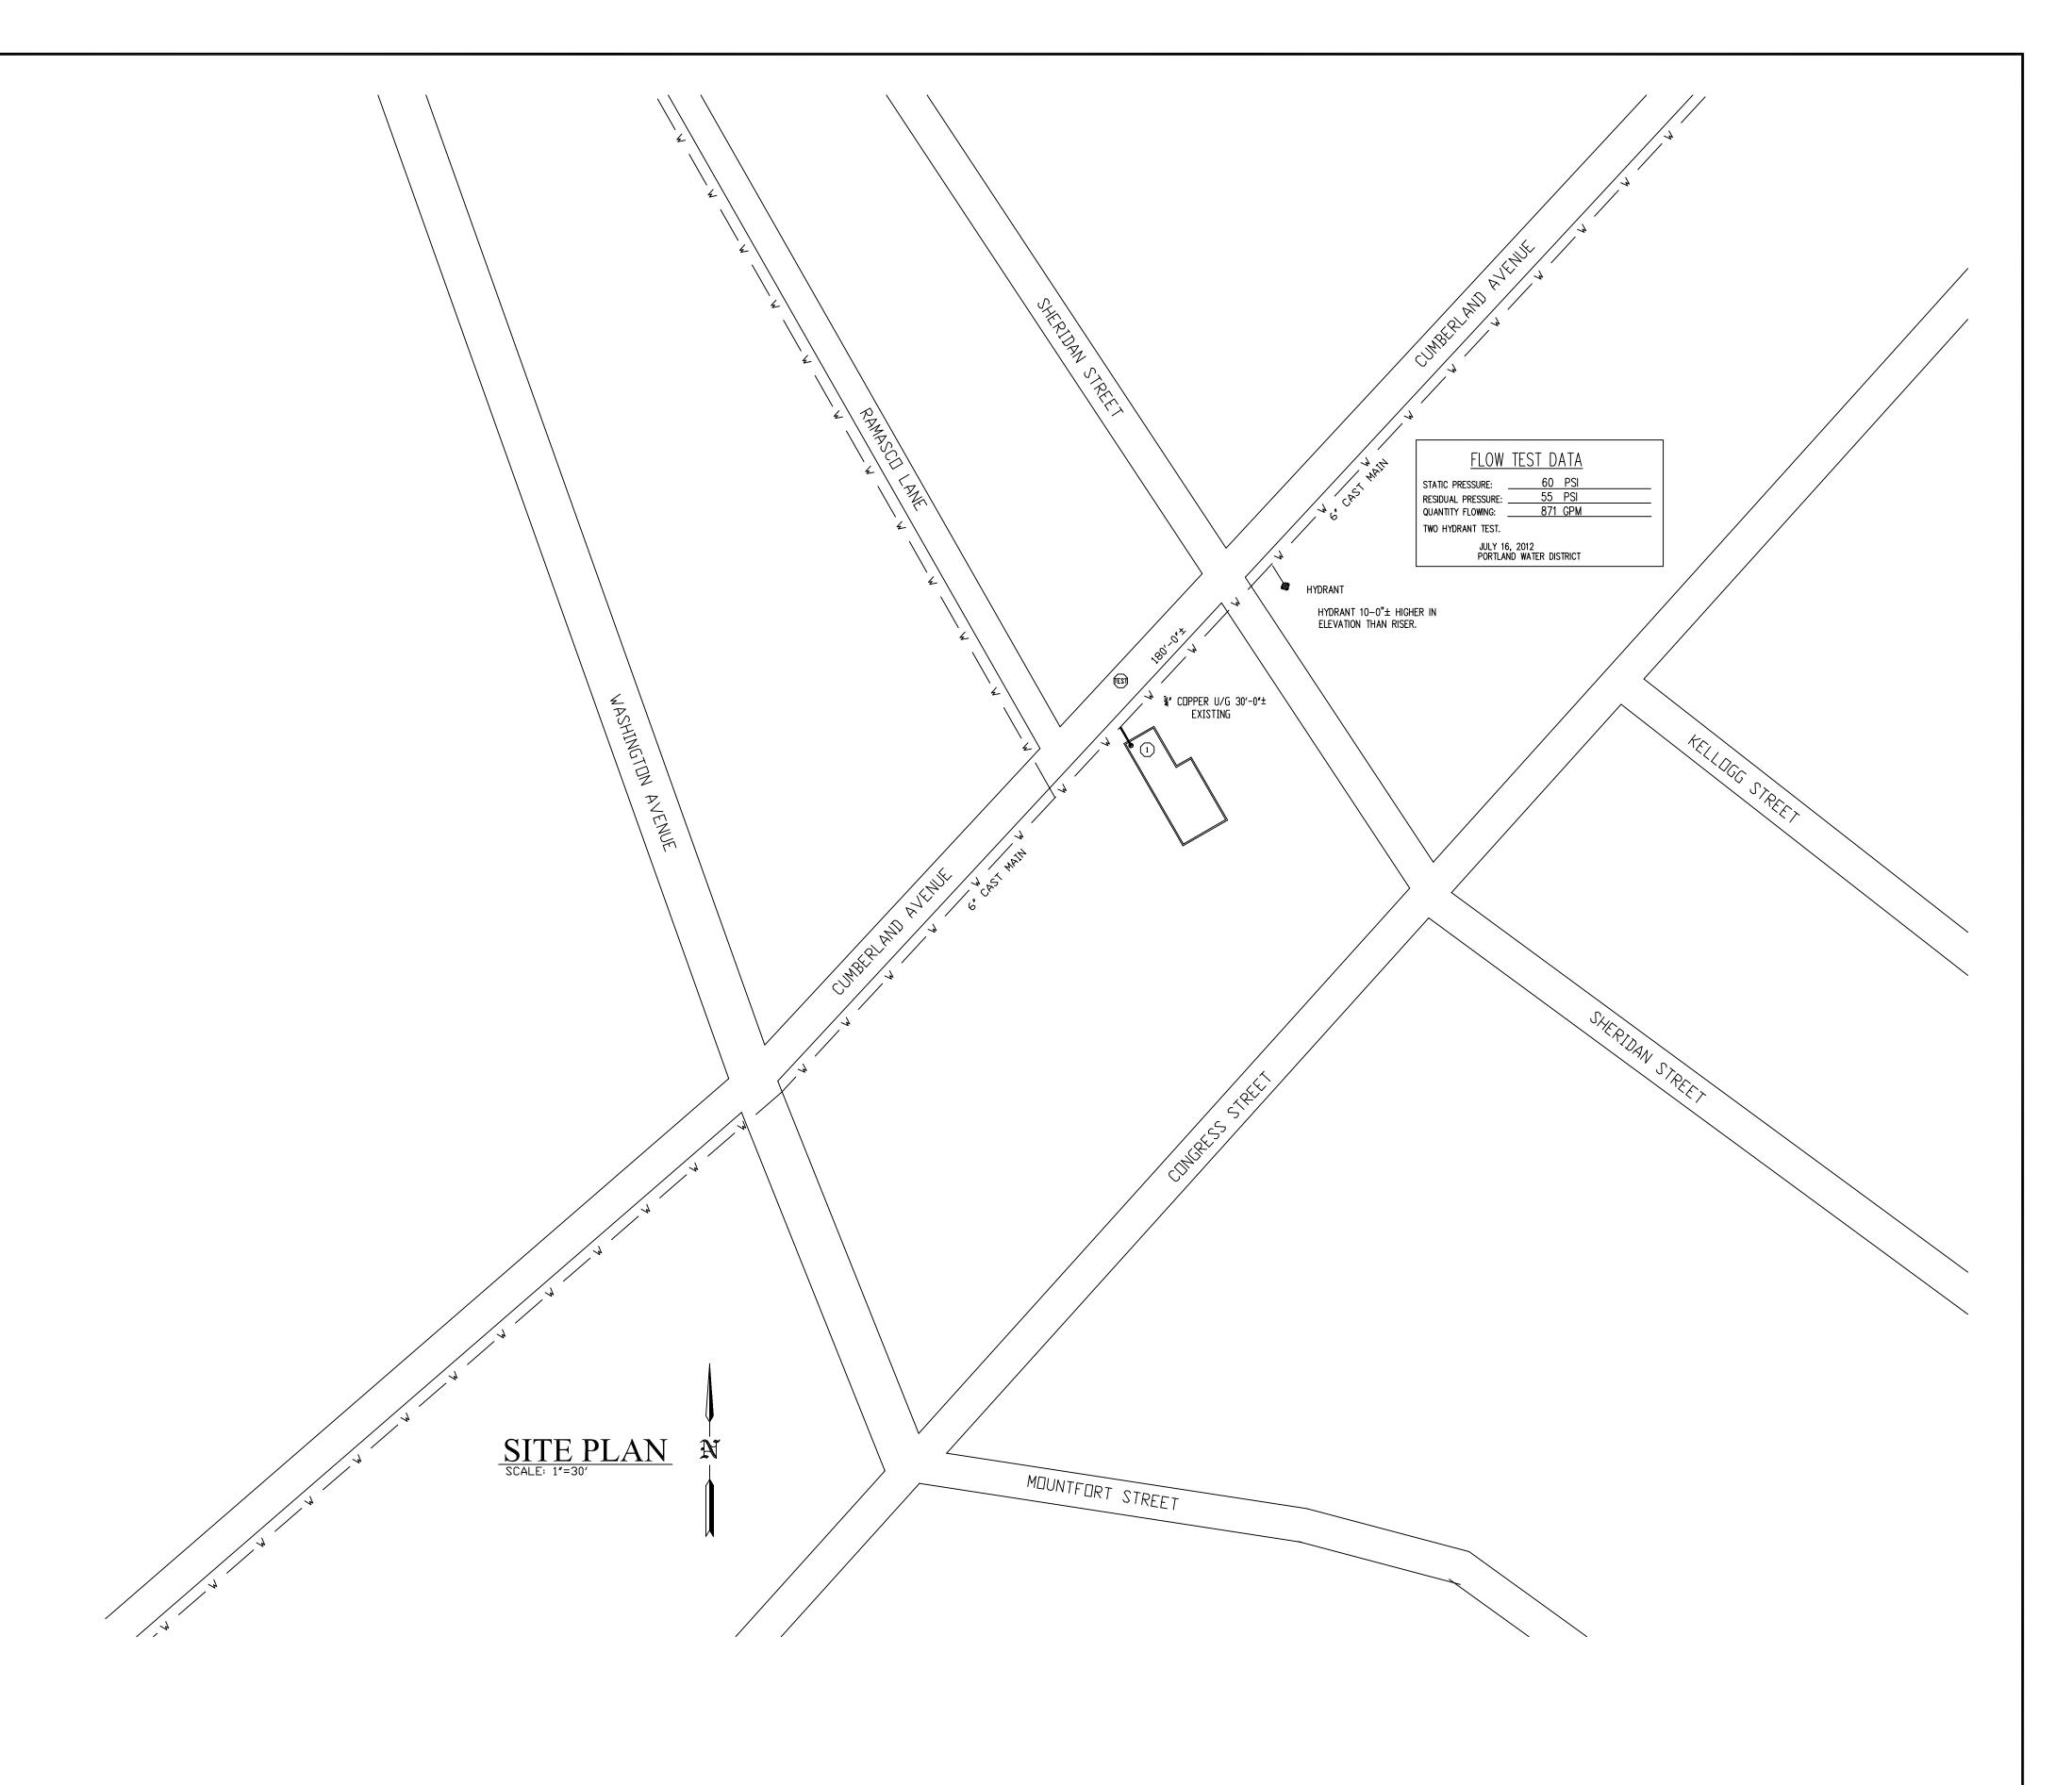

## GENERAL NOTES

SYSTEM TO BE DESIGNED AND INSTALLED IN ACCORDANCE WITH NFPA-13D 2010. PIPE AND FITTINGS TO BE COMBINATION OF BLACK STEEL SCH. 40 TYPE AND APPROVED BLAZEMASTER PLASTIC CPVC DESIGNED AND APPROVED TO BE USED WITH THIS STANDARD. ALL HANGERS TO BE SPACED IN ACCORDANCE WITH MANUFACTURER'S RECOMMENDATIONS. MAX SPACING OF RESIDENTIAL PENDENT SPRINKLERS TO BE 16'x16'. MAX SPACING OF RESIDENTIAL SIDEWALL SPRINKLERS TO BE 14'x14'. ALL WIRING OF DEVICES BY OTHERS.

SPARE SPRINKLERS OF EACH TYPE SHALL BE PROVIDED PER NFPA 13.

## SPRINKLERS MAY BE OMITTED FROM THE FOLLOWING:

PROVIDING A 15 MINUTE THERMAL BARRIER.

1) BATHROOMS WHERE THE AREA DOES NOT EXCEED 55 SQ. FT. AND THE WALLS AND CEILINGS, INCLUDING BEHIND FIXTURES, ARE OF NON COMBUSTIBLE OR LIMITED COMBUSTIBLE MATERIALS

2) CLOTHES CLOSETS, LINEN CLOSETS, AND PANTRIES WITHIN THE DWELLING UNITS WHERE THE AREA OF THE SPACE DOES NOT EXCEED 24 SQ. FT. AND THE LEAST DIMENSION DOES NOT EXCEED 3 FT. AND THE WALLS AND CEILINGS ARE SURFACED WITH NON COMBUSTIBLE OR LIMITED COMBUSTIBLE

MATERIALS AS DEFINED BY NFPA.

3) ANY PURCHES, BALCONIES, CORRIDORS, AND STAIRS THAT ARE OPEN AND ATTACHED.

4) ATTICS, PENTHOUSE EQUIPMENT ROOMS, CRAWL SPACES, FLOOR/CEILING SPACES, ELEVATOR SHAFTS, AND OTHER CONCEALED SPACES THAT ARE NOT USED OR INTENDED FOR LIVING PURPOSES OR STORAGE.

MAINTENANCE OF THE SPRINKLER SYSTEM IS THE RESPONSIBILITY OF THE OWNER. PROTECTION OF THE SPRINKLER SYSTEM AGAINST FREEZING IS THE RESPONSIBILITY OF THE OWNER.

		TOTAL SPRINKLERS THIS DRAWING		$ \models =  \exists - \text{EXIST UNDERGROUND} $	- FLUSH FIRE DEPT. CONNECTION			
				- SWING CHECK VALVE	<ul> <li></li></ul>	RESPONSIBLE MANAGING SUF CONTRACTOR LICENSE #295	209 QUAKER RIDGE ROAD  CASCO, MAINE 04015	FP-1o
				FIRE DEPT. CONNECTION  Output  Output	o-□ - RISER W/ELEC. FLOW SWITCH	4.       5.	FREEDOM FIRE PROTECTION, INC.	
				— KEY VALVE	▲ — RISER W/ALARM VALVE  ◆ — RISER W/DRY VALVE	3.	FIRE PROTECTION PLAN	SHEET No.
		SPRINKLER TYPE   IDENTIFICATION NO.   MFG.   ESC	. MODEL FINISH ORIFICE TEMP. SYMBOL QUAN	POST INDICATOR VALVE	- ALARM CHECK VALVE	2.		SCALE AS
REVISIONS	NOTES	SPRINKLER TYPE   IDENTIFICATION NO.   MFG.   ESC	HEAD COUNT . MODEL FINISH ORIFICE TEMP. SYMBOL QUAN	STANDARD SYMBOLS	STANDARD SYMBOLS	INSPECTIONS	PORTLAND, MAINE 04101	DRAWN BY M
							82 CUMBERLAND AVENUE	DATE 12