43 CUMBERLAND AVENUE APARTMENTS

41 CUMBERLAND AVENUE PORTLAND, MAINE

PROJECT DIRECTORY

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STRUCTURAL **ENGINEER**

STRUCTURAL INTEGRITY CONSULTING ENGINEERS, INC. 77 OAK STREET PORTLAND, ME 04101 P: 207.774.4614

ROUGH OPENING

SYMBOLS

ROOM NUMBER DOOR NUMBER WINDOW TYPE BUILDING SECTION WALL SECTION DETAIL SECTION CASEWORK ELEVATION INTERIOR ELEVATION VERTICAL ELEVATION PARTITION TYPE COLUMN CENTER LINE

MATERIALS

| | CONCRETE |
|----------|-----------------------|
| | CONCRETE MASONRY UNIT |
| | GRAVEL |
| | SOIL |
| // // // | STEEL |
| | WOOD FRAMING |
| | WOOD BLOCKING |
| | PLYWOOD |
| | GYPSUM BOARD |
| | SAT |
| | BATT INSULATION |

RIGID INSULATION

FINISH WOOD

EXPANSION MATERIAL

EC-1.1 EXISTING FLOOR PLANS EC-1.2 EXISTING ELEVATIONS A-1.0 PROPOSED FLOOR PLANS A-1.1 PROPOSED FLOOR PLANS A-2.0 PROPOSED ELEVATIONS A-2.1 PROPOSED ELEVATIONS A-3.0 BUILDING SECTIONS A-3.1 BUILDING SECTIONS A-4.0 LIFE SAFETY PLANS STUDIO BUILDING: A-1.0 FLOOR PLANS

A-2.0 ELEVATIONS

A-3.0 BUILDING SECTIONS

MAIN BUILDING:

CIVIL DRAWINGS

TITLE SHEET

DETAILS SHEET

EC-1.0 EXISTING FLOOR PLANS

T-1.0 TITLE SHEET & GENERAL NOTES

BOUNDARY SURVEY

ARCHITECTURAL DRAWINGS

SITE, GRADING & UTILITY PLAN

POST DEVELOPMENT PLAN

DRAWING INDEX

STRUCTURAL DRAWINGS

S1.0 GENERAL NOTES, ETC. S1.1 MAIN BUILDING 4TH LEVEL FRAMING PLAN

S1.2 MAIN BUILDING ROOF FRAMING PLAN

S1.3 STUDIO BUILDING FOUNDATION & 1ST FLOOR FRAMING PLANS S1.4 STUDIO BUILDING 2ND FLOOR & ROOF FRAMING PLANS

S2.1 SECTIONS

ABBREVIATIONS

F: 866.793.7835

| AB | ANCHOR BOLT | FDKB | FIRE DEPARTMENT KEY BOX | MAX | MAXIMUM | S | SOUTH |
|------------|-------------------------------|-------------------|-------------------------|--------|---------------------------------|--------|-----------------------------|
| AFF | ABOVE FINISH FLOOR | FDN | FOUNDATION | MECH | MECHANICAL | SAT | SUSPENDED ACOUSTICAL |
| ALUM OR AL | ALUMINUM | FX | FIRE EXTINGUISHER | MFGR | MANUFACTURER | | TILE CEILING |
| | | FFE | FINISH FLOOR ELEVATION | MIN | MINIMUM | SC | SHOWER CURTAIN |
| BIT | BITUMINOUS | FIN | FINISH | MISC | MISCELLANEOUS | SD | SOAP DISPENSER |
| BM | BENCH MARK | FIN FL OR FF | FINISH FLOOR | MRGB | MOISTURE RESISTANT GYPSUM BOARD | SCHED | SCHEDULE |
| BOT | BOTTOM | FIN GR | FINISH GRADE | MTL | METAL | SECT | SECTION |
| BRG | BEARING | FL | FLOOR | | | SHT | SHEET |
| BRK | BRICK | FR | FIRE RATING | N | NORTH | SIM | SIMILAR |
| | | FRMG | FRAMING | NA | NOT APPLICABLE | SND | SANITARY NAPKIN DISPOSAL |
| C | CARPET | FT | FEET (FOOT) | NIC | NOT IN CONTACT | SQ | SQUARE |
| C CAB | CABINET | FV | FIELD VERIFY | NO | NUMBER | STD | STANDARD |
| CC | CENTER TO CENTER | | | NOM | NOMINAL | STL | STEEL |
| | CENTER TO CENTER CENTER LINE | GA | GAUGE | NTS | NOT TO SCALE | STRUCT | STRUCTURAL |
| CL | CEILING | GALV | GALVANIZED | | | SV | SHEET VINYL |
| CLG | | GB | GRAB BARS | OA | OVERALL | | |
| CONC | CONCRETE | GC | GENERAL CONTRACTOR | OC | ON CENTER | T | TEMPERED (GLASS) |
| CONT | CONTINUOUS | GWB | GYPSUM WALL BOARD | OD | OUTSIDE DIAMETER | THK | THICKNESS |
| DDI | DOLIDI E | | | OPNG | OPENING | TO | TOP OF |
| DBL | DOUBLE DIAMETER | НС | HANDICAP | OPP | OPPOSITE | TOB | TOP OF BEAM |
| DIA | | HM | HOLLOW METAL | 011 | 011 00112 | TOM | TOP OF MASONRY |
| DIM | DIMENSION DOES NOT A PRI V | HORZ | HORIZONTAL | Р | PAINT | TOW | TOP OF WALL |
| DNA | DOES NOT APPLY | HT | HEIGHT | PTD | PAINTED | TP | TOILET PAPER DISPENSER |
| DTL | DETAIL | 111 | HEIGHT | PL | PLATE | TUON | TYPICAL UNLESS OTHERWISE NO |
| DWG | DRAWING | IF | INSIDE FACE | PLY WD | PLYWOOD | TYP | TYPICAL |
| | | IN | INCHES | PNL | PANEL | | |
| E | EAST | INSUL | INSULATION | P.T. | PRESSURE TREATED | VB | VAPOR BARRIER |
| EA | EACH | INSUL | INTERIOR | PTN | PARTITION | VCT | VINYL COMPOSITION TILE |
| EF | EACH FACE | 11\(\frac{1}{1}\) | INTERIOR | | | VERT | VERTICAL |
| EL | ELEVATION | JNT OR JT | JOINT | D.F. | PEREN | | |
| ELEC | ELECTRICAL | JIVI OK JI | JOHVI | RE | REFER | W | WEST |
| ELEV | ELEVATOR | LOC | T 0 0 1 m 10 1 1 | REF | REFRIGERATOR | W/ | WITH |
| EHO | ELECTRO-MAGNETIC HOLD OPEN | LOC | LOCATION | REINF | REINFORCED | WC | WATER CLOSET |
| ETR | EXISTING TO REMAIN | | | REQD | REQUIRED | WD | WOOD |

GENERAL NOTES

- ADA/AG, MPS.
- 2. ALL WOOD IN CONTACT WITH CONCRETE SHALL BE PRESSURE PRESERVATIVE TREATED.
- 3. CONTRACTOR SHALL WORK FROM GIVEN DIMENSIONS AND LARGE SCALE DETAILS ONLY. DO NOT SCALE THE DRAWINGS.
- 4. INSTALL BLOCKING FOR SURFACE APPLIED FIXTURES, TRIM, CABINETS, COUNTER TOPS, AND GRAB BARS WHEN MOUNTED ON STUD WALLS, INCLUDING ALL FUTURE INSTALLATIONS.
- 5. ALL GRAB BARS SHALL BE ABLE TO SUPPORT A DEAD WEIGHT OF 250 LBS AT ANY POINT.
- 6. INSTALL MOISTURE RESISTANT GYPSUM BOARD IN BATHROOMS & HIGH HUMIDITY AREAS. MOISTURE RESISTANT FIRECODE G.W.B. @ ALL FIRE RATED BATH ROOMS. SHOWERS ALL SIDES TO HAVE
- 7. ALL CAULKING AROUND WINDOWS SHALL BE NON-HARDENING TYPE SEALANT.
- 8. INSTALL U.L. SLEEVE FIRE-STOPPING SYSTEM & FIRE RATED SEALANTS EQUAL TO THE FIRE RATED FLOOR, CEILING AND WALL ASSEMBLY.
- 9. FIRESTOP VERTICAL MECHANICAL CHASES @ FLOOR & CEILING U.L. RATED PENETRATIONS. CAULK JOINTS. COORDINATE AND FLASH ALL ROOF/WALL PENETRATIONS WITH THE SUB-TRADES.
- 10. CONTINUE SEPARATION WALLS TO UNDERSIDE OF FLOOR/CEILING ABOVE. UNIT TO UNIT, UNIT TO CORRIDOR, CORRIDOR WALLS, STORAGE WALLS, STAIRWELL WALLS, ETC.
- 11. REPORT ANY AND ALL DISCREPANCIES TO THE ARCHITECT PRIOR TO PROCEEDING WITH WORK.
- 12. PROJECT ASSUMES ALL EXISTING HAZARDOUS MATERIALS HAVE BEEN REMOVED PRIOR TO THE COMMENCEMENT OF WORK. ALL HAZARDOUS MATERIAL REMOVAL IS THE RESPONSIBILITY OF THE
- 13. DESIGNATED EGRESS WINDOWS IN SLEEPING ROOMS SHALL MEET THE FOLLOWING MINIMUM CLEAR OPENING REQUIREMENTS OF 22" WIDE, 24" HIGH & 5.7 SF CLEAR OPENING. ALL BEDROOMS SHALL
- 14. WINDOW SAFETY GLAZING SHALL BE LOCATED AS FOLLOWS, BUT NOT LIMITED TO: (IBC 2009 SEC. 2406)
- ALL WINDOWS WITHIN A SHOWER ENCLOSURE MUST BE TEMPERED.
- 15. BUILDING INSULATION SHALL BE PROVIDED AS INDICATED & NOTED IF NOT SHOWN IN ITS ENTIRETY THROUGHOUT THE DRAWING SET. INSULATE ALL BATHROOM, LAUNDRY, MECH. ROOM WALLS, AND ROO F DRAINS THRU BUILDING.
- 16. BEAM, JOIST OR OTHER STRUCTURAL MEMBER PENETRATIONS NOT SHOWN OR INDICATED ON DRAWINGS MUST BE CONSULTED WITH THE ARCHITECT &/OR ENGINEER PRIOR TO WORK.
- 17. ANY CHANGE DURING CONSTRUCITON OF USE, OCCUPANCY OR CONSTRUCTION TYPE MUST BE DISCUSSED WITH ARCHITECT PRIOR TO ANY WORK PERFORMED AND SUBSTANTIAL TIME ALLOWED FOR REQUIRED CODE RESEARCH AND DRAWING MODIFICATIONS OR ADDITIONS.

- 1. THE BUILDING SHALL BE CONSTRUCTED TO CONFORM WITH ALL CURRENT APPLICABLE CODES INCLUDING, BUT NOT LIMITED TO, THE LATEST EDITIONS OF IBC, IECC, NFPA 101, ANSI, UFAS, HUD/AG,

- CONTAIN A MINIMUM OF (1) EGRESS OPENING.
- ALL WINDOWS WITHIN 60" HORIZ. & VERT. DIMENSION OF STAIRS MUST BE TEMPERED.
- ALL WINDOWS WITHIN 24" OF A DOOR SWING MUST BE TEMPERED.

PROJECT NOTES

1. SCOPE OF WORK:

OWNER

MARK SMITH &

STEPHANIE DUNN

41 CUMBERLAND AVE

PORTLAND, MAINE 04101

EXISTING 4 STORY BUILDING WITH 3 RESIDENTIAL UNITS. THE PROPOSAL INCLUDES A 4TH FLOOR DORMER ROOF EXPANSION, 3RD AND 4TH FLOOR INTERIOR RENOVATIONS AND THE ADDITION OF A 4TH RESIDENTIAL LIVING UNIT. THE PROPOSAL ALSO INCLUDES THE INSTALLATION OF A FIRE SUPPRESSION SYSTEM PER NFPA. NO INCREASE IN STORIES & NO CHANGE OF USE IS PROPOSED.

CONSTRUCT A FREE STANDING LIVING UNIT PER PROPOSED DRAWINGS.

EOUAL

EACH WAY

EXTERIOR

2. THE PROJECT IS BEING SUBMITTED FOR A LEVEL I MINOR RESIDENTIAL DEVELOPMENT REVIEW & LEVEL I MINOR SITE PLAN DEVELOPMENT REVIEW

3. THE GENERAL CONTRACTOR SHALL BE RESPONSIBLE FOR SITE, EXTERIOR AND INTERIOR WORK.

WORK SHALL ALSO INCLUDE: A. NFPA 13 SPRINKLER SYSTEMS PER THE FLOOR PLANS.


B. MECHANICAL SYSTEMS (HVAC) C. ELECTRICAL SYSTEMS

MECHANICAL/ ELECTRICAL INSTALLATIONS ARE TO BE PERFORMED ON A DESIGN-BUILD BASIS.

ALL SYSTEMS SHALL BE APPROVED BY THE OWNER PROR TO WORK


4. THE FIRE ALARM SYSTEM SHALL BE INSTALLED ACCORDINGLY TO MEET NFPA 72 AND CITY OF PORTLAND FIRE DEPARTMENT REQUIREMENTS. COORDINATE REQUIREMENTS WITH PORTLAND FIRE CHIEF.


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mark@muellerarchitects.coi

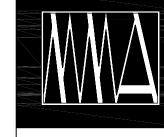




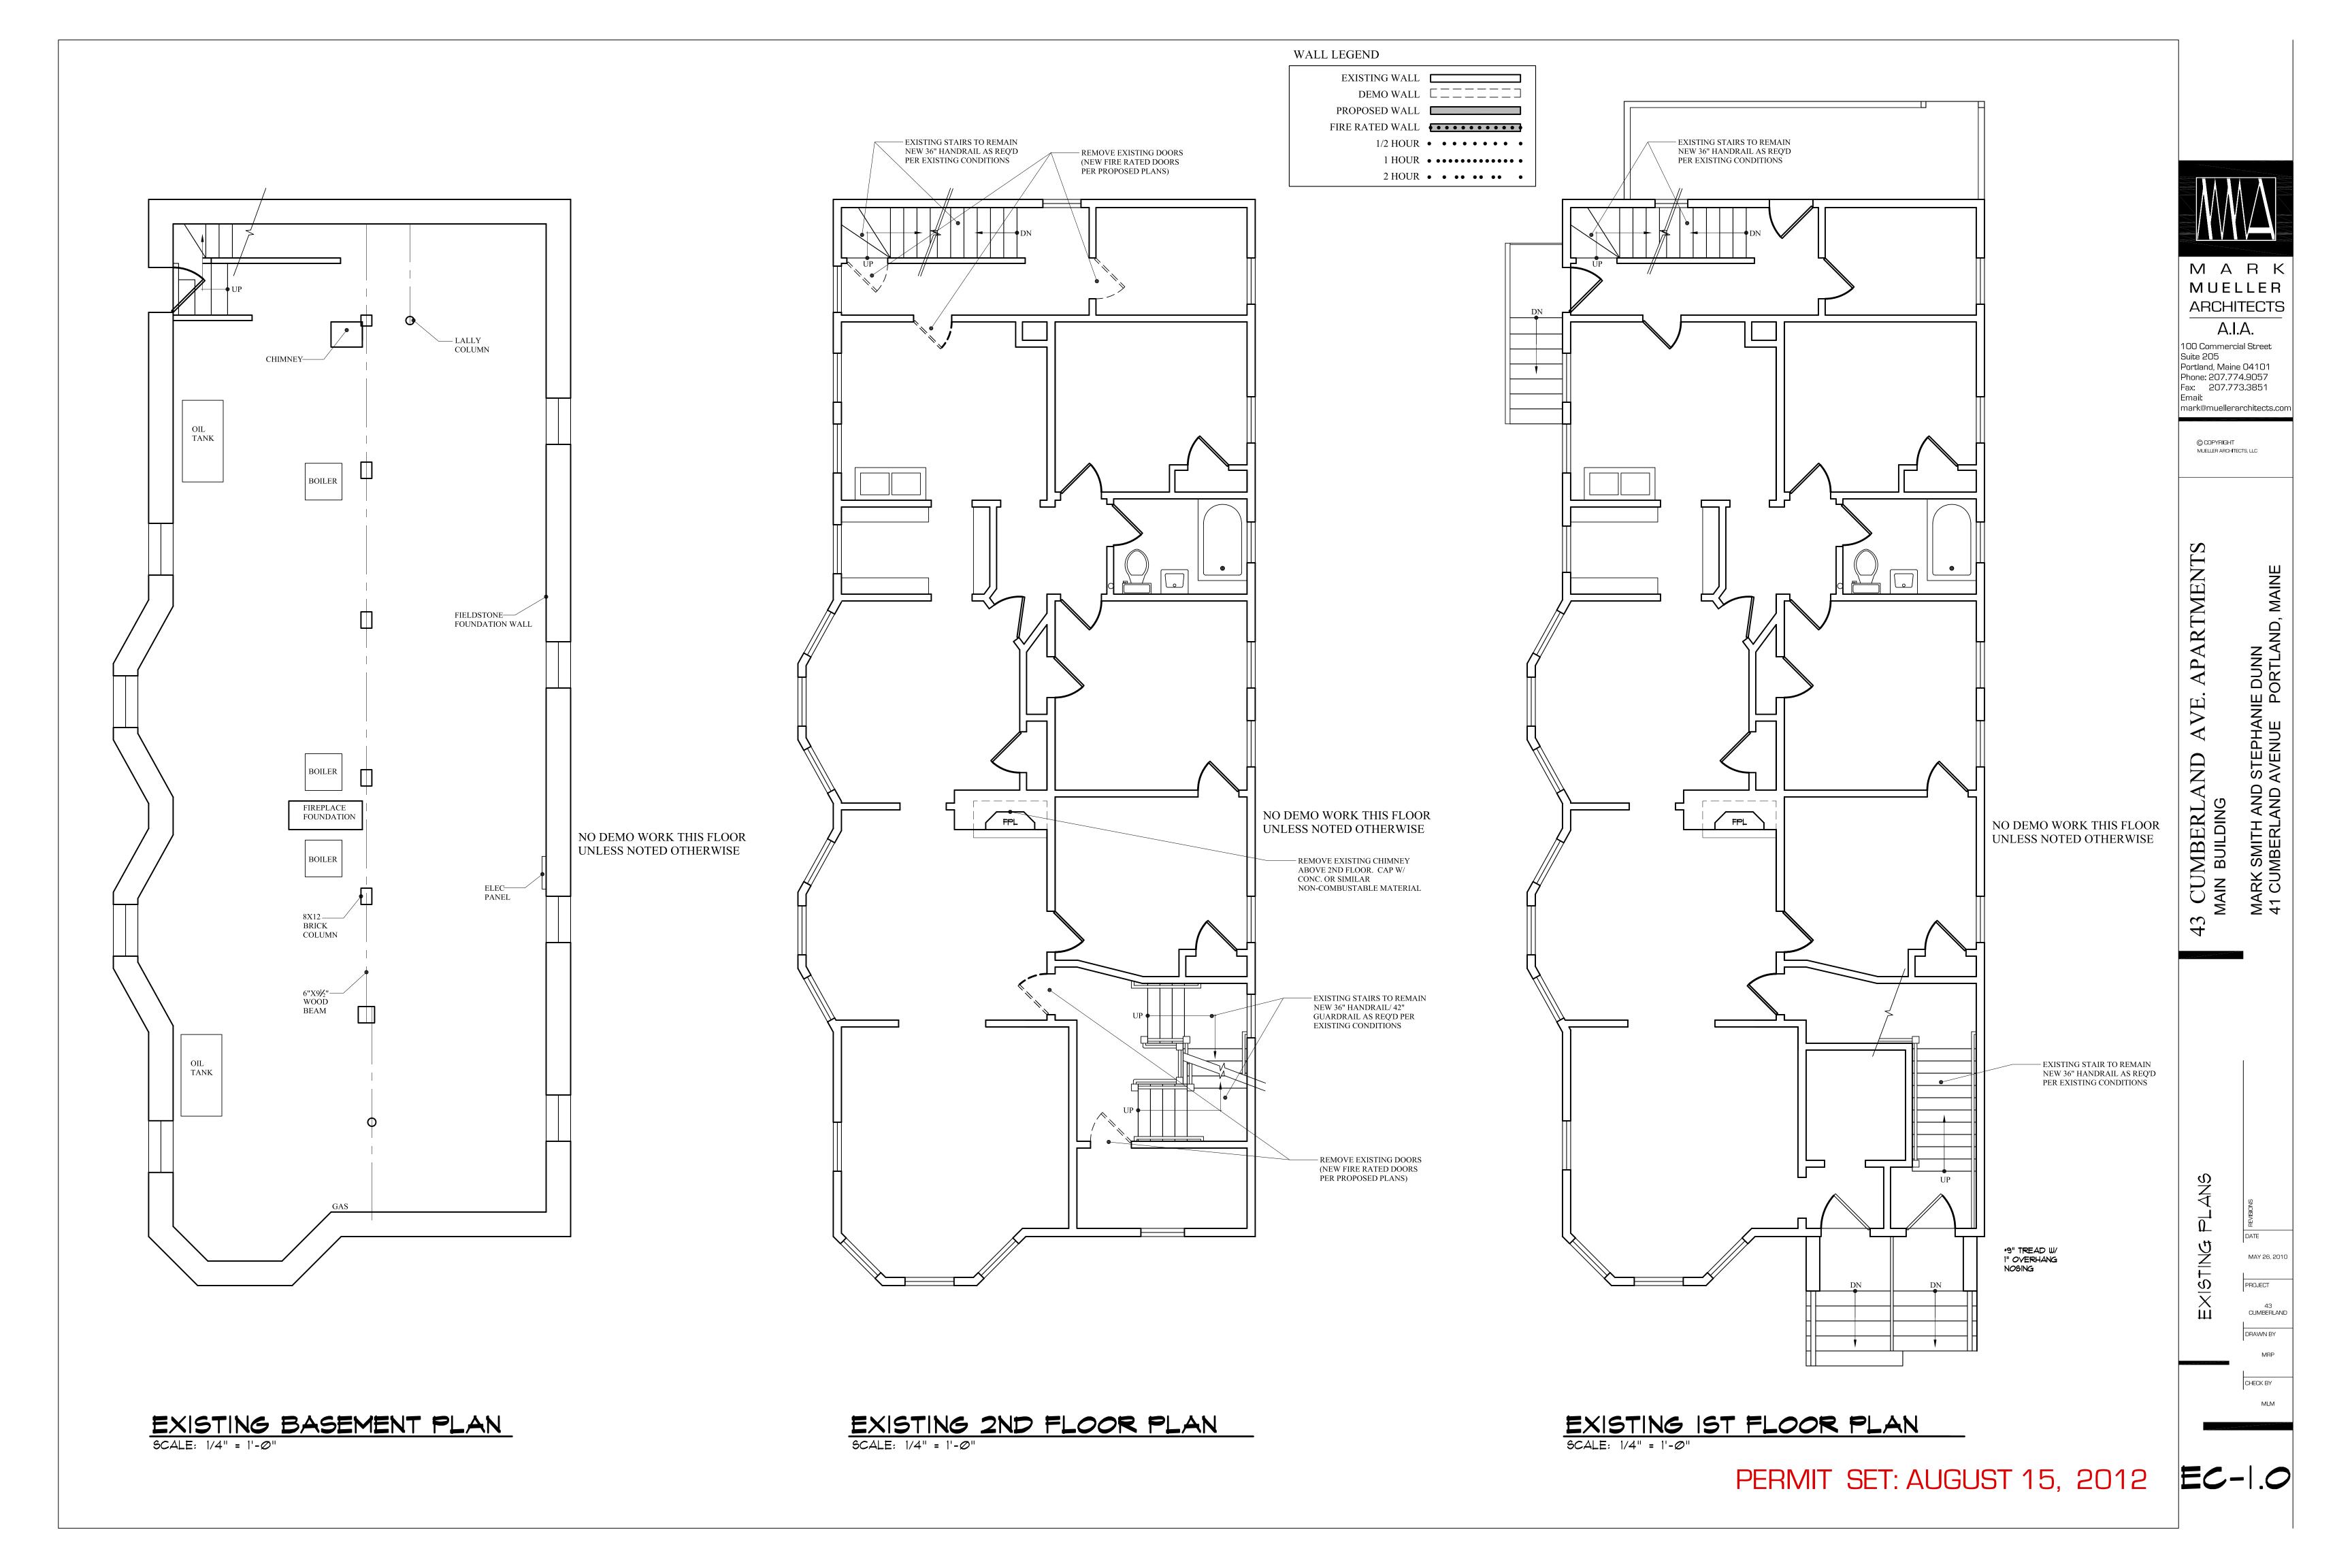

EXISTING SRD FLOOR PLAN

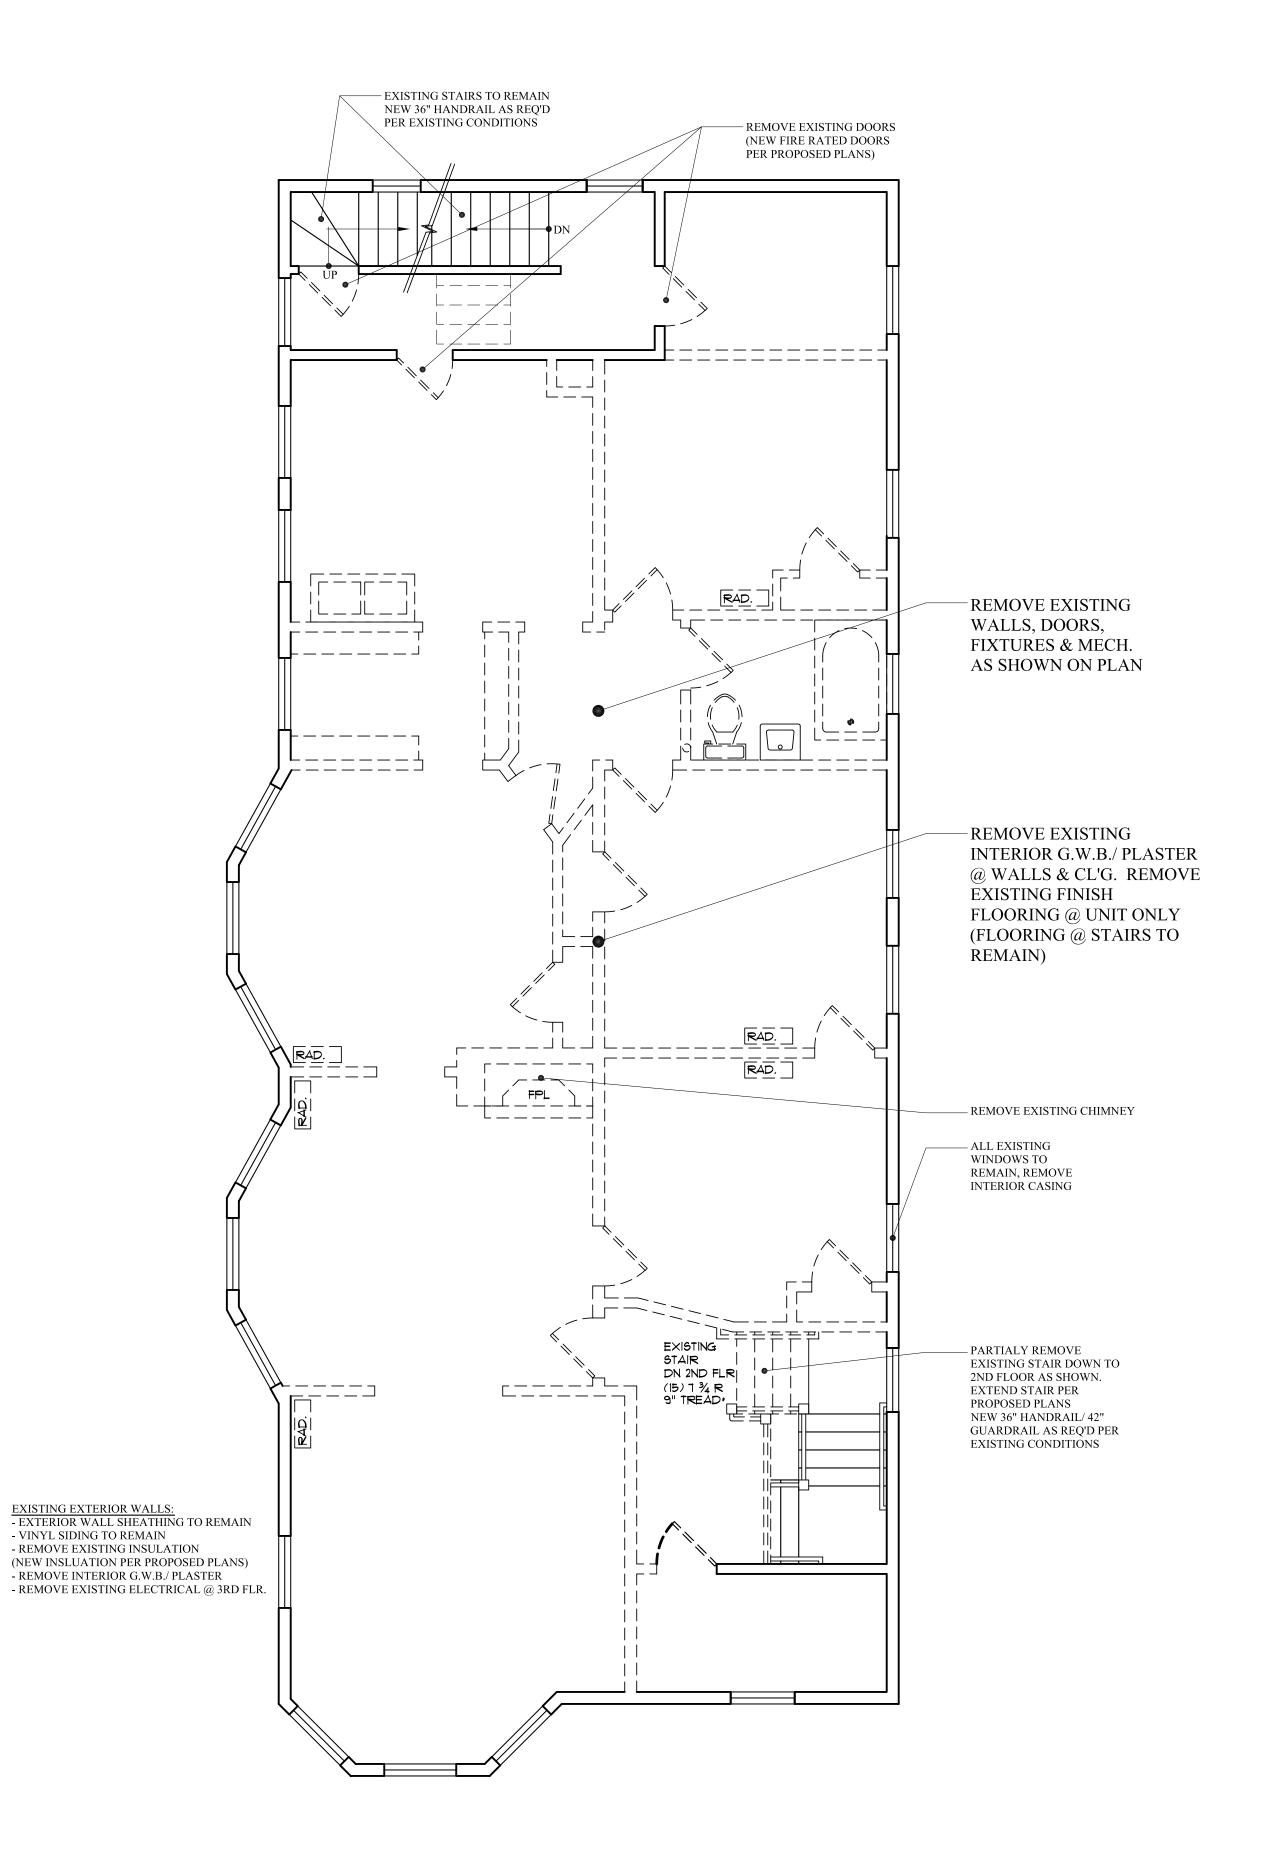SCALE: 1/4" = 1'-0"

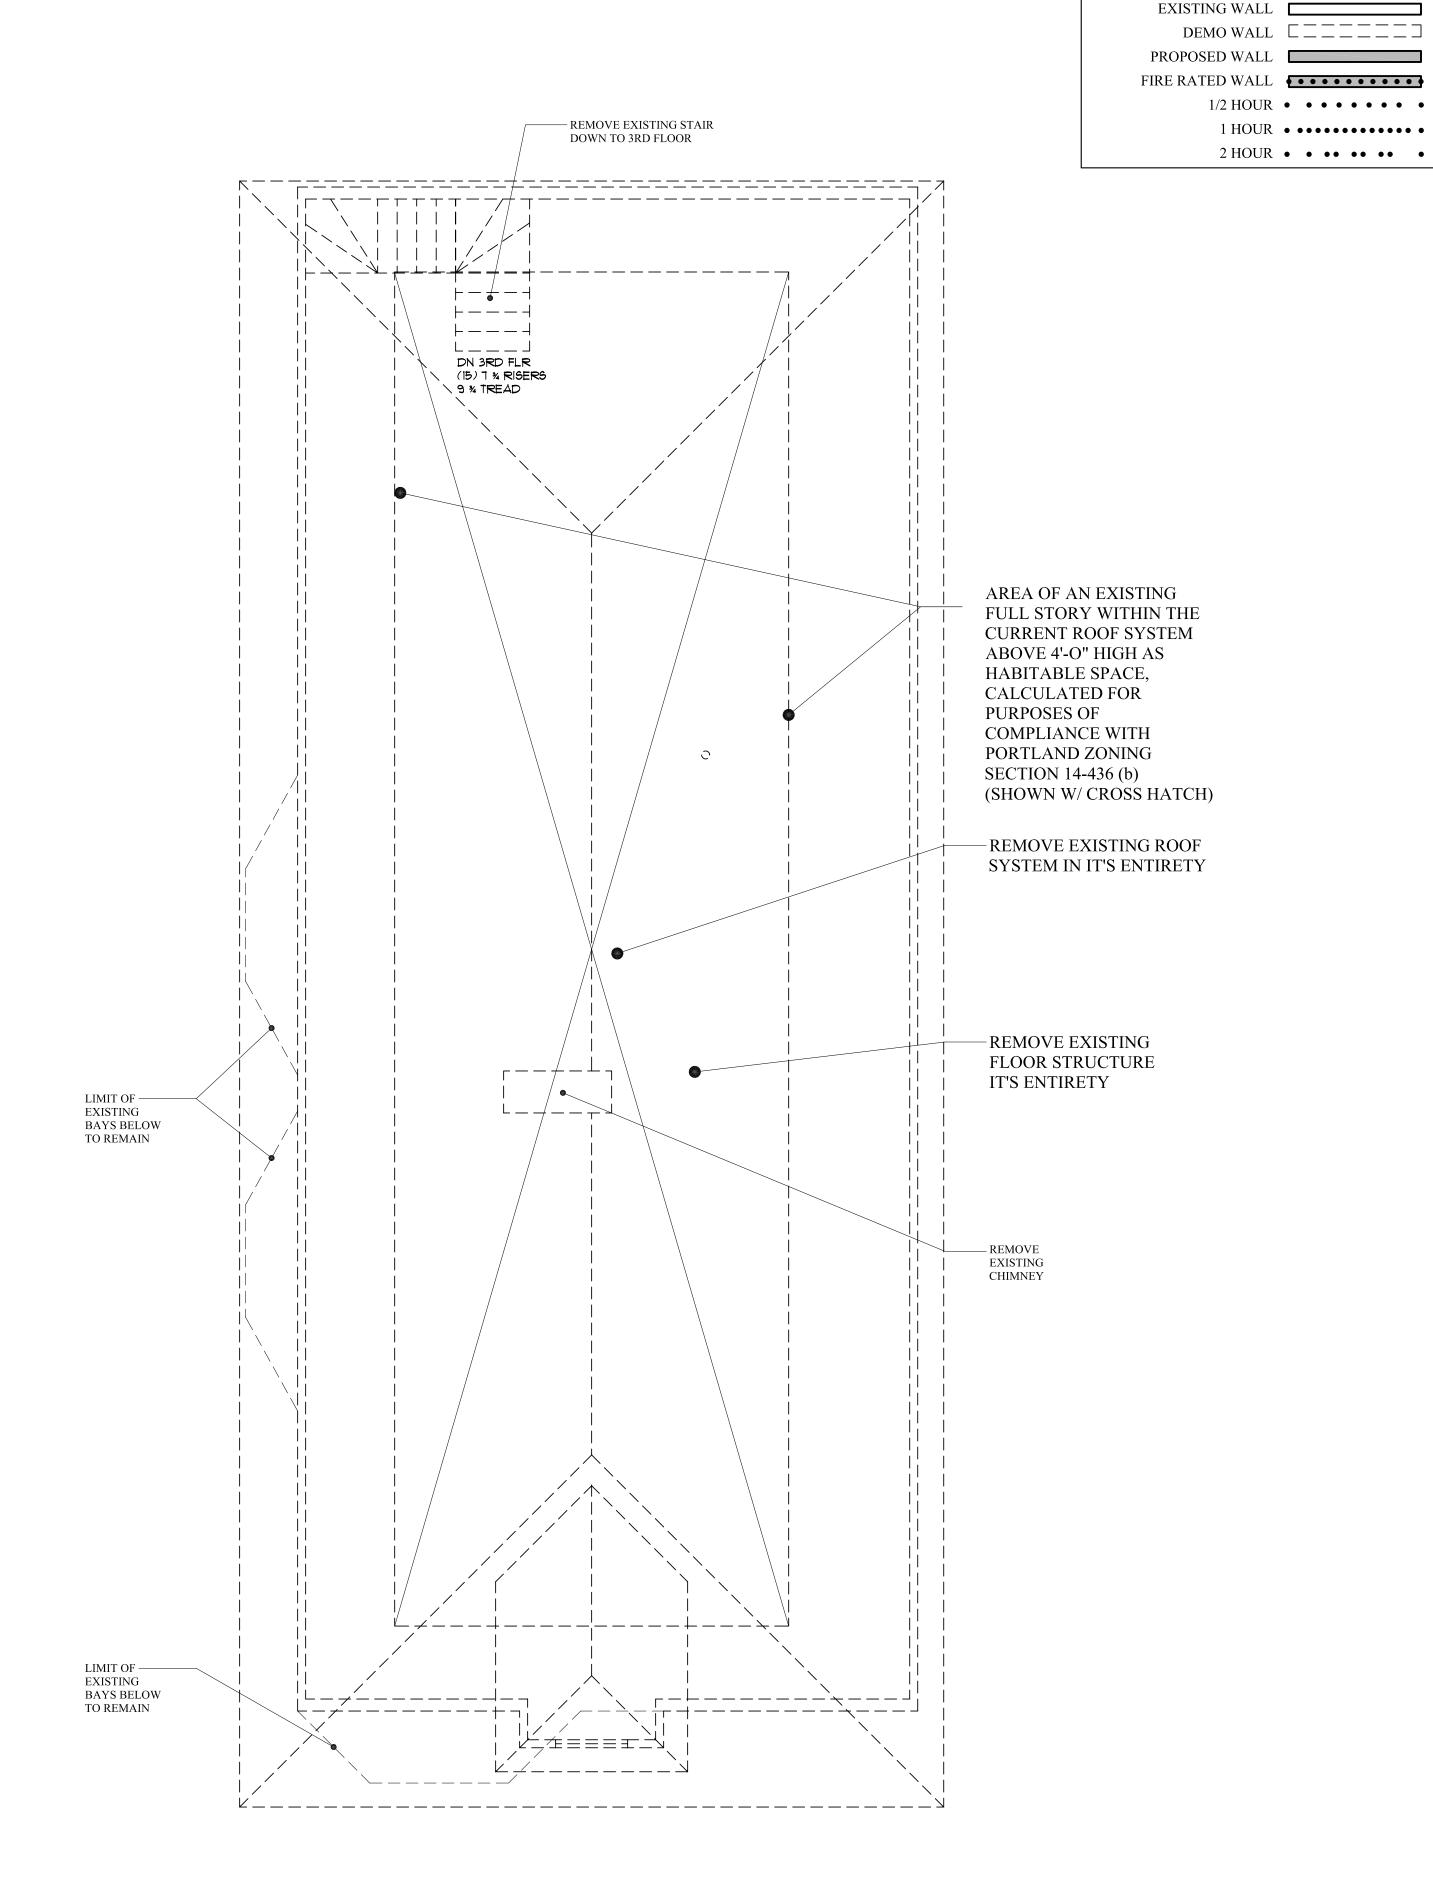

EXISTING 4TH FLOOR PLAN

SCALE: 1/4" = 1'-0"

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WALL LEGEND

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•

LAND AVE. APARTMENTS

JG

AND STEPHANIE DI INN

MAIN BUILDING
MARK SMITH AND STEPHANIE

DATE

MAY

PROJECT

P

PROJECT

43
CUMBERLAND

DRAWN BY

MRP

MI

EC-1.1



EXISTING FRONT ELEVATION


SCALE: 1/8" = 1'-0"

EXISTING RIGHT ELEVATION

EXISTING REAR ELEVATION

SCALE: 1/8" = 1'-0"



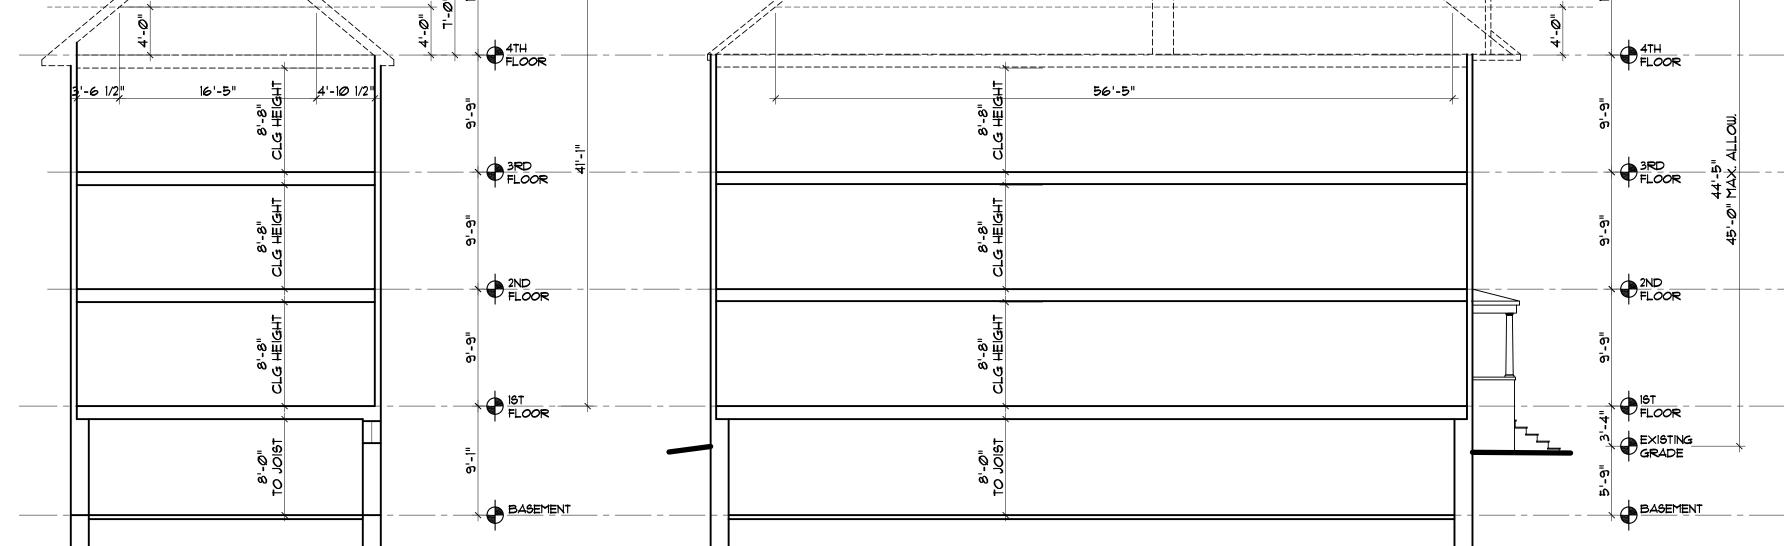

EXISTING LEFT ELEVATION

SCALE: 1/8" = 1'-0"

EXISTING BUILDING SECTION A


SCALE: 1/8" = 1'-0"

ABOVE 4'-O" HIGH AS HABITABLE SPACE,

COMPLIANCE WITH PORTLAND ZONING

EXISTING BUILDING SECTION B

SCALE: 1/8" = 1'-0"

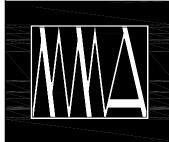

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3 CUMBER MAIN BUILDIN

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AREA: 1,704 SF

AREA: 1,704 SF

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AVE. APARTMENTS

IARK SMITH AND STEPHANIE DI

MAIN BUILDING
MARK SMITH AND

SNOSIONAL DATE

MAY 26

PROJECT


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MRP

CHECK BY

A-1.0

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WALL LEGEND

EXISTING WALL
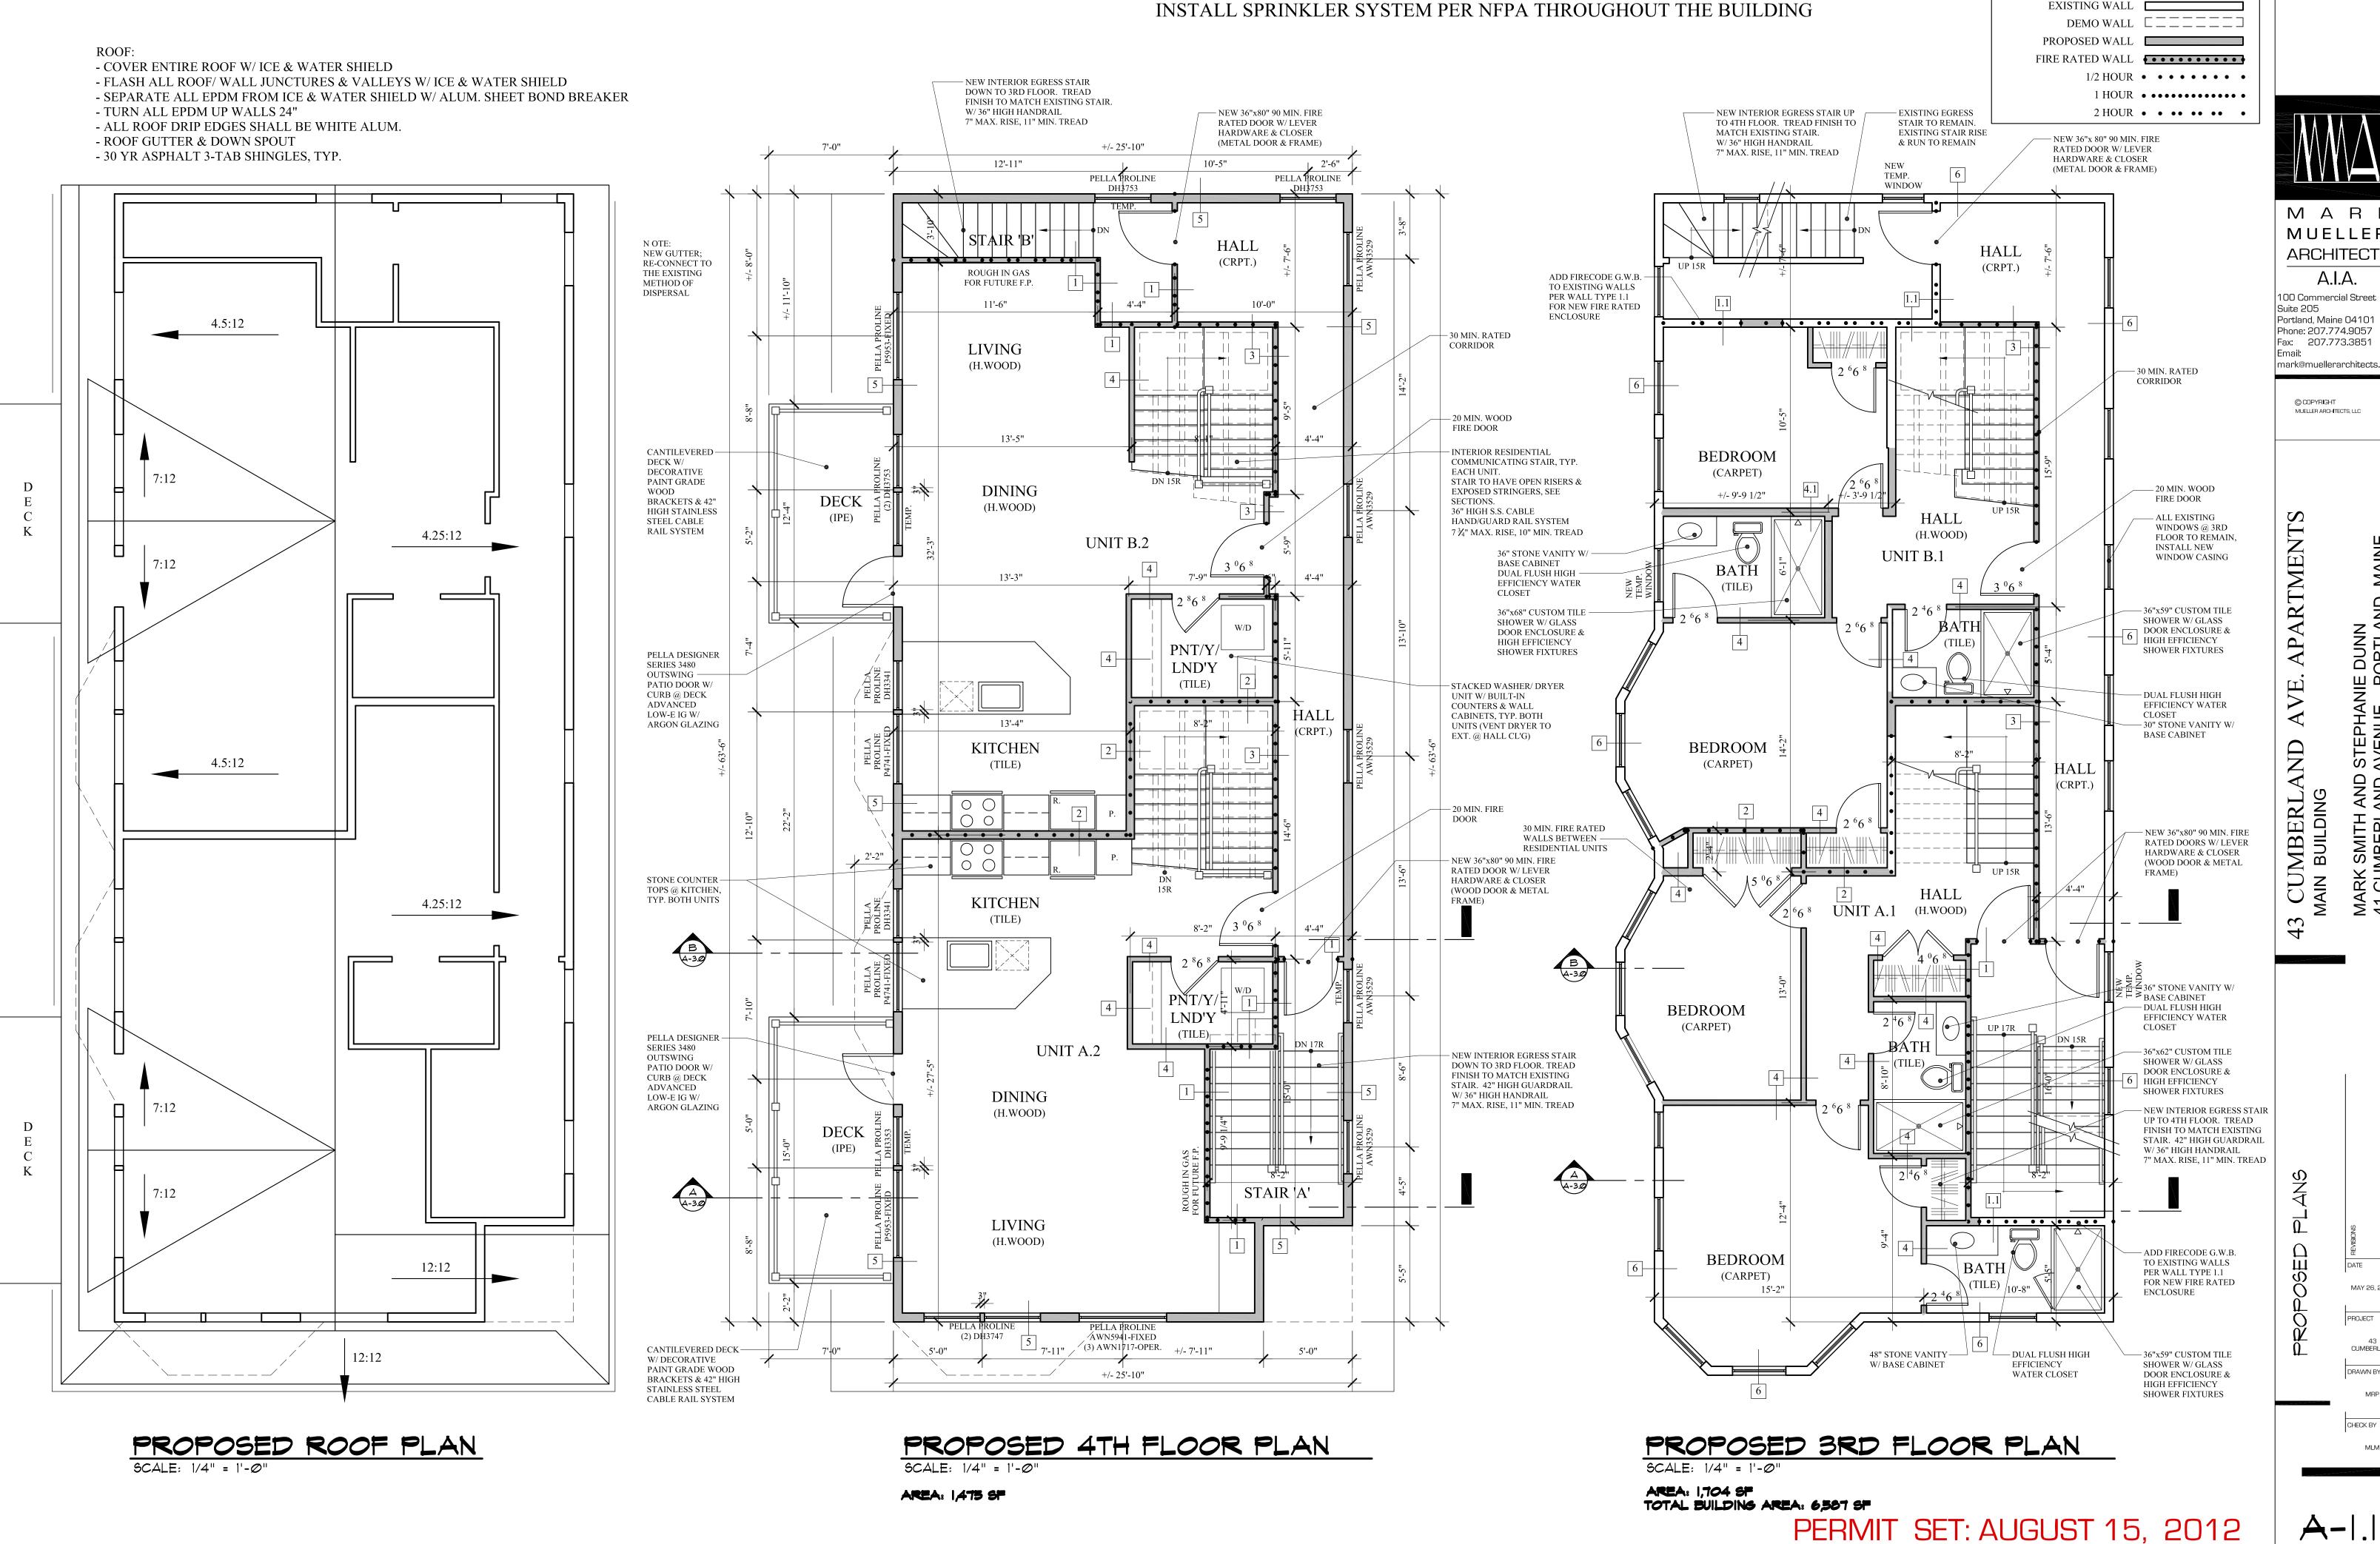
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MAY 26, 2010

CUMBERLAND DRAWN BY CHECK BY

A-I.I



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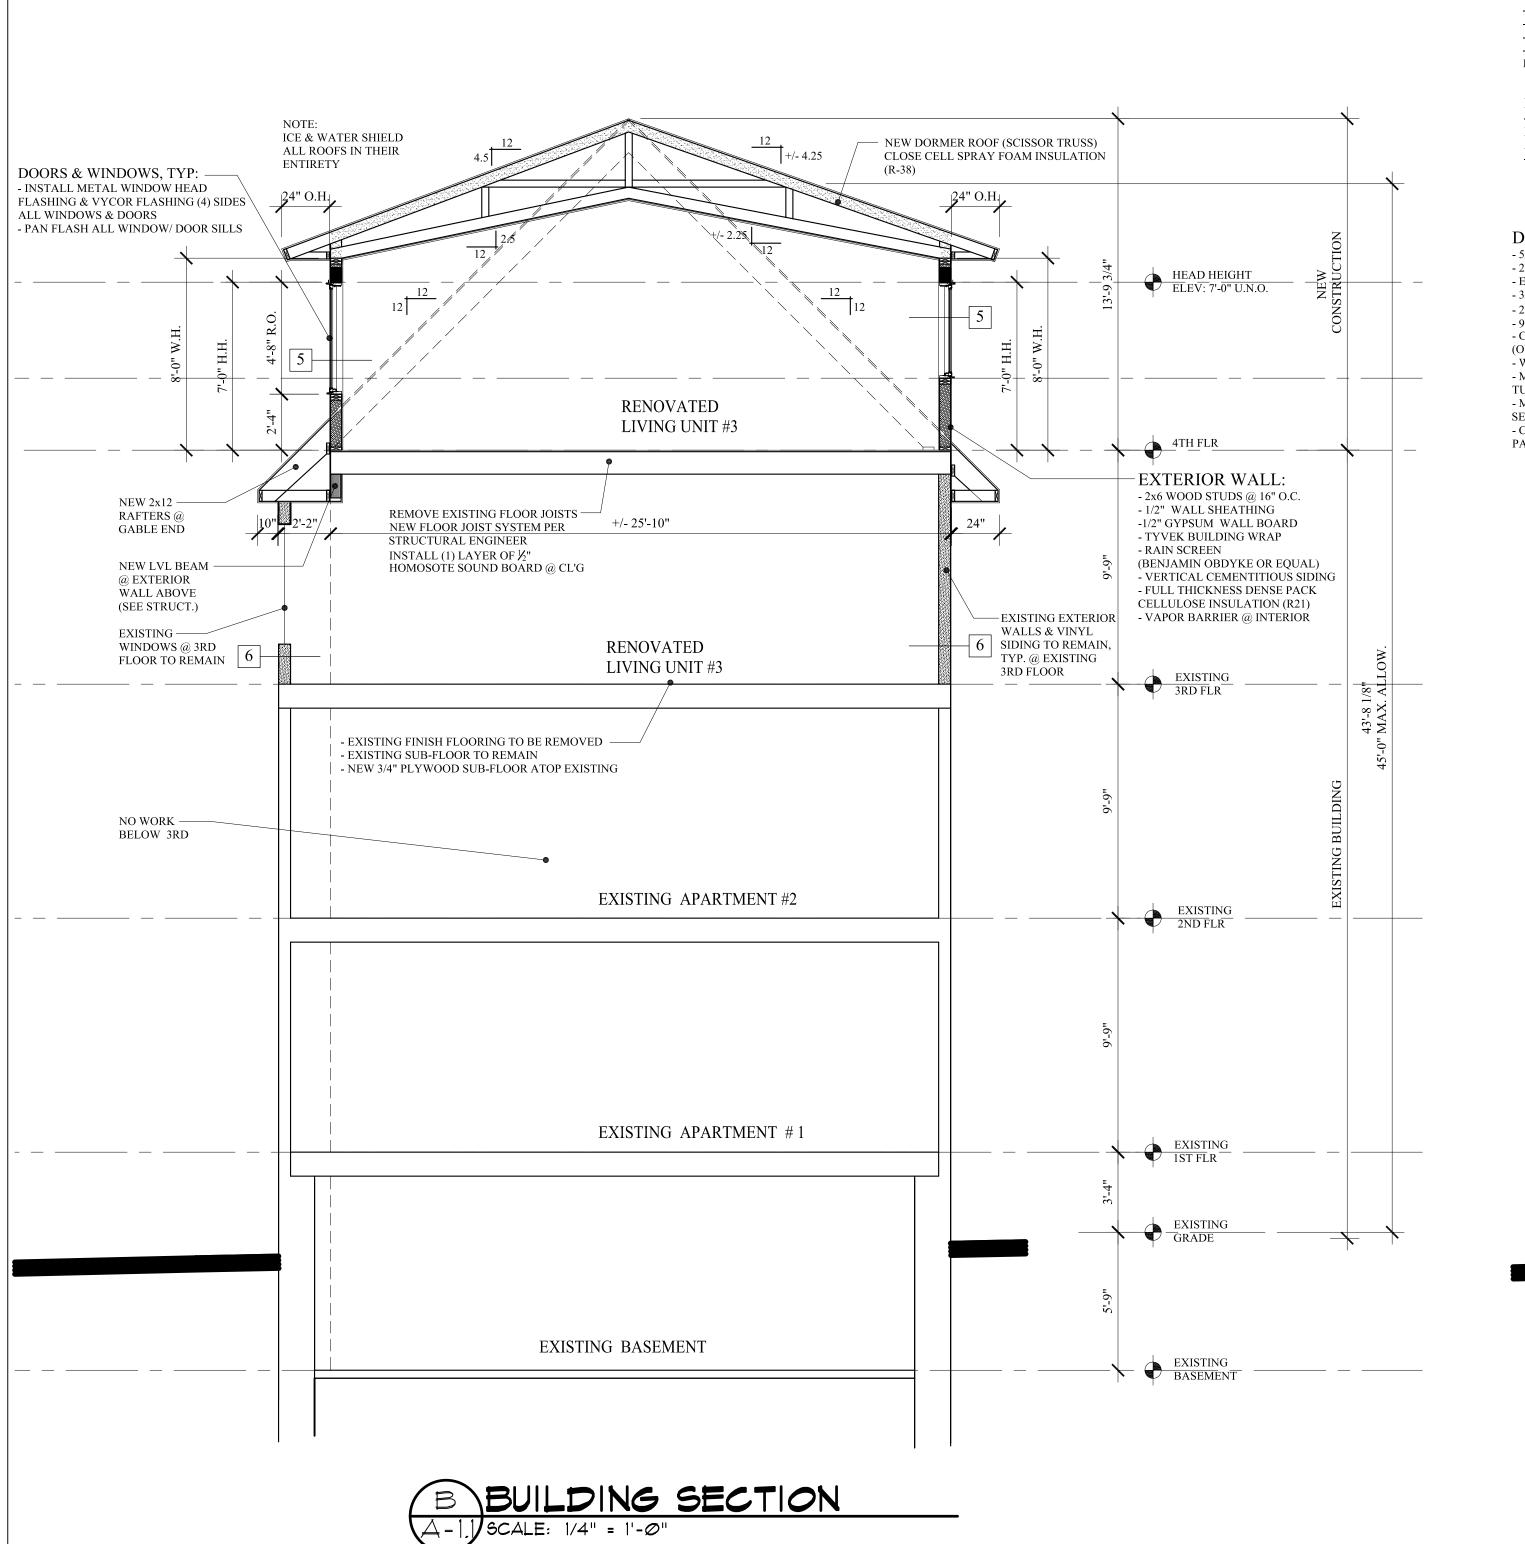
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ELEVATIONS OSED


A-2.



INSULATION: - SLOPED ROOFS: R38 - WALLS: DRY DENSE PACK CELLULOSE = R21 - FLAT ROOFS (OVER HEATED SPACE): CLOSED CELL SPRAY FOAM = R49 NEW DORMER ROOF - FOUNDATION WALLS & SLAB: 3" RIGID = R15 (AS NOTED) (SCISSOR TRUSS) - FLOORS: FULL THICKNESS SOUND ATTENUATION INSULATION (AS NOTED) CLOSE CELL SPRAY -ORIGINATION - BATHS & LAUNDRY (FLOORS & WALLS): FULL THICKNESS F'GLASS FOAM INSULATION (R-38) OF THE MAIN ROOF - SEAL ALL DISSIMILAR MATERIALS WITH NON-HARDING THERMAL SEALANT PER 2009 IECC REQUIREMENTS 12'-5" 13'-5" DOORS & WINDOWS, TYP: -ICE & WATER SHIELD - INSTALL METAL WINDOW HEAD ALL ROOFS IN THEIR FLASHING & VYCOR FLASHING (4) SIDES ENTIRETY -12" MIN. OVER ALL WINDOWS & DOORS WALL HEIGHT - PAN FLASH ALL WINDOW/ DOOR SILLS RAISED CURB DECK SYSTEM: TRUSS BR'G HEIGHT
WALL HEIGHT - 8'-0"
HEAD HEIGHT
ELEV: 7'-0" U.N.O. - 5/4x6 COMPOSITE DECKING OVER - 2x4 P.T. SLEEPERS W/ EPDM RUBBER SOLES - EPDM RUBBER ROOFING OVER -- 3/4" 'CDX' PLYWOOD (P.T.S.) OVER - 2x4 P.T. TAPERED SLEEPERS (TAPER @ ¼") OVER - 9½" P.T. LVL W/ 3/4" 'CDX' PLYWOOD (P.T.S.) - CLOSED CELL SPRAY FOAM INSULATION (OVER HEATED SPACE) - WOOD DECK FASCIA/ SOFFIT TRIM - MTL FLASHING @ DECK/ WALL JUNCTURE, TURN FLASHING UP WALL 24" - MTL PAN FLASHING @ DOOR SILLS (WELDED RENOVATED LIVING UNIT #3 - CREATE (2) REMOVABLE FINISH DECKING STAIR 'A' PANELS PER DECK FOR REPAIR ACCESS EXTERIOR WALL: - 2x6 WOOD STUDS @ 16" O.C. - 1/2" WALL SHEATHING REMOVE EXISTING FLOOR JOISTS — ON FLOOR -1/2" GYPSUM WALL BOARD (TYP.) NEW FLOOR JOIST SYSTEM PER - TYVEK BUILDING WRAP CANTILEVERED/ — STRUCTURAL ENGINEER - RAIN SCREEN BRACKETED DECK INSTALL (1) LAYER OF ½" (BENJAMIN OBDYKE OR EQUAL) OFF UPPER LEVEL HOMOSOTÉ SOUND BOARD @ CL'G - VERTICAL CEMENTITIOUS SIDING (SEE STRUCTURALS) - FULL THICKNESS DENSE PACK RENOVATED LOWER CELLULOSE INSULATION (R21) LEVEL - BEDROOMS - VAPOR BARRIER @ INTERIOR WINDOWS @ EXISTING VINYL 3RD FLOOR, SIDING TO REMAIN EXISTING TO RENOVATED REMAIN LIVING UNIT #3 NO WORK -BELOW 3RD - EXISTING FINISH FLOORING TO BE REMOVED _____ - EXISTING SUB-FLOOR TO REMAIN - NEW 3/4" PLYWOOD SUB-FLOOR ATOP EXISTING EXISTING APARTMENT #2 EXISTING APARTMENT #1 EXISTING BASEMENT

A BUILDING SECTION

A-1.1 SCALE: 1/4" = 1'-0"

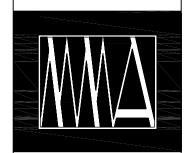

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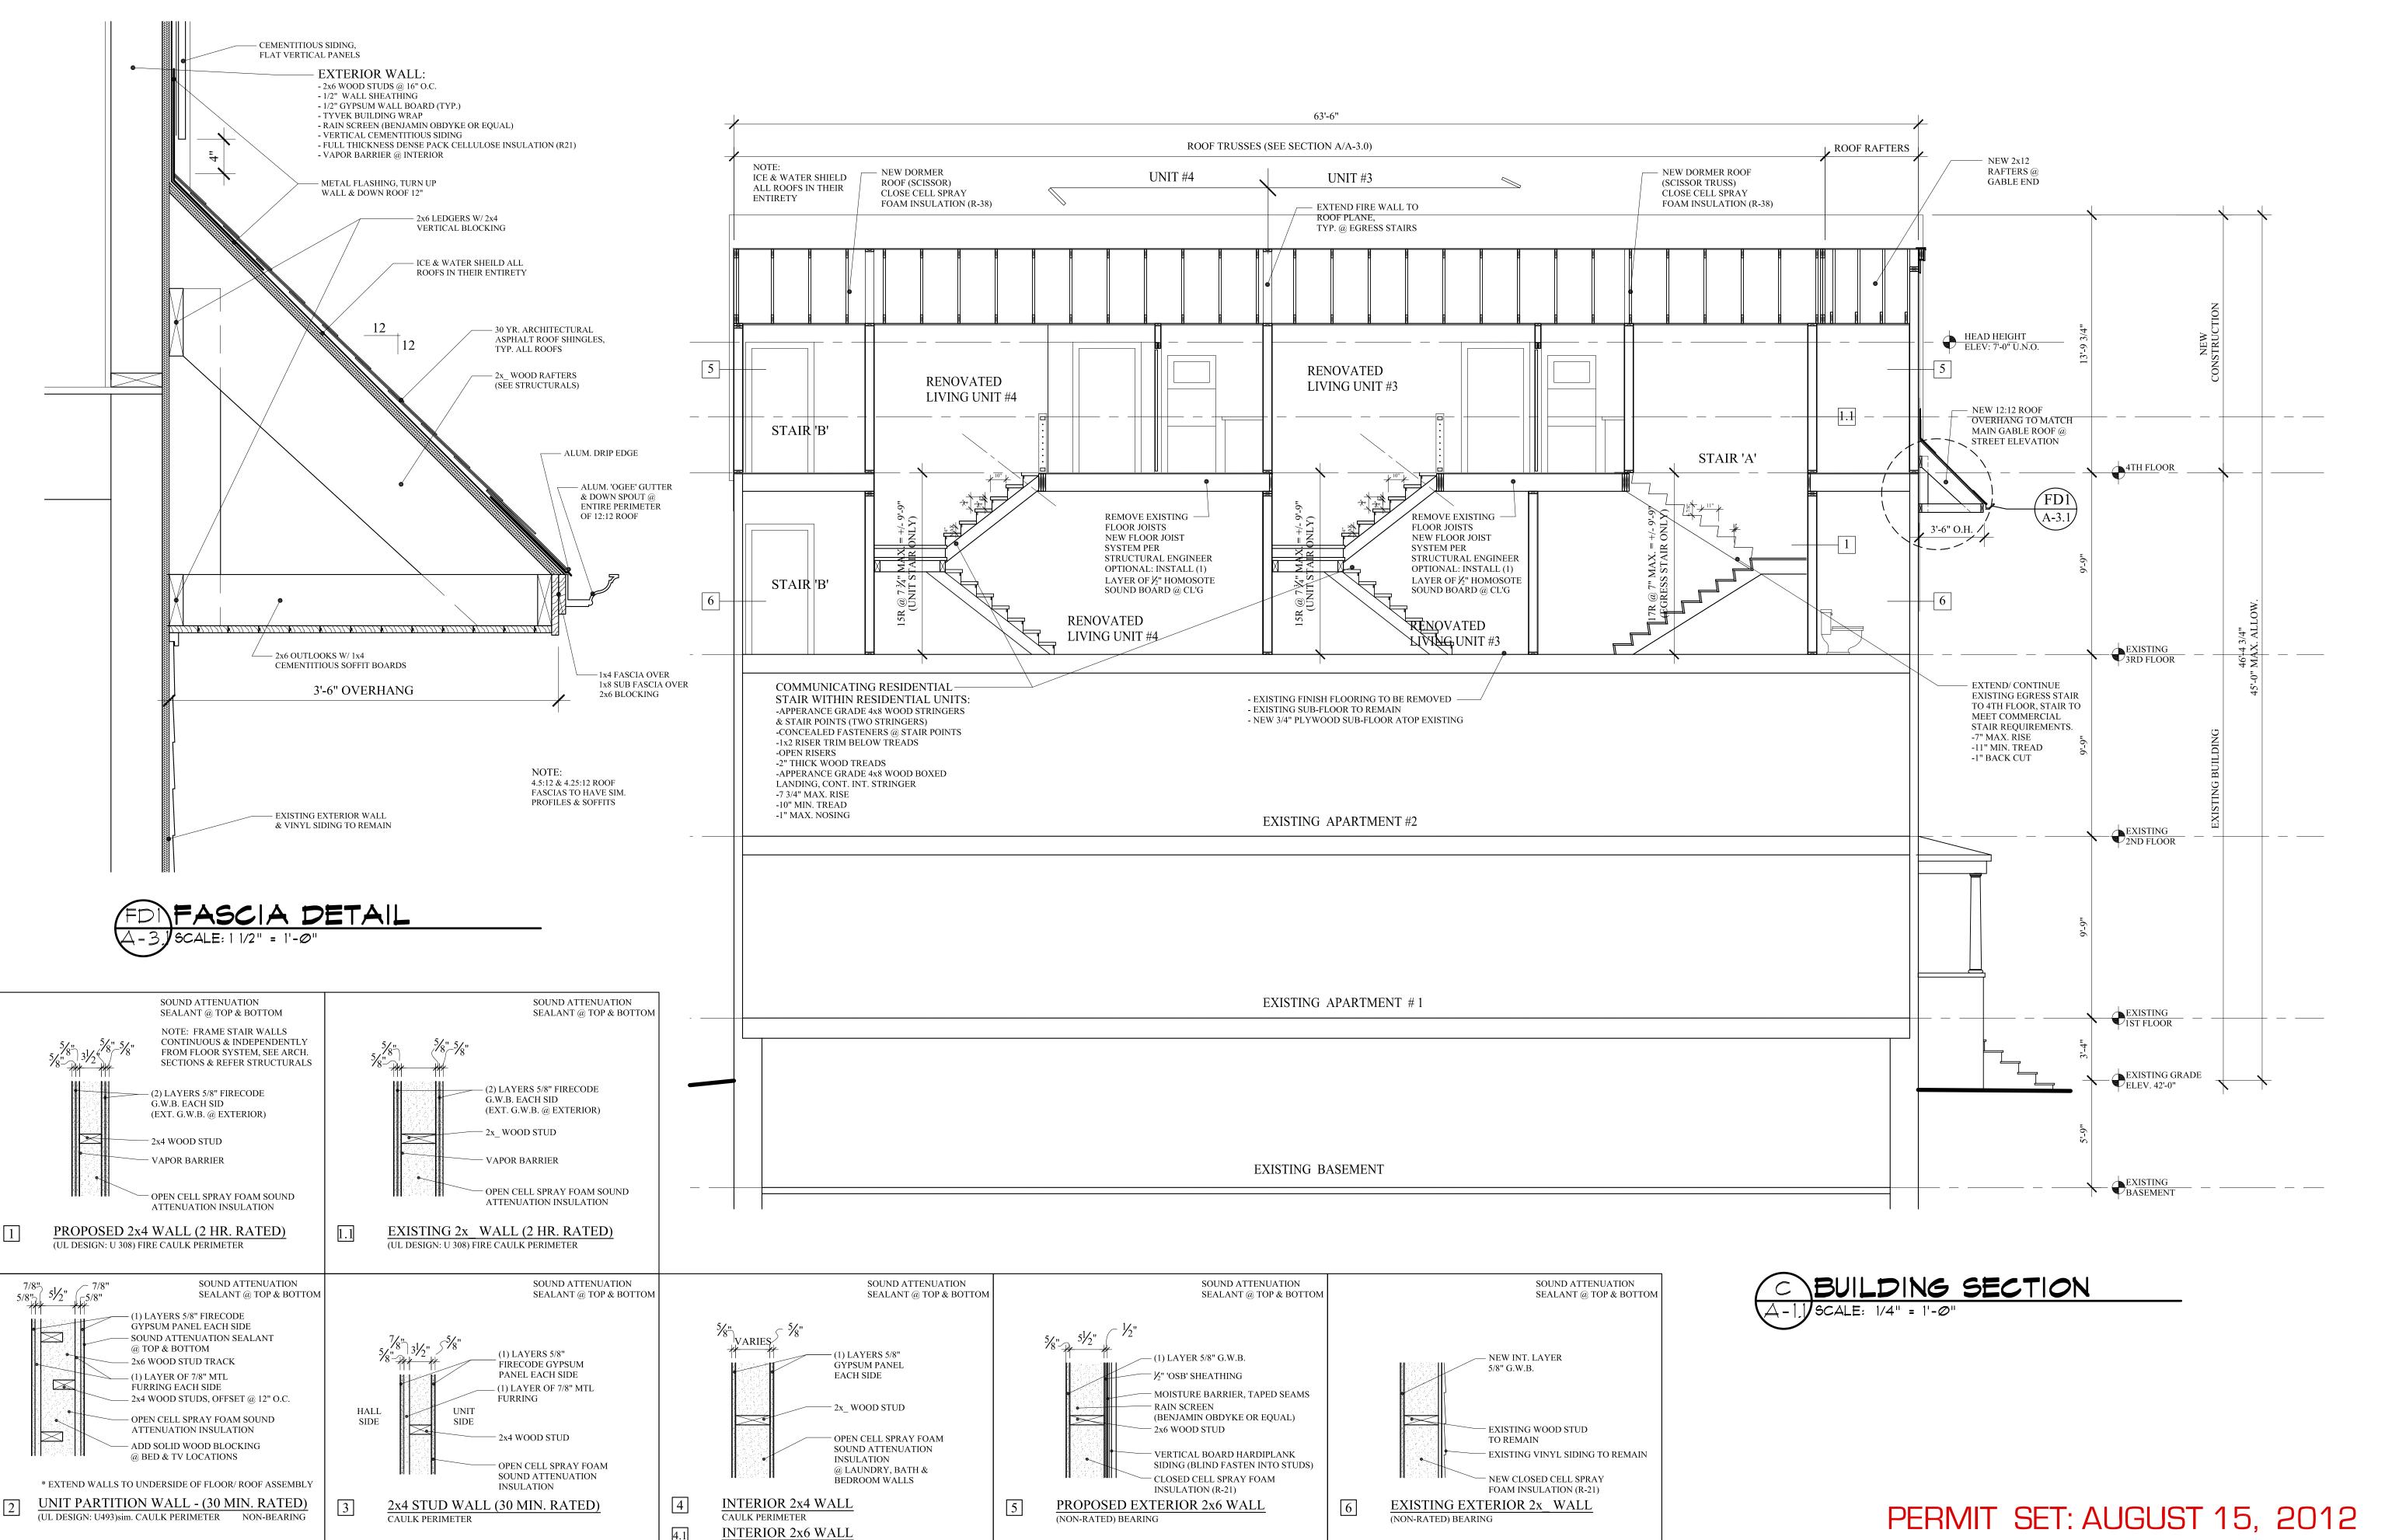
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APARTMEN

CUMBERLAND

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* INSTALL ALL MATERIALS PER MANUFACTURE REQUIREMENTS

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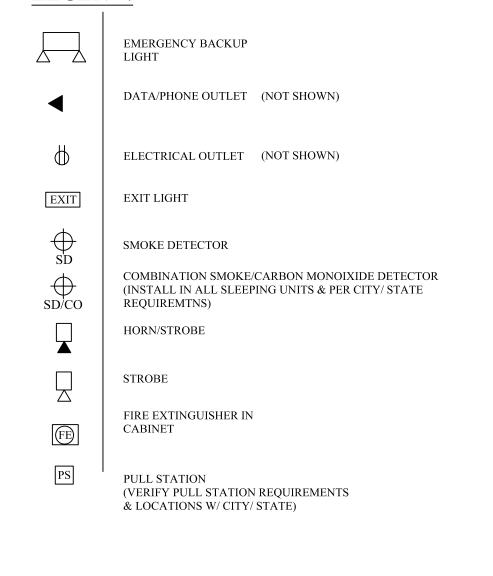
PARTMENTS

CUMBER MAIN BUILDIN


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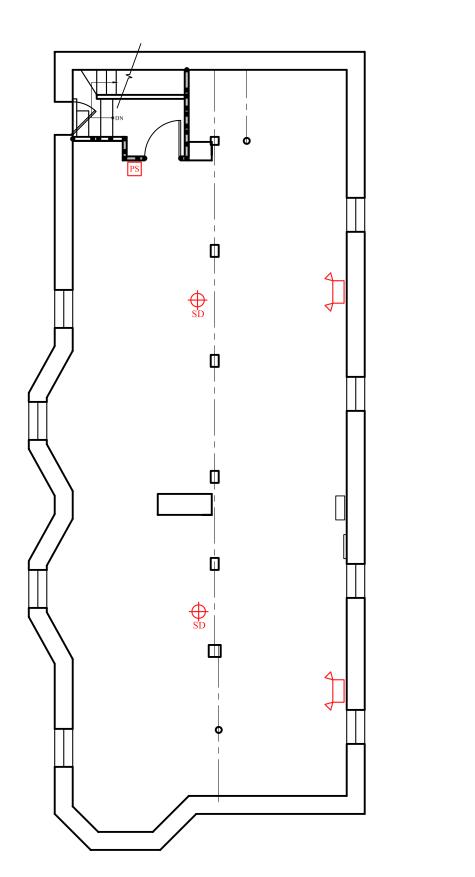
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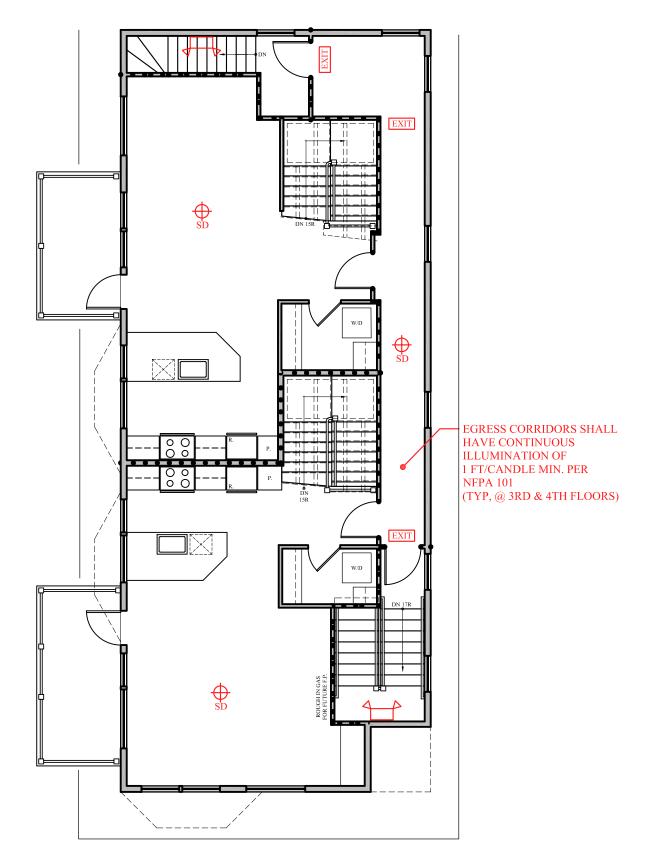
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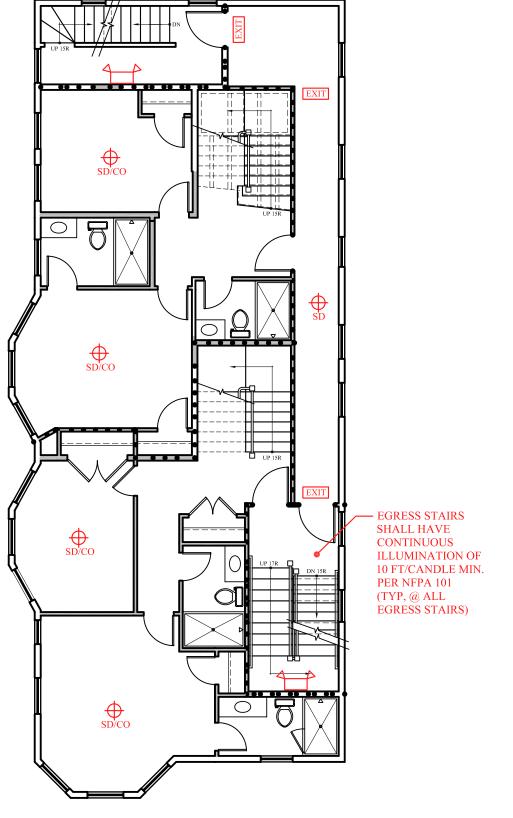



- EGRESS STAIRS SHALL HAVE CONTINUOUS ILLUMINATION OF








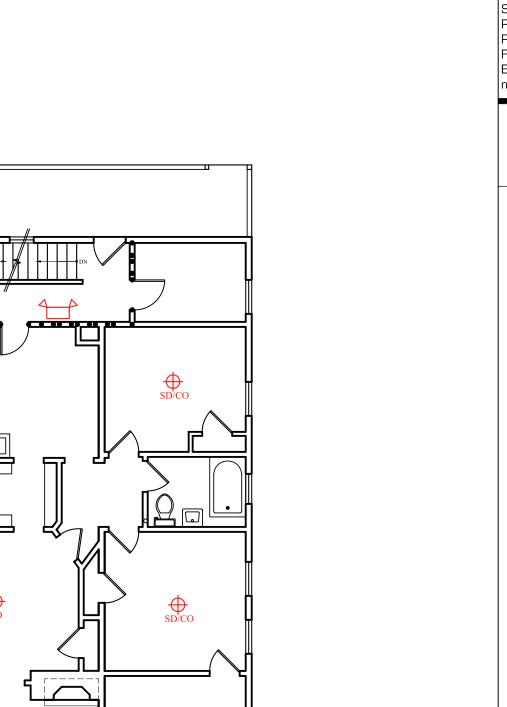

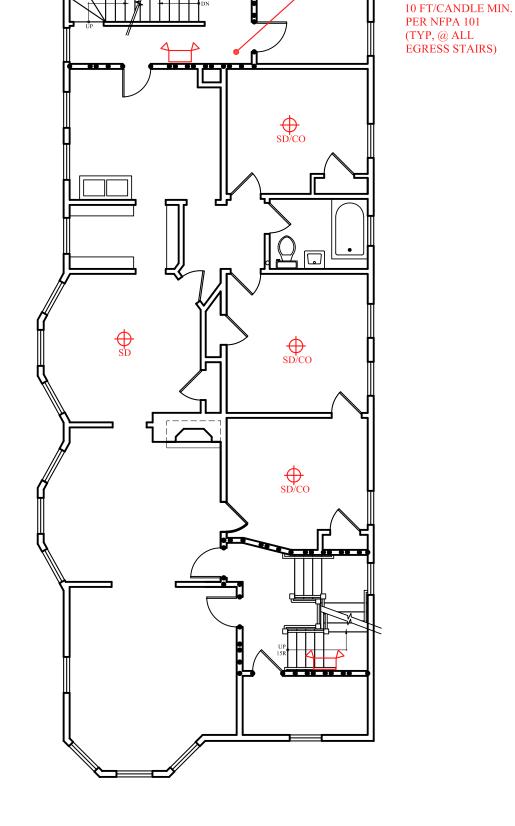

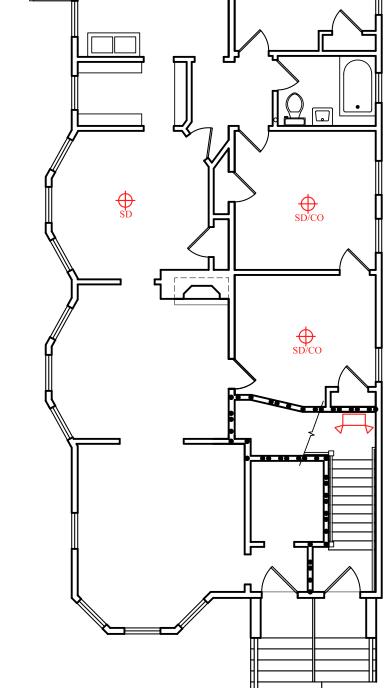

BASEMENT LIFE SAFETY

SCALE: 1/8" = 1'-0"

4TH FLR LIFE SAFETY

SCALE: 1/8" = 1'-0"

SRD FLR LIFE SAFETY

2ND FLR LIFE SAFETY

SCALE: 1/8" = 1'-0"

SCALE: 1/8" = 1'-0"

INSTALL SPRINKLER SYSTEM PER NFPA THROUGHOUT THE BUILDING

LIFE SAFETY NOTES:

-LIFE SAFETY SYSTEM SHALL BE
DESIGNED AND INSTALLED PER NFPA 72 &
PER CITY & STATE REQUIREMENTS AND
BY A CITY/ STATE APPROVED
CONTRACTOR WITH A SEPARATE PERMIT.

-PULL STATIONS TO PROVIDE ACTIVATION OF SMOKE DETECTOR SIGNALING

PERMIT SET: AUGUST 15, 2012

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APARTMENTS

MARK SMITH AND STEPHANIE DUNN 41 CUMBERLAND AVENUE PORTLAN

SAFETY PLANS

PROJECT

43
CUMBERLAN

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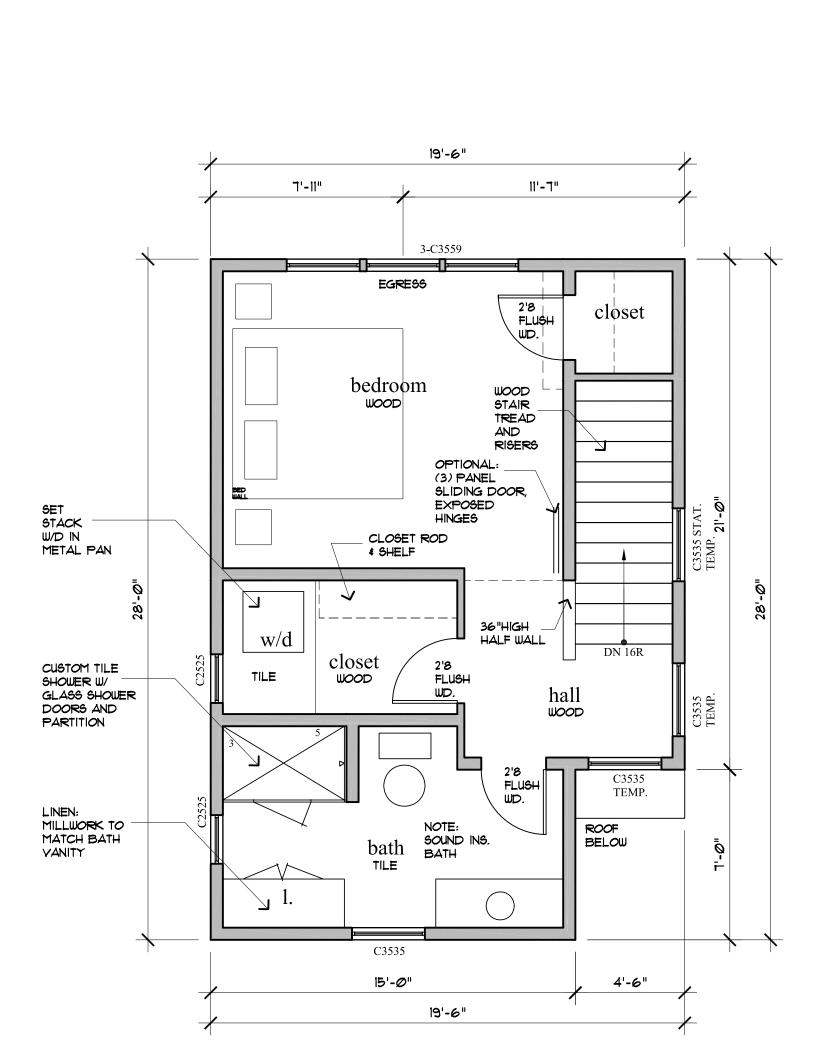
MRP


MLM


A-4.0

GENERAL NOTES

- 1. THE SPACE SHALL BE CONSTRUCTED TO CONFORM WITH ALL CURRENT APPLICABLE CODES INCLUDING, BUT NOT LIMITED TO, THE LATEST EDITIONS OF IRC 2009, IECC, NFPA 101.
- 2. CONTRACTOR SHALL WORK FROM GIVEN DIMENSIONS AND LARGE SCALE DETAILS ONLY. DO NOT SCALE DRAWINGS. G.C. SHALL REPORT ANY & ALL DISCREPANCIES TO THE ARCHITECT PRIOR TO WORK.
- 3. INSTALL BLOCKING FOR SURFACE APPLIED FIXTURES, TRIM, CABINETS, COUNTER TOPS WHEN MOUNTED ON STUD WALLS, INCLUDING ALL FUTURE INSTALLATIONS.
- 5. INSTALL MOISTURE RESISTANT GYPSUM BOARD IN ALL HIGH HUMIDITY AREAS.
- 6. ALL CAULKING AROUND WINDOWS SHALL BE NON-HARDENING TYPE SEALANT.
- 7. ELECTRICAL: ALL NEW WORK SHALL MEET THE NEC AND NFPA 70.
- 8. BUILDING PERMIT SHALL BE SECURED BY THE GENERAL CONTRACTOR.
- 9. G.C. TO PROVIDE FINAL SPACE CLEANING PRIOR TO OCCUPANCY
- 10. G.C. TO VERIFY & CHECK PROPER FUNCTION OF ALL EQUIPMENT. INCLUDING BUT NOT LIMITED TO HVAC, ELECTRICAL/LIGHTING, & PLUMBING PRIOR TO TENANT OCCUPANCY
- 11. ALL WOOD IN CONTACT WITH CONCRETE SHALL BE PRESSURE PRESERVATIVE TREATED.
- 12. CONTRACTOR SHALL WORK FROM GIVEN DIMENSIONS AND LARGE SCALE DETAILS ONLY. DO NOT SCALE THE DRAWINGS.
- 13. INSTALL BLOCKING FOR SURFACE APPLIED FIXTURES, TRIM, CABINETS, COUNTER TOPS, AND GRAB BARS WHEN MOUNTED ON STUD WALLS, INCLUDING ALL FUTURE INSTALLATIONS. 14. INSTALL U.L. FIRE-STOPPING SEALANT/SYSTEM EQUAL TO THE FIRE RATED FLOOR, CEILING AND WALL ASSEMBLY.
- 15. FIRESTOP VERTICAL MECHANICAL CHASES @ FLOOR & CEILING PENETRATIONS. CAULK JOINTS. COORDINATE AND FLASH ALL ROOF/WALL PENETRATIONS WITH THE SUB-TRADES.
- 16. REPORT ANY AND ALL DISCREPANCIES TO THE ARCHITECT PRIOR TO PROCEEDING WITH WORK.
- 17. ALL WINDOWS IN SLEEPING ROOMS SHALL BE EGRESS WINDOWS MEETING THE FOLLOWING MINIMUM CLEAR OPENING REQUIREMENTS: 22" WIDE 24" HIGH 5.7 S.F.
- 18. ALL WINDOWS WITHIN 60" HORIZ. & VERT. DIMENSION OF STAIRS MUST BE TEMPERED.
- ALL WINDOWS WITHIN 24" OF A DOOR SWING MUST BE TEMPERED.
- ALL WINDOWS WITHIN A SHOWER ENCLOSURE MUST BE TEMPERED. 19. BUILDING INSULATION SHALL BE PROVIDED AS INDICATED & NOTED IF NOT SHOWN IN ITS ENTIRETY THROUGHOUT THE DRAWING SET. INSULATE ALL BATHROOM, LAUNDRY & MECH. ROOM WALLS & VENT PIPES.
- 20. BEAM, JOIST OR OTHER STRUCTURAL MEMBER PENETRATIONS NOT SHOWN OR INDICATED ON DRAWINGS MUST BE CONSULTED WITH THE ARCHITECT &/OR ENGINEER PRIOR TO WORK.
- 21. ANY CHANGE DURING CONSTRUCITON OF USE, OCCUPANCY OR CONSTRUCTION TYPE MUST BE DISCUSSED WITH ARCHITECT PRIOR TO ANY WORK PERFORMED AND SUBSTANTIAL TIME ALLOWED FOR REQUIRED CODE RESEARCH AND DRAWING MODIFICATIONS OR ADDITIONS.



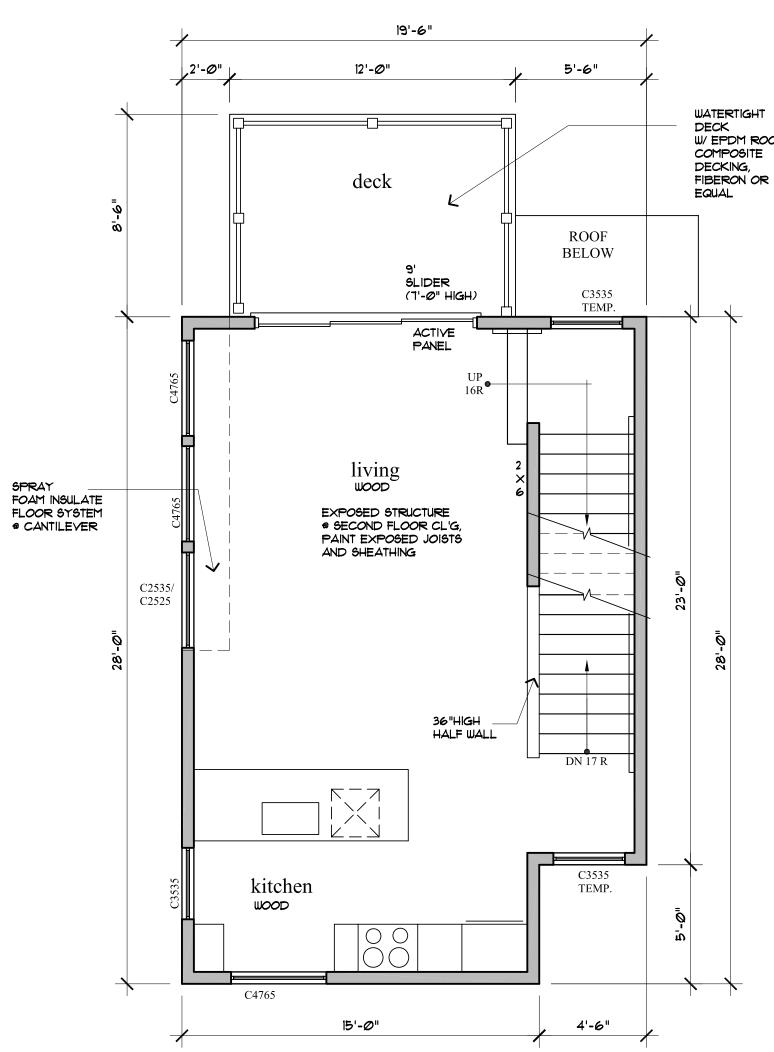

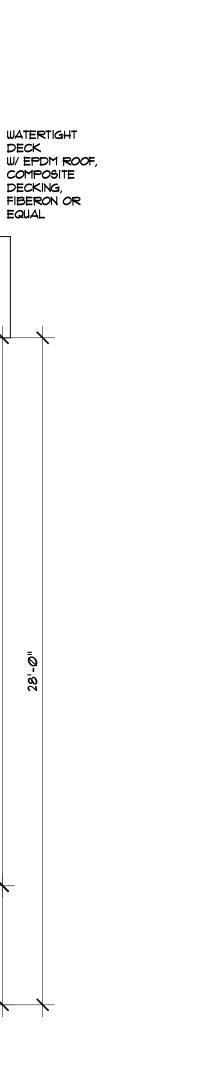

FIRST FLOOR PLAN


PLAN AREA: 523 SF

CODE DATA:

USE GROUP: R-2 CONSTRUCTION TYPE: 5B BUILDING AREA: 1,569 SF BUILDING HEIGHT: 3 STORIES

THE STUDIO BUILDING SHALL BE SPRINKLERED PER NFPA 101 AND THE CITY OF PORTLAND SPRINKLER ORDINANCE. PERMITS SHALL BE OBTAINED FROM THE STATE FIRE MARSHALS OFFICE BY THE SPRINKLEER CONTRACTOR.

THE WATER SERVICE FOR THE STUDIO BUILDING SHALL BE PIPED UNDERGROUND FROM THE MAIN BUILDING. VERIFY ACCESS WITH APPLICABLE ORDINACES PRIOR TO WORK.

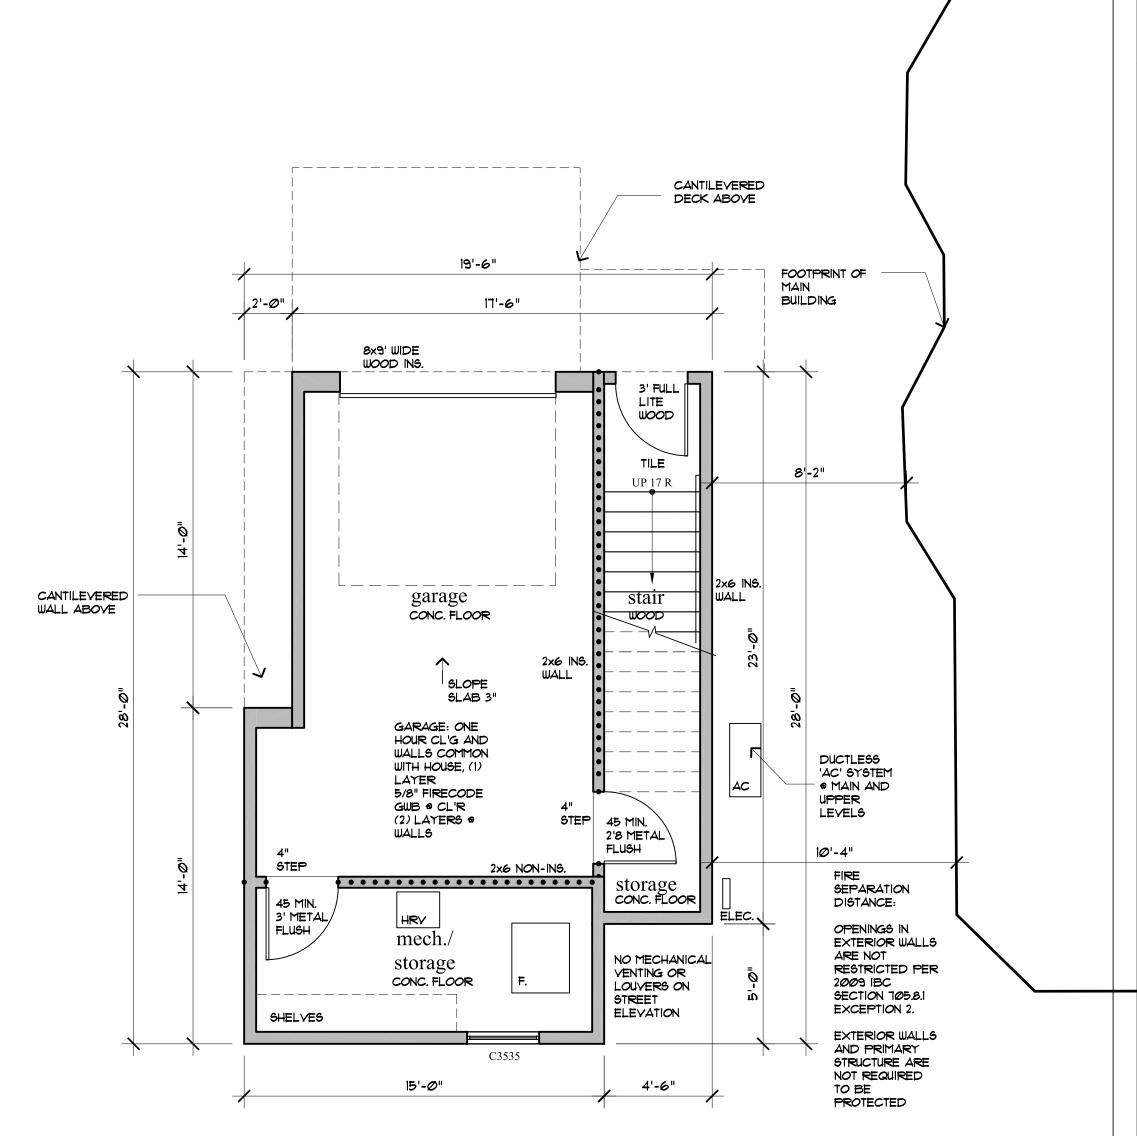

LOWER GARAGE LEVEL PLAN SCALE: 1/4" = 1'-0"

Plan area: 523 SF Building Total: 1,569 SF

PERMIT SET: AUGUST 15, 2012



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STUDIO BUILD MARK SMITH A

JULY 24, 2012

STUDIO DRAWN BY


MLM

STUDIO A-1.0


PLAN AREA: 523 SF

SCALE: 1/4" = 1'-0"

SECOND FLOOR PLAN

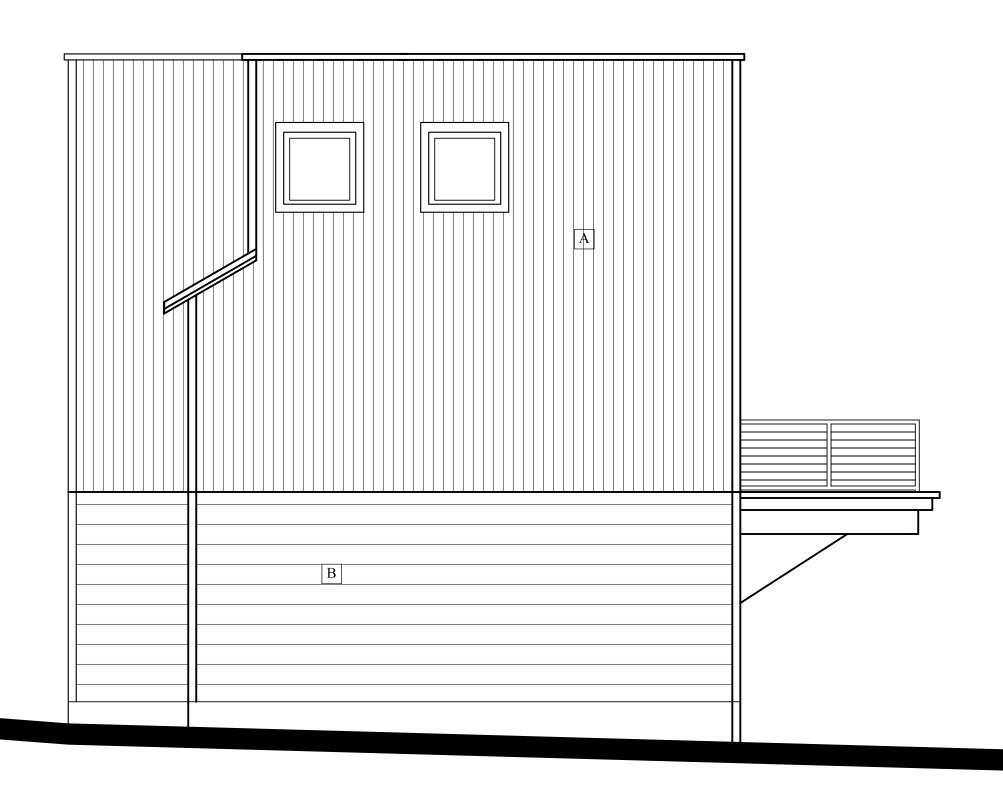


RIGHT ELEVATION SCALE: 1/4" = 1'-0"

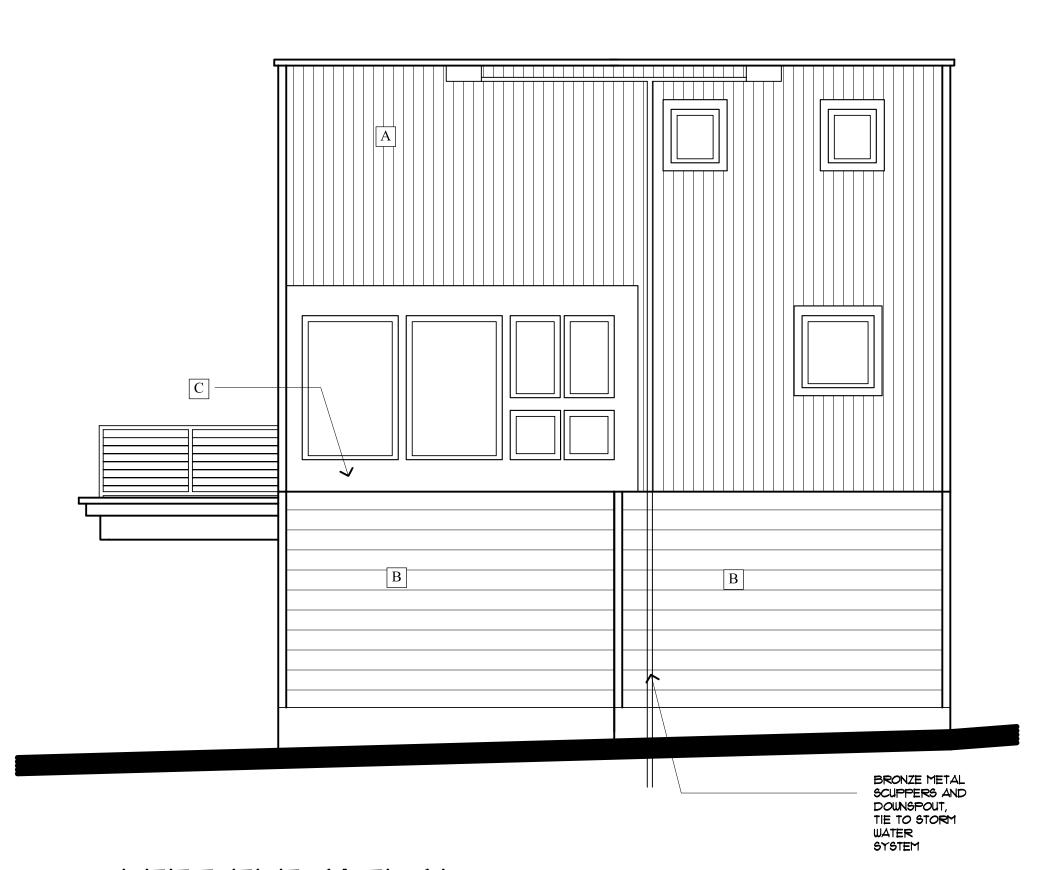

LEFT ELEVATION

SCALE: 1/4" = 1'-0"

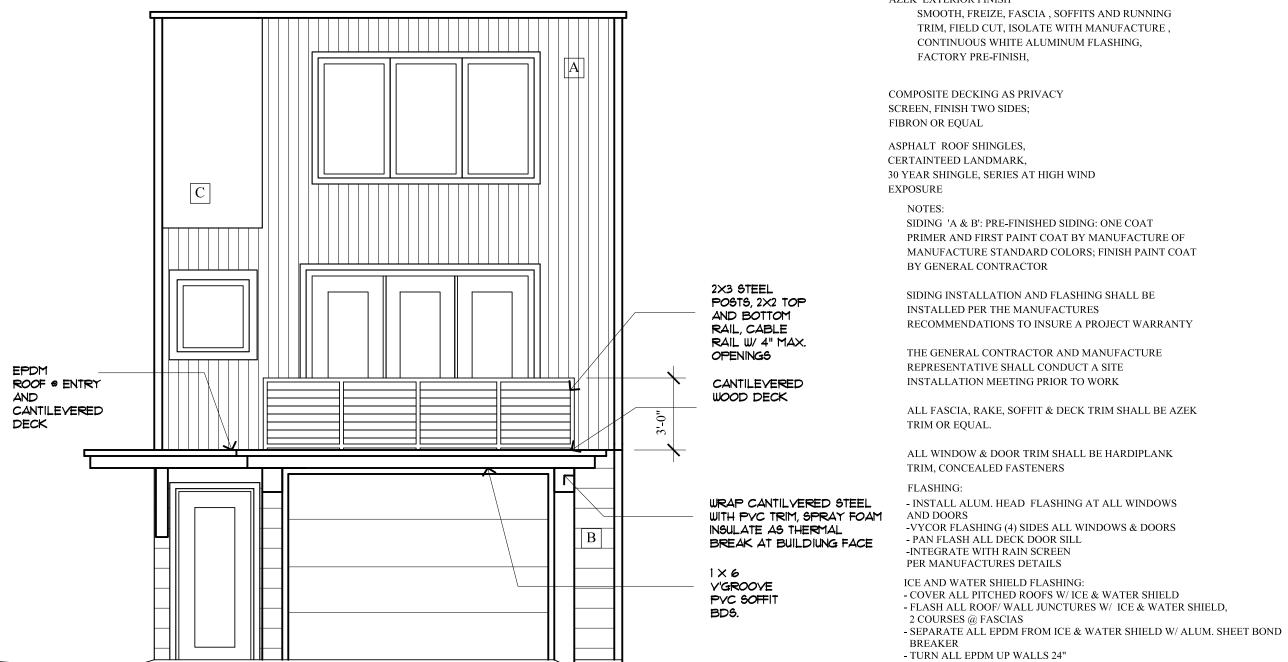

JOINT REGLETS AND FLASHING, FACTORY PRE-FINISH AZEK EXTERIOR FINISH SMOOTH, FREIZE, FASCIA , SOFFITS AND RUNNING TRIM, FIELD CUT, ISOLATE WITH MANUFACTURE, CONTINUOUS WHITE ALUMINUM FLASHING, FACTORY PRE-FINISH, COMPOSITE DECKING AS PRIVACY SCREEN, FINISH TWO SIDES; FIBRON OR EQUAL ASPHALT ROOF SHINGLES, CERTAINTEED LANDMARK, 30 YEAR SHINGLE, SERIES AT HIGH WIND EXPOSURE SIDING 'A & B': PRE-FINISHED SIDING: ONE COAT PRIMER AND FIRST PAINT COAT BY MANUFACTURE OF MANUFACTURE STANDARD COLORS; FINISH PAINT COAT BY GENERAL CONTRACTOR SIDING INSTALLATION AND FLASHING SHALL BE INSTALLED PER THE MANUFACTURES RECOMMENDATIONS TO INSURE A PROJECT WARRANTY THE GENERAL CONTRACTOR AND MANUFACTURE REPRESENTATIVE SHALL CONDUCT A SITE INSTALLATION MEETING PRIOR TO WORK ALL FASCIA, RAKE, SOFFIT & DECK TRIM SHALL BE AZEK TRIM OR EQUAL. ALL WINDOW & DOOR TRIM SHALL BE HARDIPLANK TRIM, CONCEALED FASTENERS FLASHING: - INSTALL ALUM. HEAD FLASHING AT ALL WINDOWS AND DOORS -VYCOR FLASHING (4) SIDES ALL WINDOWS & DOORS

EXTERIOR ELEVATION LEGEND A CEMENTITIOUS VERTICAL SIDING

B CEMENTITIOUS HORIZONTAL SIDING 7" TW, ROUGH , PRE-FINISHED

C CEMENTITIOUS PANELS


4" TW, SMOOTH, PRE-FINISHED

4' X 8' WIDE SHEETS, SMOOTH,

FIELD CUT, ISOLATE WITH MANUFACTURE

REAR ELEVATION

SCALE: 1/4" = 1'-0"

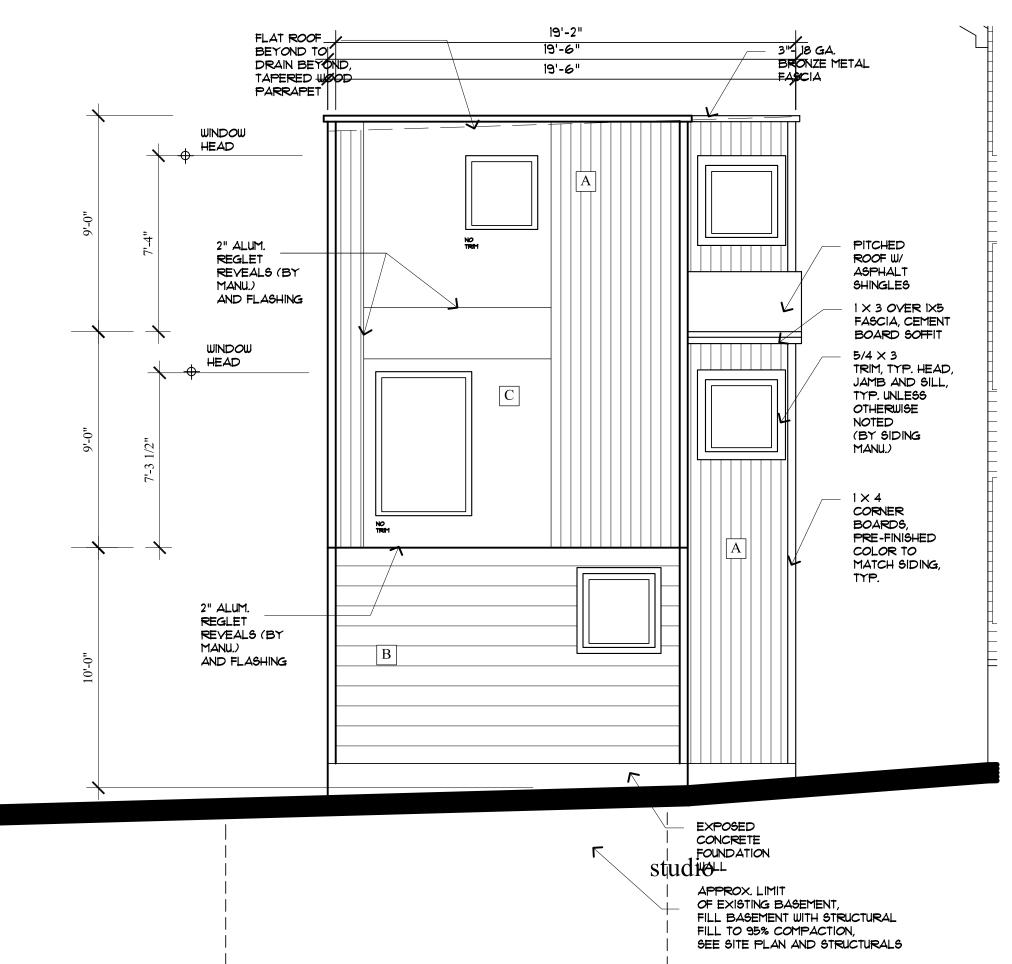

FRONT ELEVATION SCALE: 1/4" = 1'-0"

PERMIT SET: AUGUST 15, 2012



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43 CUMBERLAND STUDIO BUILDING MARK SMITH A

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JULY 24, 2012

STUDIO MLM


CHECK BY

STUDIO A-2.0

WINDOW NOTES:

- 1. ALL WINDOWS & DOORS SHALL BE PELLA 'PRO-LINE' SERIES.
- 2. COLOR:
- INTERIOR: NATURAL PINE
- EXTERIOR: MATCH THE MAIN BUILDING
- 3. GRILLS: NONE
- 4. EXTENSION JAMBS:
- VARIES APPLY PER WALL THICKNESS
- 5. GLAZING
- HIGH PERFORMANCE LOW-E GLASS W/ ARGON
- 6. CASINGS:
- INTERIOR: NO CASING
- EXTERIOR: CASING BY G.C. PER PLAN
- 7. SCREENS: (SHIP/ PACKAGE SEPARATE FROM WINDOWS)
- HIGH TRANSLUCENT ALUMINUM MESH INSECT SCREENS OR EQUAL
- DOUBLE HUNGS TO BE HALF SCREEN COLOR TO MATCH EXTERIOR
- CASEMENTS & AWNINGS TO HAVE INTERIOR METAL SURROUND FINISH TO MATCH INTERIOR
- 8. HARDWARE:
- COASTAL APPLICATION HARDWARE
- SATIN NICKEL VERIFY W/ OWNER
- STYLE: MANUFACTURE STANDARD 9. G.C. TO VERIFY WINDOW R.O. W/ WINDOW SUBMITTAL PRIOR TO CONSTRUCTION.
- 10. G.C. SHALL SUBMIT WINDOW SPECIFICATIONS TO ARCHITECT FOR APPROVAL PRIOR TO ORDER.
- 11. ADD FOR ALL AVAILABLE DP UPGRADES FOR COASTAL APPLICATIONS.
- 12. ALL FACTORY MULLS SHALL BE LVL REINFORCED.
- 13. VYCOR FLASHING @ ALL WINDOW & DOOR, HEAD, JAMB & SILLS.

Cumberland Avenue project elevation

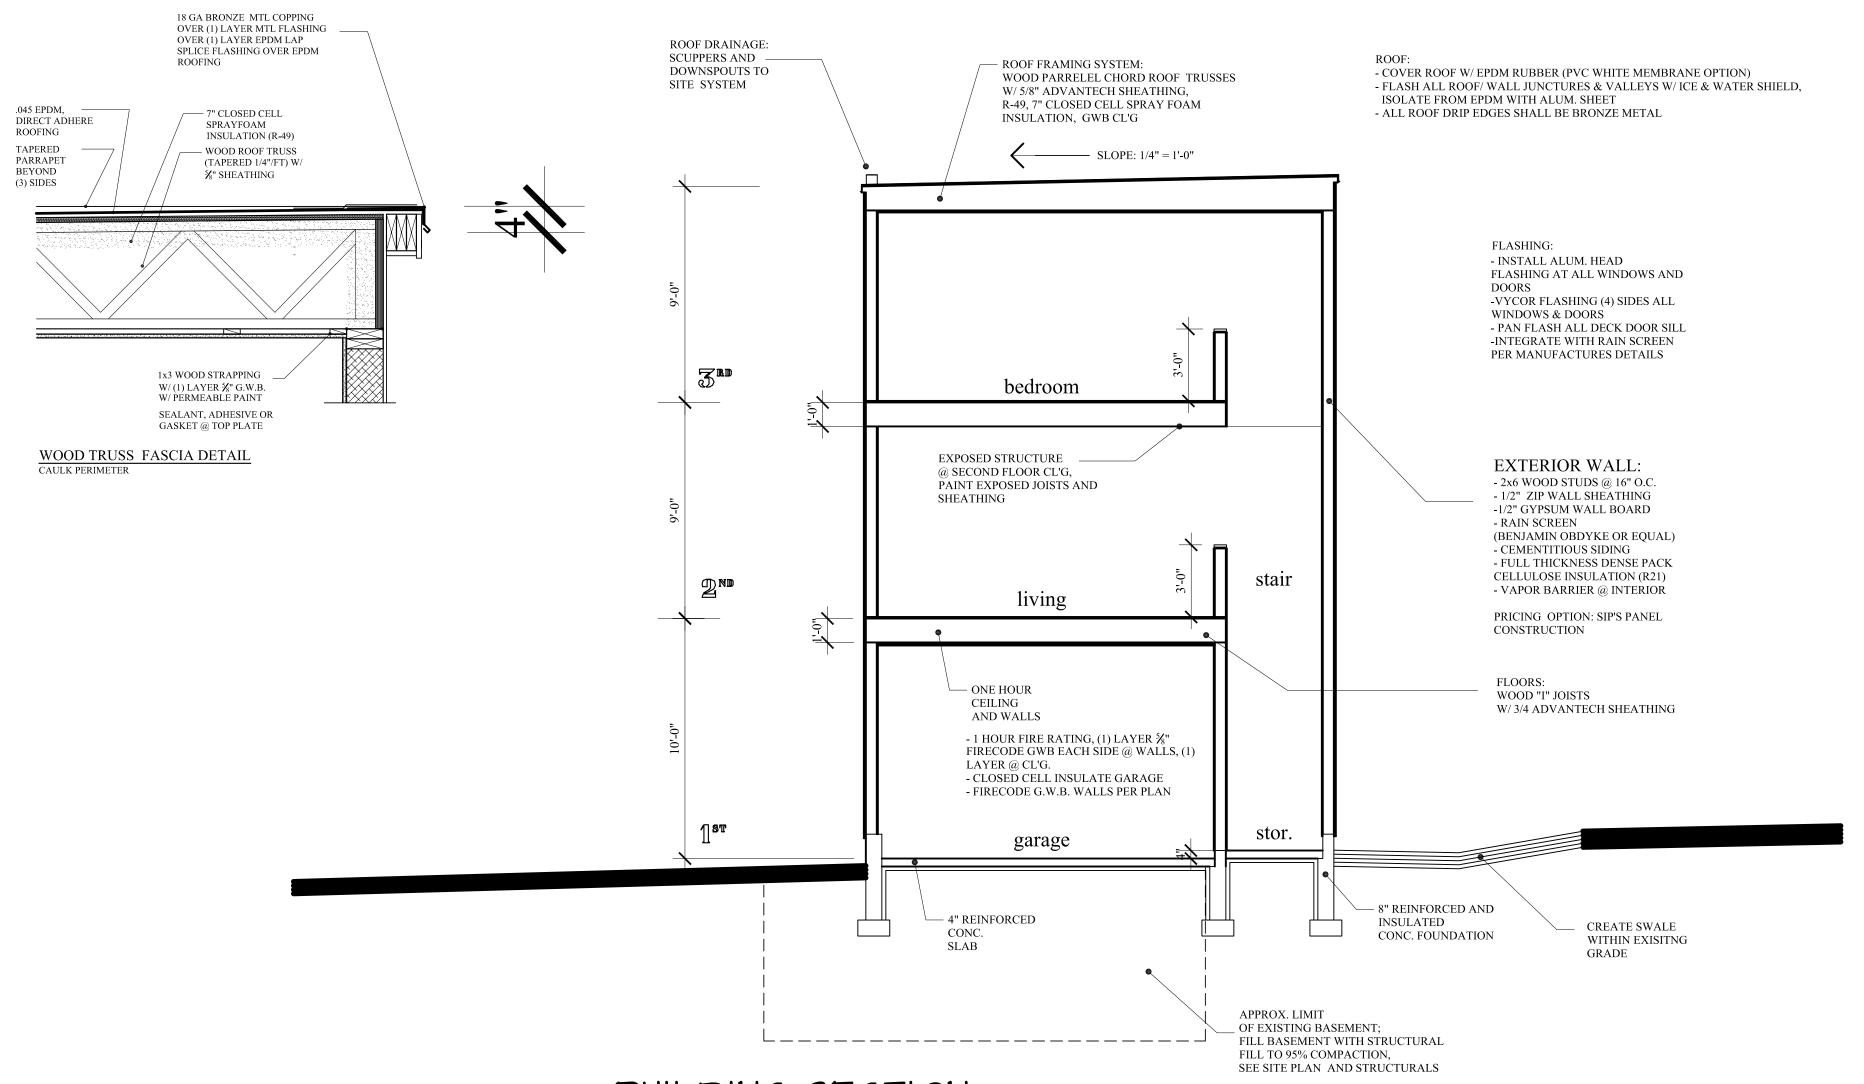

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AND STEPHANIE DUNN AND AVENUE PORTLAND, CUMBERLAND STUDIO BUILDING

STUDIO CHECK BY

PERMIT SET: AUGUST 15, 2012

BUILDING SECTION

SCALE: 1/4" = 1'-0"