CONG TU BOT - RESTAURANT FIT-UP

59 WASHINGTON AVENUE PORTLAND, MAINE

PERMIT DRAWINGS

OCTOBER 17, 2016

DRAWING LIST

SHEET NUMBER

G0-0 TITLE SHEET

G1-0 GENERAL NOTES, ABBREVIATIONS, AND LEGENDS CODE REVIEW PLAN

DEMOLITION

AD1-0 FIRST FLOOR DEMOLITION PLAN

ARCHITECTURAL

A0-1 WALL ASSEMBLIES

|-0 FIRST FLOOR PLAN |-1 FIRST FLOOR - RCP |-2 FIRST FLOOR EQUIPMENT PLAN

A4-0 INTERIOR ELEVATIONS

A5-0 DETAILS

A7-0 DOOR SCHEDULE

ARCHITECT

RYAN SENATORE ARCHITECTURE

565 CONGRESS STREET, SUITE 304, PORTLAND, MAINE 04101 207-650-6414

CONTRACTOR TO FURNISH AND INSTALL ALL NOTED LABOR AND MATERIALS UNLESS OTHERWISE NOTED.

2: CODE COMPLIANCE: ALL WORK SHALL CONFORM TO THE LATEST EDITION OF STATE, LOCAL AND OTHER CODES WHICH APPLY TO THIS PROJECT OR

3: COORDINATION:

IT IS THE RESPONSIBILITY OF THE CONTRACTOR TO COORDINATE ALL DISCIPLINES AND TRADES SO THAT ALL BUILDING SYSTEMS AND COMPONENTS CAN BE ASSEMBLED WITHOUT CONFLICTS. IN THE EVENT THAT THE CONSTRUCTION DOCUMENTS DEFINE CONDITIONS WHICH PROHIBIT, OR MAY PROHIBIT, SUCH ASSEMBLY, THE CONTRACTOR SHALL BRING TO THE ARCHITECTS ATTENTION, IN WRITING AND IN A TIMELY FASHION, SUCH CONDITION. THE CONTRACTOR SHALL NOT PROCEED WITH RELATED WORK WITHOUT A WRITTEN RESOLUTION

CLARIFICATION FROM THE ARCHITECT. THE CONTRACTOR AND HIS/HER SUBCONTRACTORS SHALL BE RESPONSIBLE FOR PROVIDING MATERIALS AND SYSTEMS SHOWN IN THE CONSTRUCTION DOCUMENTS REGARDLESS OF WHERE THE INFORMATION IS LOCATED. WHERE COMPONENTS OF A SYSTEM ARE INDICATED THE CONTRACTOR SHALL BE RESPONSIBLE FOR PROVIDING ALL LABOR AND MATERIALS NECESSARY TO COMPLETE THE SYSTEM.

4: DISCREPANCIES & CLARIFICATIONS:

THIS PROJECT INVOLVES THE FIT-UP OF AN EXISTING BUILDING. EXISTING DIMENSIONS SHOWN ON THE DRAWINGS ARE BELIEVED TO BE ACCURATE, BUT CANNOT BE GUARANTEED, MEASURE AND VERIFY DIMENSIONS IN FIELD PRIOR TO FABRICATION AND CONSTRUCTION. IT IS THE RESPONSIBILITY OF THE CONTRACTOR TO BRING TO THE ARCHITECTS ATTENTION, IN WRITING, ANY DISCREPANCIES OR AMBIGUITIES IN THE DRAWINGS AND/OR SPECIFICATIONS. THE CONTRACTOR SHALL NOT PROCEED WITH RELATED WORK WITHOUT A WRITTEN RESOLUTION OR CLARIFICATION FROM THE ARCHITECT.

5: LAYOUT:

UNLESS INDICATED OTHERWISE, CENTER WALL FRAMING AND PARTITION FRAMING ON COLUMN LINES. FLOOR PLAN DIMENSIONS ARE TO CENTER OF FRAMING, FACE OF CONCRETE, FACE OF CMU, OR FROM COLUMN CENTERLINES, UNLESS INDICATED OTHERWISE. DOORS AND WINDOWS ARE DIMENSIONED TO CENTERLINES UNLESS INDICATED OTHERWISE.

UNLESS INDICATED OTHERWISE, CENTER BUILDING ELEMENTS WITHIN OR BETWEEN OTHER BUILDING ELEMENTS WHEN CONDITIONS OR THE DRAWINGS INDICATE OR IMPLY THAT SUCH IS THE INTENT, WHETHER OR NOT DIMENSIONS ARE INCLUDED

WHERE CONDITIONS OR THE DRAWINGS INDICATE OR IMPLY THAT

SYMMETRY IS INTENDED, INFORMATION PROVIDED AT ONE SIDE APPLIES EQUALLY TO BOTH SIDES, UNLESS CONDITIONS CLEARLY PRECLUDE SUCH APPLICATION. 8: ACCESSIBILITY: ALL HANDICAPPED ACCESSIBLE BATHROOMS, GRAB BARS, AND

94-348, CHAPTER 5 OF THE MAINE HUMAN RIGHTS COMMISION TITLE LATEST EDITION & THE DEPARTMENT OF JUSTICE ADA STANDARDS FOR ACCESSIBLE DESIGN.

DOOR OPENINGS SHALL MEET THE REQUIREMENTS OF TITLE

WORK FROM THE GIVEN DIMENSIONS ONLY. SCALE IS INDICATED ON THE DRAWINGS FOR CONVENIENCE ONLY. IT IS NOT INTENDED THAT INFORMATION BE DETERMINED BY SCALING THE DRAWINGS SINCE SOME ITEMS MAY NOT BE TO SCALE.

10: WATER-RESISTANT GWB: INSTALL WATER-RESISTANT GYPSUM WALL BOARD IN ALL REST

ROOMS & TOILET ROOMS OR AT ANY WALL WITH PLUMBING FIXTURES.

10A: HIGH IMPACT GWB:

INSTALL HIGH IMPACT GYPSUM WALL BOARD IN ALL STAIRWELLS

11: INTERIOR ELEVATIONS:

INTERIOR ELEVATIONS MAY BE REVERSED FROM AND/OR SIMILAR TO ACTUAL CONDITIONS. SEE FLOOR PLANS FOR WINDOW AND DOOR QUANTITIES AND LOCATIONS, FOR CASEWORK LAYOUTS, AND FOR MONITOR LOCATIONS.

12: BUILDING INSULATION:

PROVIDE AS INDICATED IN WALL SECTIONS AND IN ACCORDANCE WITH PARTITION TYPES, WHETHER OR NOT SHOWN IN DETAILS AND OTHER DRAWINGS. FOR CLARITY, INSULATION MAY NOT BE SHOWN IN SOME CASES, EVEN IF IT IS TO BE PROVIDED.

13: BLOCKING:

INSTALL BLOCKING BEHIND ALL SURFACE-APPLIED FIXTURES TRIM. CASEWORK, SHELVES, BRACKETS, TOILET ACCESSORIES. CHAIR RAILS, PICTURE RAILS, GRAB BARS, BASE MOLDINGS, AND AS OTHERWISE REQUIRED, WHEN SUCH ITEMS ARE APPLIED ON STUD WALLS.

14: PENETRATIONS AT STRUCTURAL MEMBERS: BEFORE PENETRATING JOISTS, BEAMS OR OTHER STRUCTURAL

MEMBERS. CONSULT WITH THE ARCHITECT

15: DAMAGED WORK:

BUILDING OR SITE COMPONENTS WHICH ARE AFFECTED BY NEW WORK, DEMOLITION, OR WHICH MAY BE DAMAGED BY THE GENERAL CONTRACTOR OR ANY SUB-CONTRACTOR SHALL BE REPLACED OR RESTORED TO ORIGINAL CONDITION AND COLOR TO MEET THE APPROVAL OF THE ARCHITECT.

VERIFY THE SIZE AND LOCATION OF ALL UNDERGROUND UTILITIES AND REPORT ANY DISCREPANCIES TO THE ARCHITECT IN WRITING. DO NOT PROCEED WITH WORK UNTIL THE DISCREPANCY HAS BEEN RESOLVED TO THE SATISFACTION OF

THE ARCHITECT. 17: RATED CONSTRUCTION:

PROVIDE RATED CONSTRUCTION AS REQUIRED BY CODE, AS SPECIFIED, AND AS INDICATED ON DRAWINGS. IT IS THE RESPONSIBILITY OF THE CONTRACTOR TO PROVIDE AND INSTALL ALL COMPONENTS REQUIRED TO CREATE SUCH RATED CONSTRUCTION, REGARDLESS OF WHETHER OR NOT SUCH COMPONENTS ARE INDICATED. PROVIDE CONTINUITY OF SUCH RATED CONSTRUCTION AROUND AND BETWEEN SPACES. INCLUDING AT CHASES AND AT FLOORS, TO MAINTAIN COMPLETE SEPARATIONS, EVEN IF NOT SPECIFICALLY INDICATED.

18: SHOP DRAWINGS: SUBMIT SHOP DRAWINGS TO THE ARCHITECT FOR REVIEW PRIOR AWS TO FABRICATIONS. SUBMITTALS REQUIRED INCLUDE, BUT ARE NOT LIMITED TO. SHOP DRAWINGS FOR ALL PREFABRICATED CONCRETE, STEEL, MILLWORK & SIGNAGE, SAMPLES OF ALL PROPOSED PAINTS, METALS, WALL COVERINGS, LAMINATES, SOLID SURFACE MATERIALS, CERAMIC TILE, AND HARDWARE. SUBMIT MANUFACTURERS' DATA FOR ALL LIGHTING SYSTEMS, AND HARDWARE.

19: PERMITS

THE GENERAL CONTRACTOR SHALL OBTAIN AND PAY FOR ANY BUILDING PERMITS REQUIRED AND CARRY ANY INSURANCE COVERAGES REQUIRED.

20: INTERIOR FINISHES:

ALL INTERIOR FINISHES AND FURNISHINGS ARE TO BE CLASS 'A' FIRE-RATED AND ARE TO COMPLY WITH SECTION 920.0 BOCA (INTERIOR FLAME SPREAD).

21: ELECTRICAL DESIGN:

22: WASTE REMOVAL THE GENERAL CONTRACTOR SHALL DISPOSE OF ALL WASTE

REFER TO ELECTRICAL DRAWINGS AND SPECIFICATIONS

AND DEBRIS OFF THE PREMISES.

23: LANDLORD COORDINATION: THE GENERAL CONTRACTOR MUST COORDINATE WITH THE BUILDING OWNER ALL ACTIVITIES INCLUDING BUT NOT LIMITED TO WORK WHICH WILL GENERATE EXCESSIVE NOISE AND MODIFICATION TO UTILITIES. WORK MUST NOT INTERFERE WITH EXISTING SMOKE DETECTORS, ALARMS OR BUILDING SYSTEM MANAGEMENT.

24: TEMPORARY FACILITIES:

PROVIDE ALL TEMPORARY FACILITIES AND SERVICES, CONSTRUCTION AND SUPPORT FACILITIES, AND SECURITY AND PROTECTION AS NEEDED TO PROTECT NEW AND EXISTING CONSTRUCTION FOR THE DURATION OF A COMPLETE INSTALLATION.

25: FINAL CLEANING

EMPLOY EXPERIENCED WORKERS FOR FINAL CLEANING. CLEAN EACH SURFACE TO THE CONDITION EXPECTED IN A

COMMERCIAL BUILDING CLEANING PROGRAM.

26: MANUFACTURERS INSTRUCTIONS: ALL MATERIALS & EQUIPMENT SHALL BE INSTALLED ACCORDING TO MANUFACTURER'S SPECIFICATIONS.

GUARANTEE: ALL MATERIALS AND WORKMANSHIP SHALL BE GUARANTEED FOR A PERIOD OF ONE YEAR FROM THE DATE OF FINAL ACCEPTANCE UNLESS OTHERWISE SPECIFIED FOR A LONGER PERIOD OF TIME ON A CERTAIN ITEM.

ALL MATERIAL USED FOR THE CONSTRUCTION OF THIS PROJECT, WHETHER BUILDING MATERIALS OR

APPURTENANCES, SHALL BE NON-ASBESTOS CONTAINING MATERIAL. 29: HAZARDOUS FUMES: THE GENERAL CONTRACTOR SHALL CONFIRM THAT ALL

MATERIAL AND FINISHES SPECIFIED AND THEIR FABRICATION

OR INSTALLATION WILL NOT RELEASE FUMES OR AROMAS DURING CONSTRUCTION WHICH MAY BE A HAZARD OR NUISANCE TO PERSONNEL. 30: PEST CONTROL:

SEAL AND CAULK AROUND ALL PENETRATIONS, CRACKS AND

CREVICES AND ANY OPENINGS CAPABLE OF HARBORING INSECTS/RODENTS.

31. EXPOSED UTILITIES: ALL EXPOSED UTILITY WIRES AND PIPES (ELECTRICAL PLUMBING, ETC.) SHALL BE INSTALLED IN A WAY THAT DOES NOT OBSTRUCT OR PREVENT THE CLEANING OF FLOORS, WALLS, AND CEILING AREAS. THEY SHALL BE INSTALLED A

MINIMUM OF 6" OFF FLOORS AND 1" OFF WALLS, CEILINGS AND

ADJACENT PIPES.

32. OWNER SUPPLIED EQUIPMENT: EQUIPMENT SUPPLIED BY THE OWNER AND INSTALLED BY THE GENERAL CONTRACTOR: EQUIPMENT INFORMATION AND SPECIFICATIONS ARE TO BE THE MOST CURRENT AVAILABLE AT THE TIME OF DOCUMENTATION PREPARATION. THE GENERAL CONTRACTOR SHALL BE RESPONSIBLE FOR VERIFYING WITH THE OWNER THE EXACT DIMENSIONS AND EQUIPMENT CONNECTION REQUIREMENTS (INCLUDING ELECTRICAL CIRCUIT REQUIREMENTS) OF EQUIPMENT TO BE SUPPLIED. THE GENERAL CONTRACTOR SHALL MAKE ALL FINAL CONNECTIONS AS NOTED ON THE DRAWINGS, INSTALL THE SET UP IN WORKING ORDER, CHECK WARRANTIES, TEST AND NOT VOID WARRANTIES. THE GENERAL CONTRACTOR SHALL COORDINATE WITH THE OWNER DELIVERY, STORAGE AND INSTALLATION OF ALL OWNER SUPPLIED EQUIPMENT. THE GENERAL CONTRACTOR SHALL STORE EQUIPMENT IF REQUESTED BY THE OWNER UNTIL INSTALLATION. SEE DRAWINGS FOR OTHER OWNER SUPPLIED/GENERAL

33: FIRE PROTECTION NOTE:

CONTRACTOR INSTALLED ITEMS.

EXISTING SPRINKLERHEADS, ALARM SYSTEM AND DETECTORS ARE TO BE MODIFIED TO CONFORM, WITH THE PROPOSED PLAN. COORDINATE WITH THE ARCHITECT, ANY MODIFICATION OR LOCATIONS WHERE EXISTING SYSTEMS ARE AFFECTED BY THE NEW DESIGN.

34: SOILS AT FOOTINGS:

REPORT THE LOCATION OF ALL UNSUITABLE SOILS AND MATERIALS BELOW ANTICIPATED LEVEL OF FOOTING TO THE ARCHITECT PRIOR TO THE SETTING OF FORMS.

35: ACCESS PANELS:

CONTRACTOR IS RESPONSIBLE FOR COORDINATING QUANTITY AND LOCATION OF ALL REQUIRED ACCESS PANELS FOR ALL MEP CONTROLS, CLEANOUTS, DAMPERS, PULL BOXES, ETC.

36: EXISTING HAZARDOUS MATERIALS ALL HAZARDOUS MATERIALS INCLUDING BUT NOT LIMITED TO ASBESTOS AND LEAD PAINT ARE TO BE HANDLED, ENCAPSULATED, ABATED AND DISPOSED OF IN ACCORDANCE WITH ANY AND ALL FEDERAL, STATE AND LOCAL REQUIREMENTS AND REGULATIONS.

37: INDUSTRY STANDARDS:

ALL WORK SHALL BE PERFORMED IN ACCORDANCE WITH INDUSTRY STANDARDS. STANDARDS INCLUDE BUT ARE NOT LIMITED TO THE FOLLOWING:


AAMA AMERICAN ARCHITECTURAL MANUFACTURERS ASSOCATION

AMERICAN CONCRETE INSTITUTE AMERICAN NATIONAL STANDARDS INSTITUTE AMERICAN SOCIETY FOR TESTS AND MATERIALS ASTM ARCHITECTURAL WOODWORK INSTITUTE "CUSTOM GRADE"

AMERICAN WELDING SOCIETY INSULATING GLASS MANUFACTURERS ALLIANCE NAAMM NATIONAL ASSOCIATION OF ARCHITECTURAL METAL MANUFACTURERS

NRCA NATIONAL ROOFING CONTRACTORS ASSOCIATION NATIONAL TILE CONTRACTORS ASSOCIATION SMACNA SHEET METAL AND AIR CONDITIONING NATIONAL ASSOCIATION

WDMA WINDOW AND DOOR MANUFACTURERS ASSOCIATION

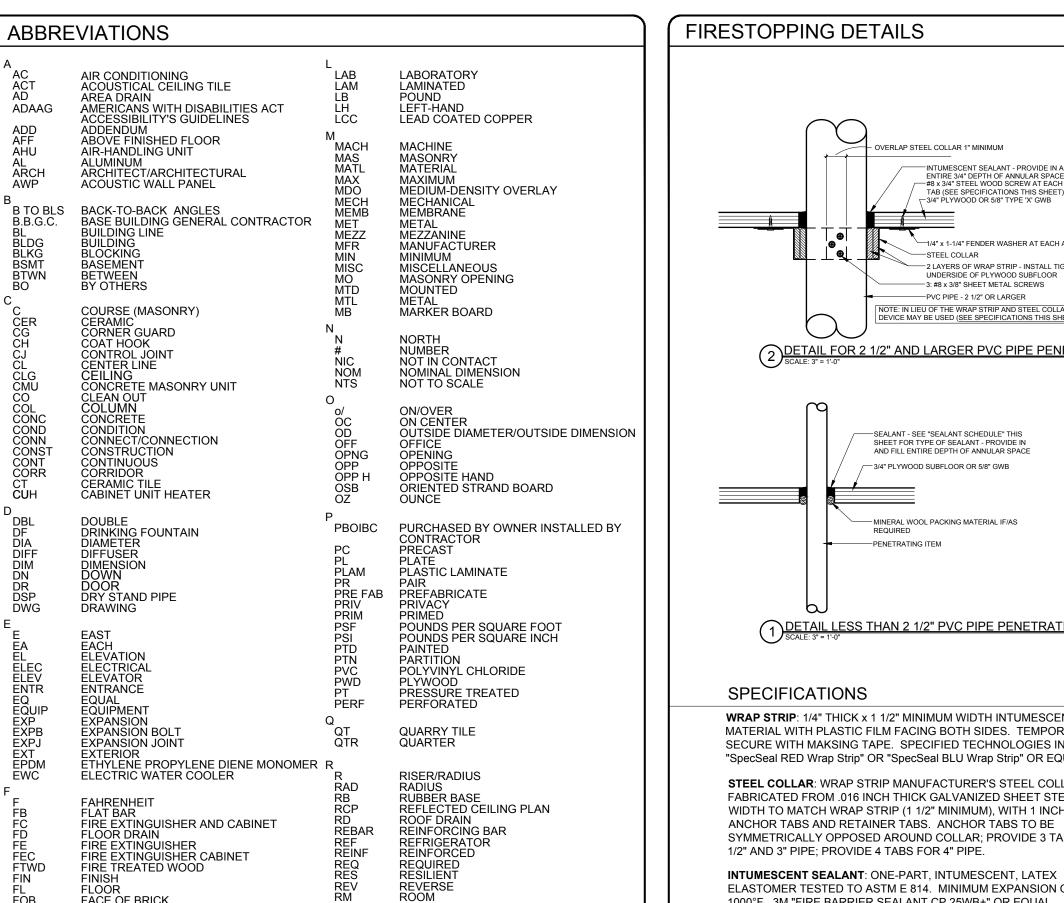

ROUGH OPENING

RIGHT OF WAY

CHEDULE

SQUARE FEET

SPECIFICATION

SUSPENSION

ELEPHONE

TOP OF DECK

TYPICAL TELEVISION

ACK BOARD

TOP OF CONCRETE

UNIT VENTILATOR

VERIFY IN FIELD

VOLUME

WITHOUT

WORK POINT WEIGHT

WITH

VINYL COMPOSITION TILE

TOP OF STEEL

TAINLESS STEEL

TONGUE&GROOVE

SOUND TRANSMISSION CLASS STANDARD

UNDERWRITERS LABORATORIES, INC.

ROW

SCHED

VOL

ROOM NAME

AND NUMBER

DOOR NUMBER

WINDOW NUMBER

FLOOR-CEILING TYPE

ROOF SYSTEM TYPE

FIRE EXTINGUISHER

FACE OF CONCRETE

FIN TUBE RADIATION

GENERAL CONTRACTOR

LASS/GLAZING/GLAZED

GLUE-LAMINATED WOOD

GYPSUM WALL BOARD

GROUND-FAULT INTERRUPTER

HORSE POWER/HIGH POINT/HEAT PUMP

INSIDE DIMENSION/INSIDE DIAMETER INCHES

HEATING VENTILATION AIR CONDITIONING UV

BEDROOM

FUME HOOD

GALVANIZED

GRAB BAR

HANDICAP

HOT WATER

INFORMATION

INSULATION

DRAWING LEGEND

POROUS FILL

CONCRETE

WOOD - ROUGH

GYPSUM BOARD

CELLULOSE INSULATION

RIGID INSULATION

BATT INSULATION

CONCRETE MASONRY UNIT

HOLLOW METAL

GALV

HORIZ HP

HVAC

INFO INSUL


FACE OF WALL FIRE SUPPRESSION SYSTEM


FIBER REINFORCED GYPSUM

FACE OF FINISH

FACE OF STUDS

FIRESTOPPING DETAILS

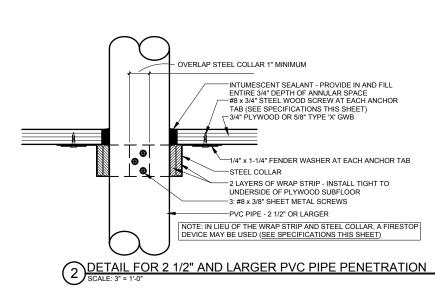

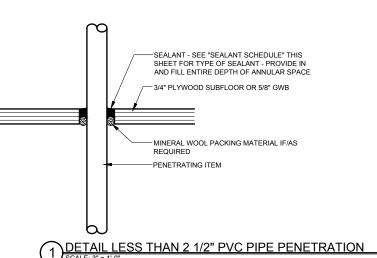

SPECIFICATIONS

WRAP STRIP: 1/4" THICK x 1 1/2" MINIMUM WIDTH INTUMESCENT MATERIAL WITH PLASTIC FILM FACING BOTH SIDES. TEMPORARILY SECURE WITH MAKSING TAPE. SPECIFIED TECHNOLOGIES INC. (STI) "SpecSeal RED Wrap Strip" OR "SpecSeal BLU Wrap Strip" OR EQUAL.

STEEL COLLAR: WRAP STRIP MANUFACTURER'S STEEL COLLAR, FABRICATED FROM .016 INCH THICK GALVANIZED SHEET STEEL, WIDTH TO MATCH WRAP STRIP (1 1/2" MINIMUM), WITH 1 INCH x 2 INCH ANCHOR TABS AND RETAINER TABS. ANCHOR TABS TO BE SYMMETRICALLY OPPOSED AROUND COLLAR; PROVIDE 3 TABS FOR 2

1000°F. 3M "FIRE BARRIER SEALANT CP 25WB+" OR EQUAL. FIRESTOP SEALANT: SINGLE COMPONENT NONCOMBUSTIBLE FIRE RATED SEALANT TESTED TO ASTM E 814. TESTED TO 3000°F. "BOSS 136 FIRESTOP/DRAFT SEALANT" MANUFACTURED BY ACCUMETRIC,

INTUMESCENT SEALANT: PROVIDE AT ALL PENETRATIONS THROUGH RATED CONSTRUCTION FOR PENETRATING ITEMS INCLUDING BUT NOT LIMITED TO: PVC PIPE; ROOF LEADER PIPES; GAS PIPES & LINES; SPRINKLER PIPES: ELECTRICAL & COMMUNICATIONS CABLES & WIRES AND ALARM SYSTEM WIRES. DO NOT USE INTUMESCENT SEALANT AT DOMESTIC HOT WATER OR HYDRONIC HEATING SYSTEM PIPES.

FIRESTOP SEALANT: PROVIDE AT ALL PENETRATIONS THROUGH

FOR LOCATIONS OF RATED CONSTRUCTION, SEE ARCHITECTURAL

1/2" AND 3" PIPE; PROVIDE 4 TABS FOR 4" PIPE.

ELASTOMER TESTED TO ASTM E 814. MINIMUM EXPANSION OF 3x AT

SEALANT SCHEDULE:

LLC., OR EQUAL.

RATED CONSTRUCTION FOR PENETRATING ITEMS INCLUDING DOMESTIC HOT AND COLD WATER PIPES AND HYDRONIC HEATING SYSTEM PIPES.

- ELEVATION COMPASS NUMBER

INTERIOR ELEVATION SYMBOL

FLOORING TYPE TRANSITION

SHEET WHERE ELEVATION LOCATED

- ELEVATION NUMBER

SECTION NUMBER

DETAIL NUMBER

PARTITION TYPE

----- 1HR FIRE RATED WALL

2HR FIRE RATED WALL

SECTION MARK

SHT WHERE SECTION LOCATED

SHT WHERE DETAIL LOCATED

PARTITION TYPE TAG

- PARTITION HEIGHT DESIGNATION

FLOOR PLANS AND SECTIONS

WALL AND PARTITION NOTES

GENERAL PARTITION NOTES:

WITH PLUMBING FIXTURES.

2.) ALL PARTITION TYPES WITH AN INSULATION COMPONENT TO BE ACOUSTICALLY SEALED.

3.) PENETRATIONS THROUGH RATED WALLS AND CEILING ASSEMBLIES SHALL HAVE SEALANTS CONFORMING TO RATING REQUIREMENTS.

5.) PATCH EXISTING WALLS AS REQUIRED IF POSSIBLE (IF DAMAGE IS EXTENSIVE SEE NOTE 10)

6.) RUN NEW 5/8" GWB OVER DAMAGED EXISTING WALL COVERING IF NECESSARY

4.) HOLD BOTTOM EDGE OF GWB 1/2" UP FROM CONCRETE TYPICAL

RYAN J. **SENATORE** No. 3322

© 2016 RYAN SENATOR

ARCHITECTURE

 $\sum_{i=1}^{N}$ AVE SHING 0



CONSULTANTS:

REVISIONS:


DATE: 17, OCTOBER 201


PROJECT No. DRAWN BY: JPF, RJS

SCALE: AS NOTED

CHECKED BY:

SHEET TITLE: **GENERAL ABBREVIATIONS** AND LEGENDS

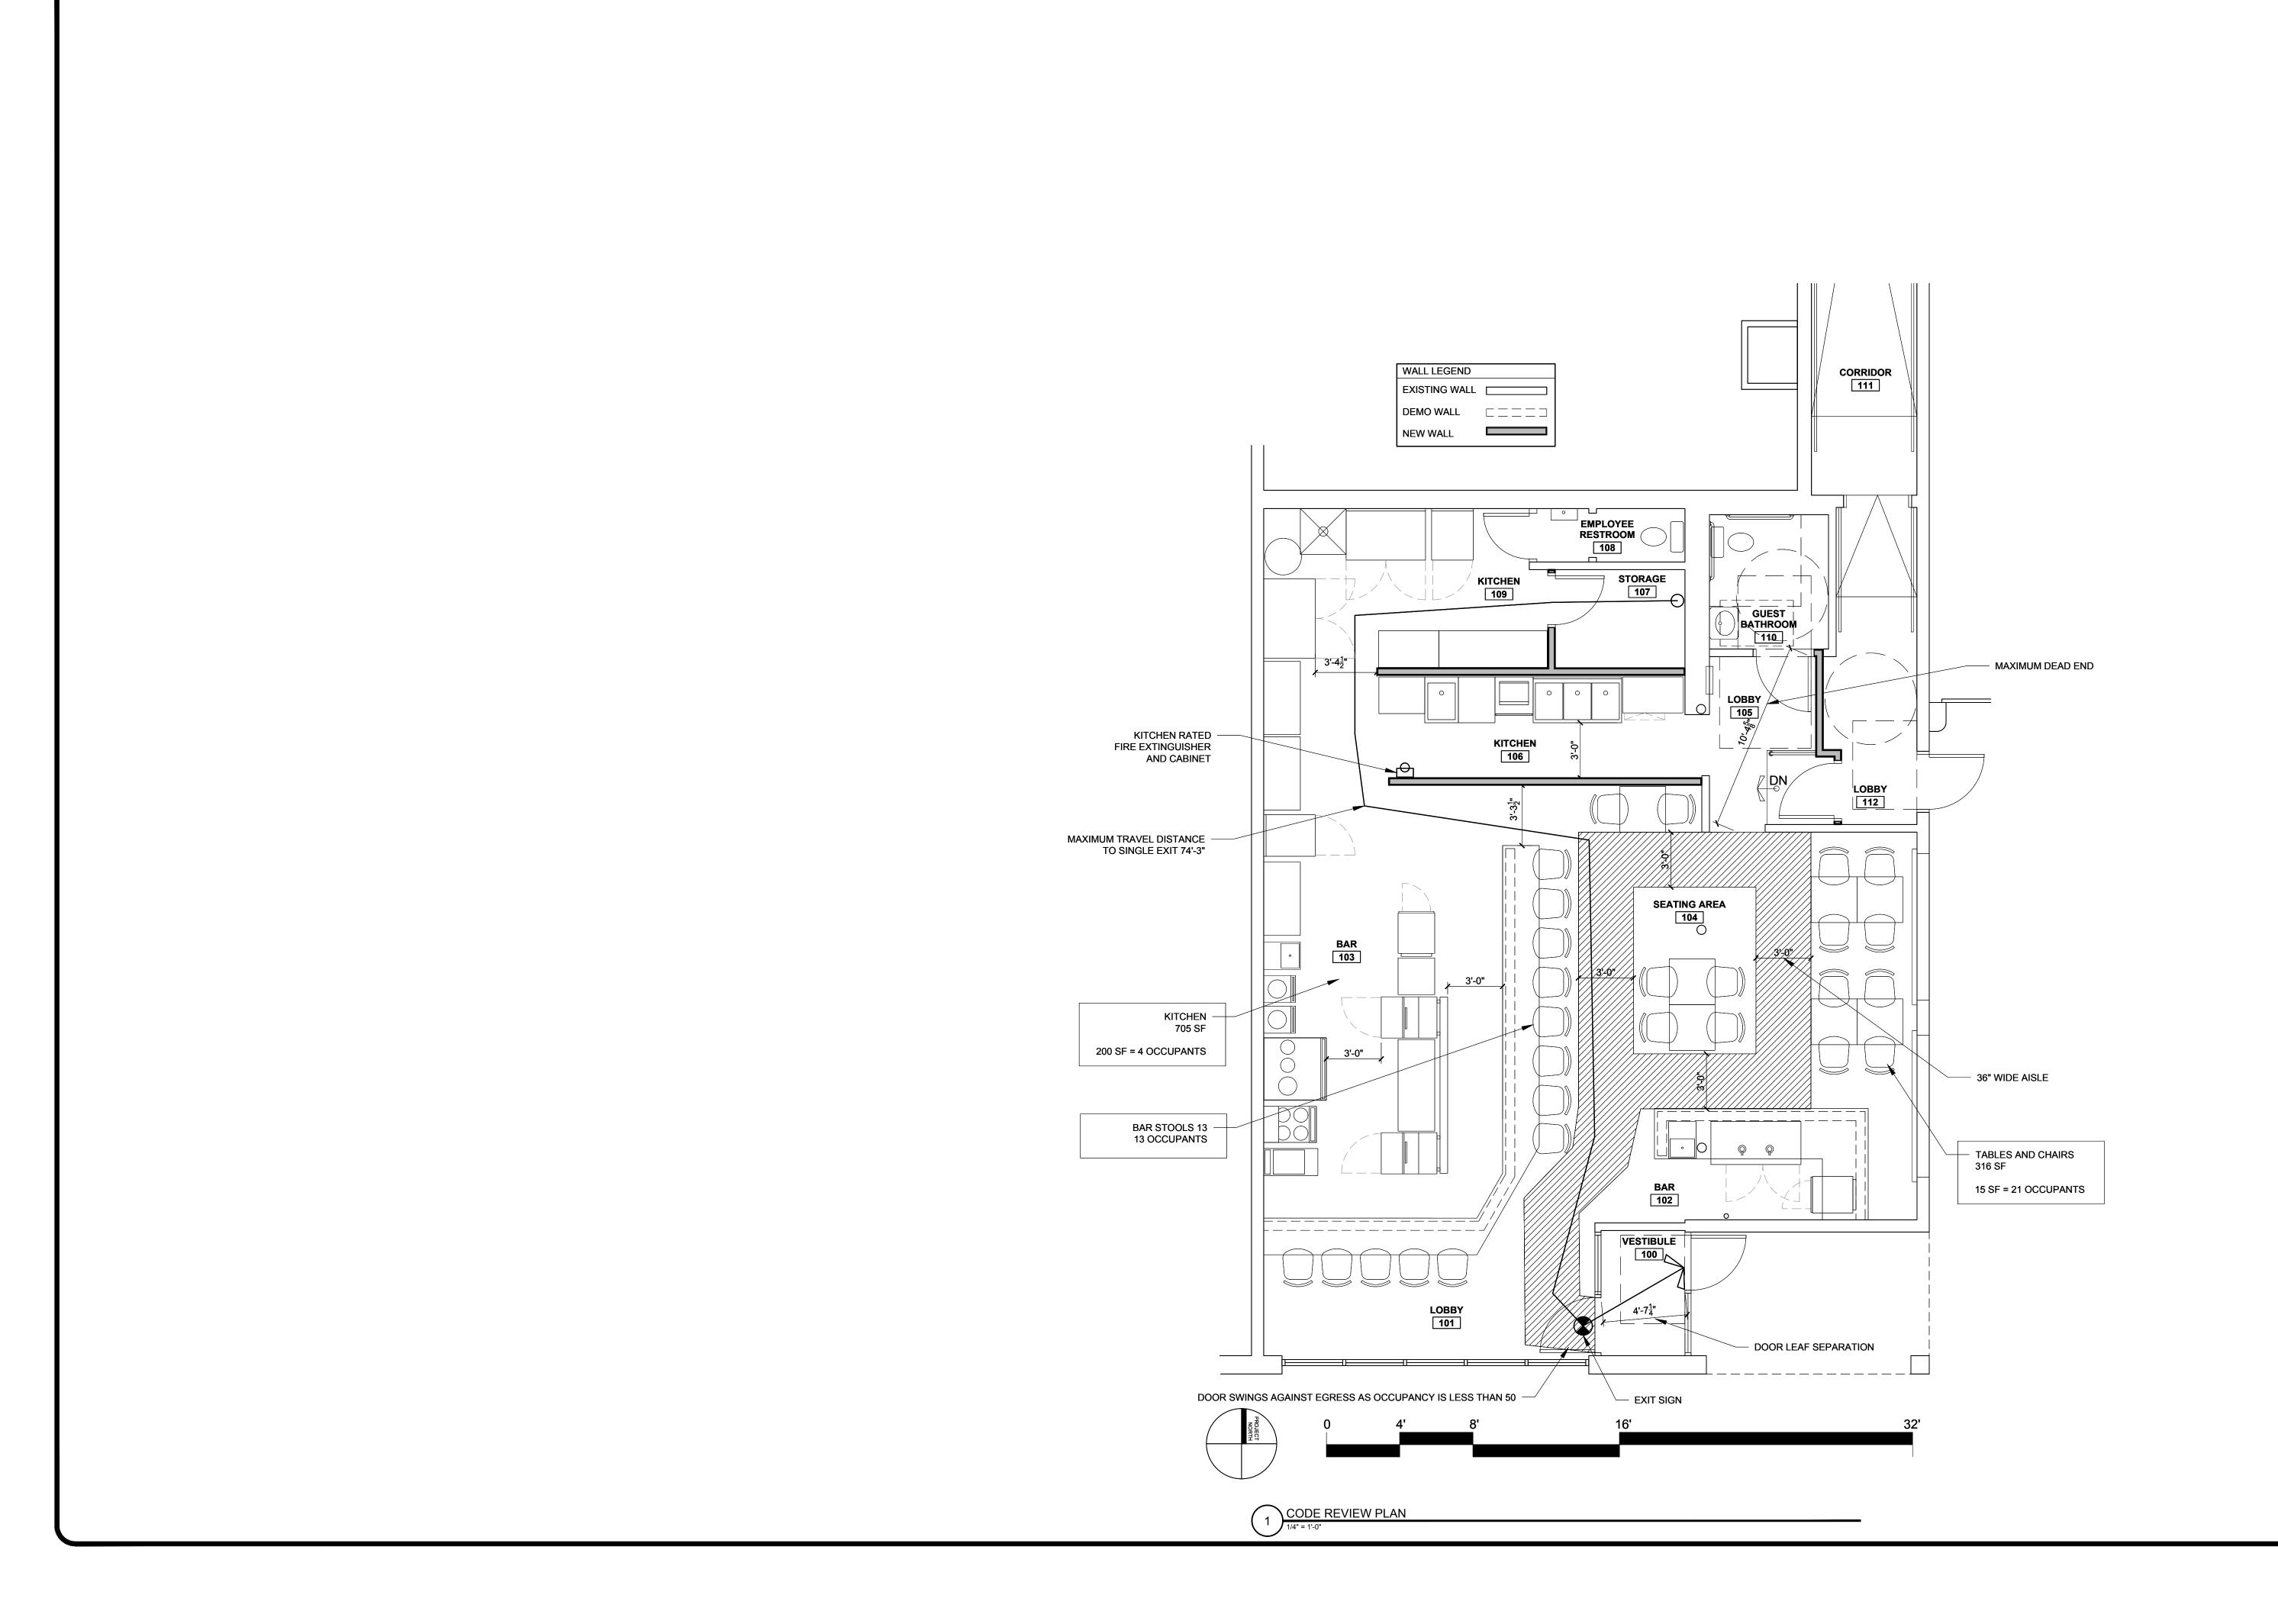

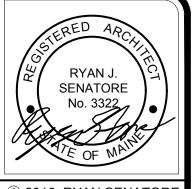

TU BOT - RESTAURANT FIT-UP WASHINGTON AVENUE

CONG ARCHITECTURE
565 CONGRESS STREET
PORTLAND, MAINE 04101
207-650-6414
senatorearchitecture.com

59

CONSULTANTS:

REVISIONS:

DATE: 17, OCTOBER 2016 PROJECT No. DRAWN BY: JPF, RJS

CHECKED BY: AS NOTED SCALE:

SHEET TITLE:

CODE REVIEW PLAN


DEMO LEGEND

R-F REMOVE FLOORING

R-C REMOVE CEILING

DEMOLITION NOTES

-) ALL HAZARDOUS MATERIALS TO BE REMOVED AND DISPOSED OF IN ACCORDANCE WITH ALL FEDERAL, STATE AND LOCAL REGULATIONS.
- 2.) IF ANY ELEMENTS TO BE REMOVED ARE FOUND TO BE STRUCTURAL, THE G.C. SHALL NOTIFY THE ARCHITECT IN WRITING PRIOR TO REMOVING SUCH ELEMENTS
-) REMOVAL ALL UNUSED PLUMBING, ELECTRICAL, AND MECHANICAL ELEMENTS THAT ARE NOT PROPOSED TO BE
- 4.) AT LOCATIONS OF FLOORING INDICATED TO BE REMOVED REMOVE ALL LAYERS OF FINISHED FLOORING UNDERLAYMENT AND ADHESIVES DOWN TO SLAB OR SHEATHING
- 5.) AT LOCATIONS OF CEILINGS INDICATED TO BE REMOVED REMOVE ALL CEILINGS, TILES, GRIDS, AND STRAPPING TO JOISTS OR FRAMING AS WELL AS ANY IN CEILING ELEMENTS NOT SCHEDULE TO BE REUSED
- .) RELOCATE AND REINSTALL ANY AND ALL FUNCTIONING MECHANICAL, ELECTRICAL AND PLUMBING ELEMENTS LOCATED IN WALLS, FLOORS AND CEILINGS INDICATED TO BE
- REMOVE ALL WALL COVERINGS ON WALLS INDICATED TO BE REMOVED, REPAINTED OR RE COVERED
- 8.) PATCH AND REPAIR ALL WALLS CEILINGS AND FLOORS AT LOCATIONS OF REMOVED INTERSECTING WALLS, REMOVED BUILT-INS, ETC.
- 9) G.C. TO CONFIRM WITH STRUCTURAL ENGINEER BEFORE CUTTING SLAB.
- 10) G.G. TO VERIFY EXISTING PLUMBING PIPE DEPTHS TO ENSURE NEW DRAIN LINE FROM BAR HAS ADEQUATE PITCH, PRIOR TO WORK.

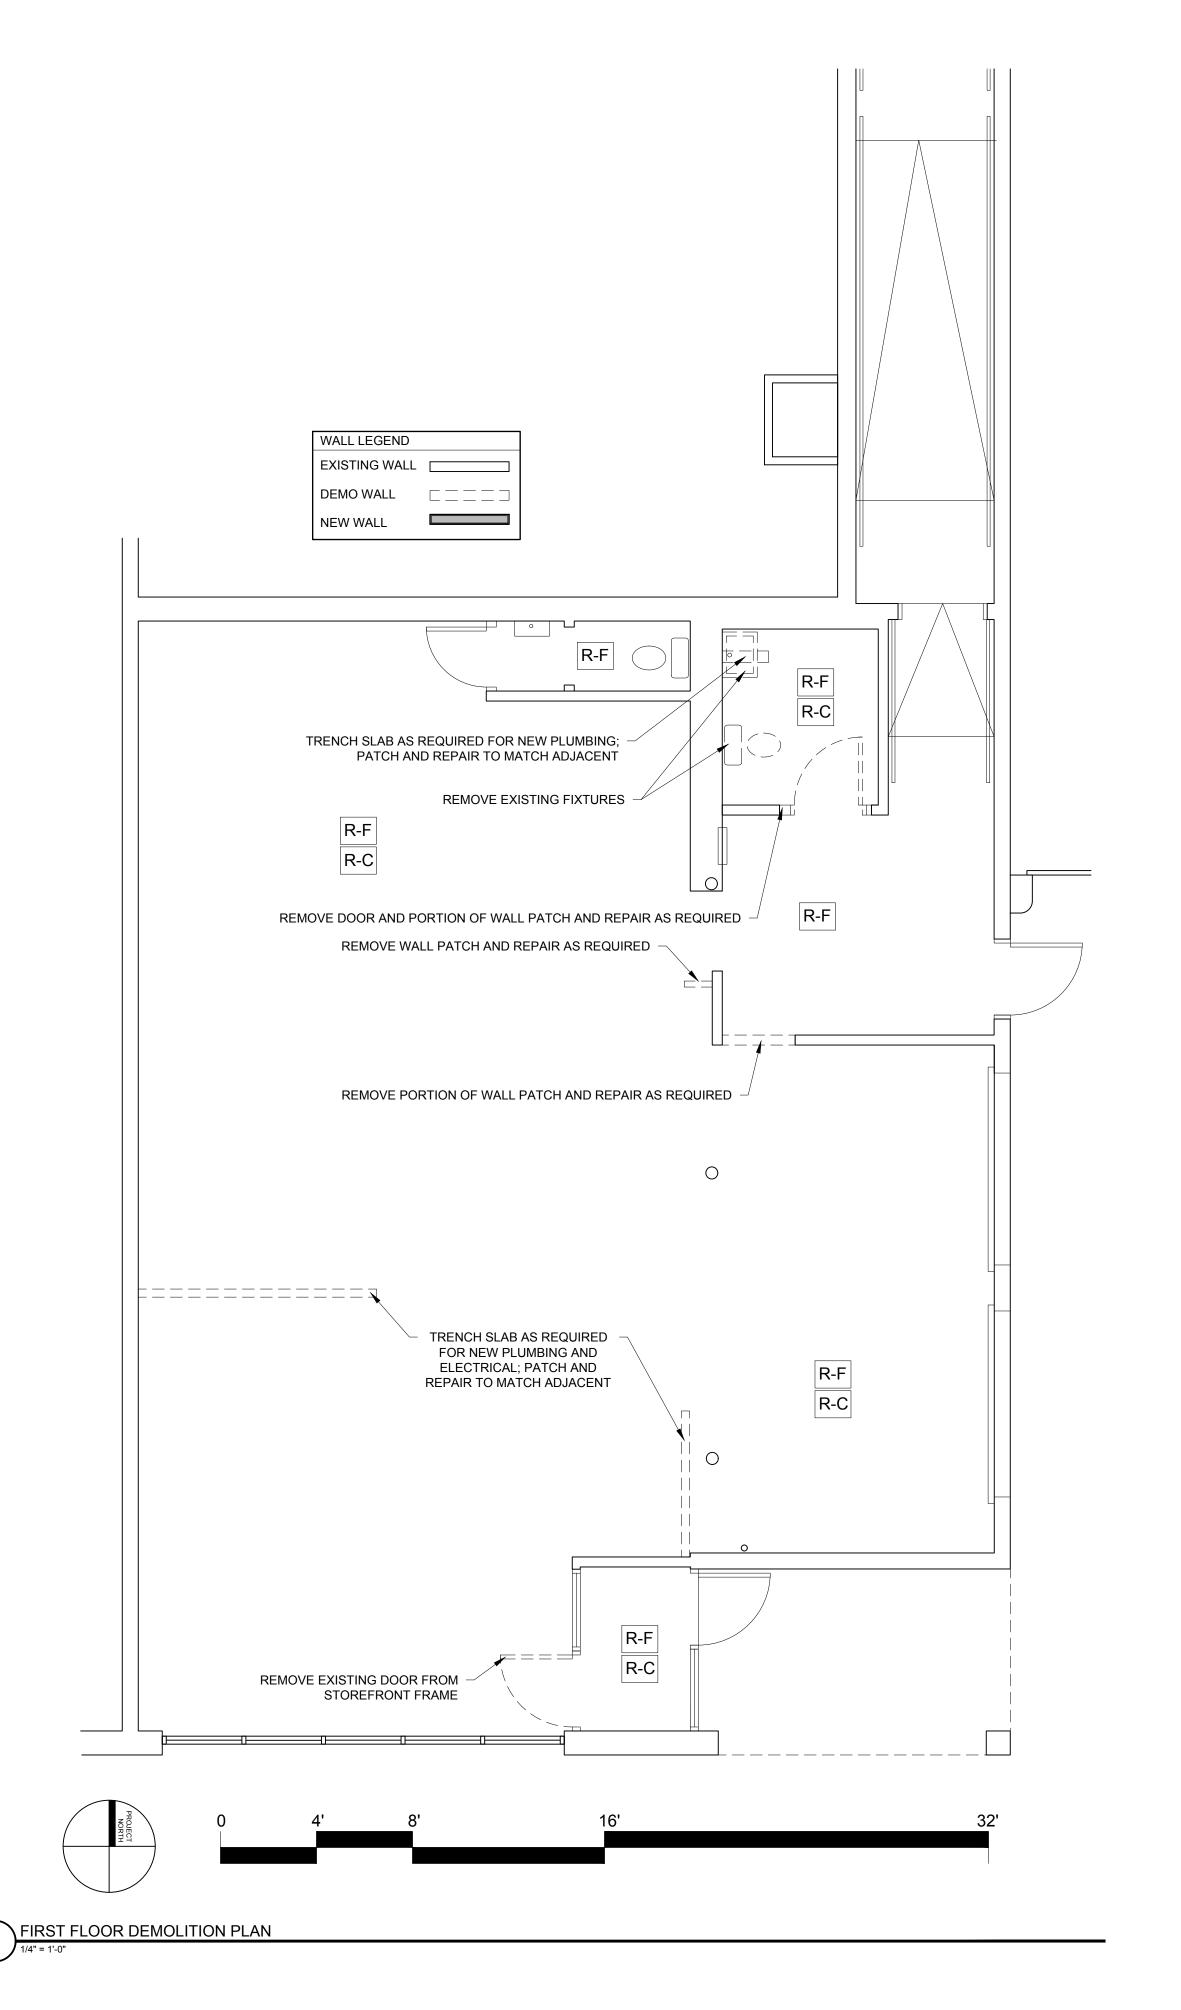



© 2016 RYAN SENATORE

ARCHITECTURE

STAURANT WASHINGTON AVENUE PORTLAND, MAINE

59



CONSULTANTS:

REVISIONS:

DATE: 17, OCTOBER 2016

PROJECT No. DRAWN BY: JPF, RJS

AS NOTED SCALE:


CHECKED BY:


SHEET TITLE: FIRS FLOOR DEMOLITION PLAN

		© 2016 RYAN SENATOR ARCHITECTUR
		ONG TU BOT - RESTAURANT FIT-UP 59 WASHINGTON AVENUE PORTI AND MAINE
	GRAPHIC DEPICTION DESCRIPTION	RS A
	- LAYER OF 5/8" GWB - 3 5/8" LIGHT GAUGE METAL STUDS AT 16" O.C LAYER OF 5/8" GWB	RYAN SENATORE ARCHITECTURE 565 CONGRESS STREET PORTLAND, MAINE 04101 207-650-6414 senatorearchitecture.com CONSULTANTS:
GRAPHIC DEPICTION DESCRIPTION	NB FIRE RATING UL NUMBER STC RATING IIC RATING N/A N/A N/A GRAPHIC DEPICTION DESCRIPTION	DATE: 17, OCTOBER 2 PROJECT No. 1
- LAYER OF TYPE 'X' 5/8" GWB - 3-5/8" LIGHT GAUGE METAL STUDS AT 24" O.C 3-1/2" SOUND BATT INSULATION - LAYER OF TYPE 'X' 5/8" GWB	- LAYER OF 5/8" GWB - 3.5/8" LIGHT GAUGE METAL STUDS AT 16" O.C.	DRAWN BY: JPF, I CHECKED BY: SCALE: AS NOT SHEET TITLE: WALL ASSEMBLIES
TYPE 1A FIRE RATING UL NUMBER STC RATING IIC RATING 1 HR V450 50-54 N/A	TYPE FIRE RATING UL NUMBER STC RATING IIC RATING N/A N/A	A0-1



1643 , RJS RJS DTED

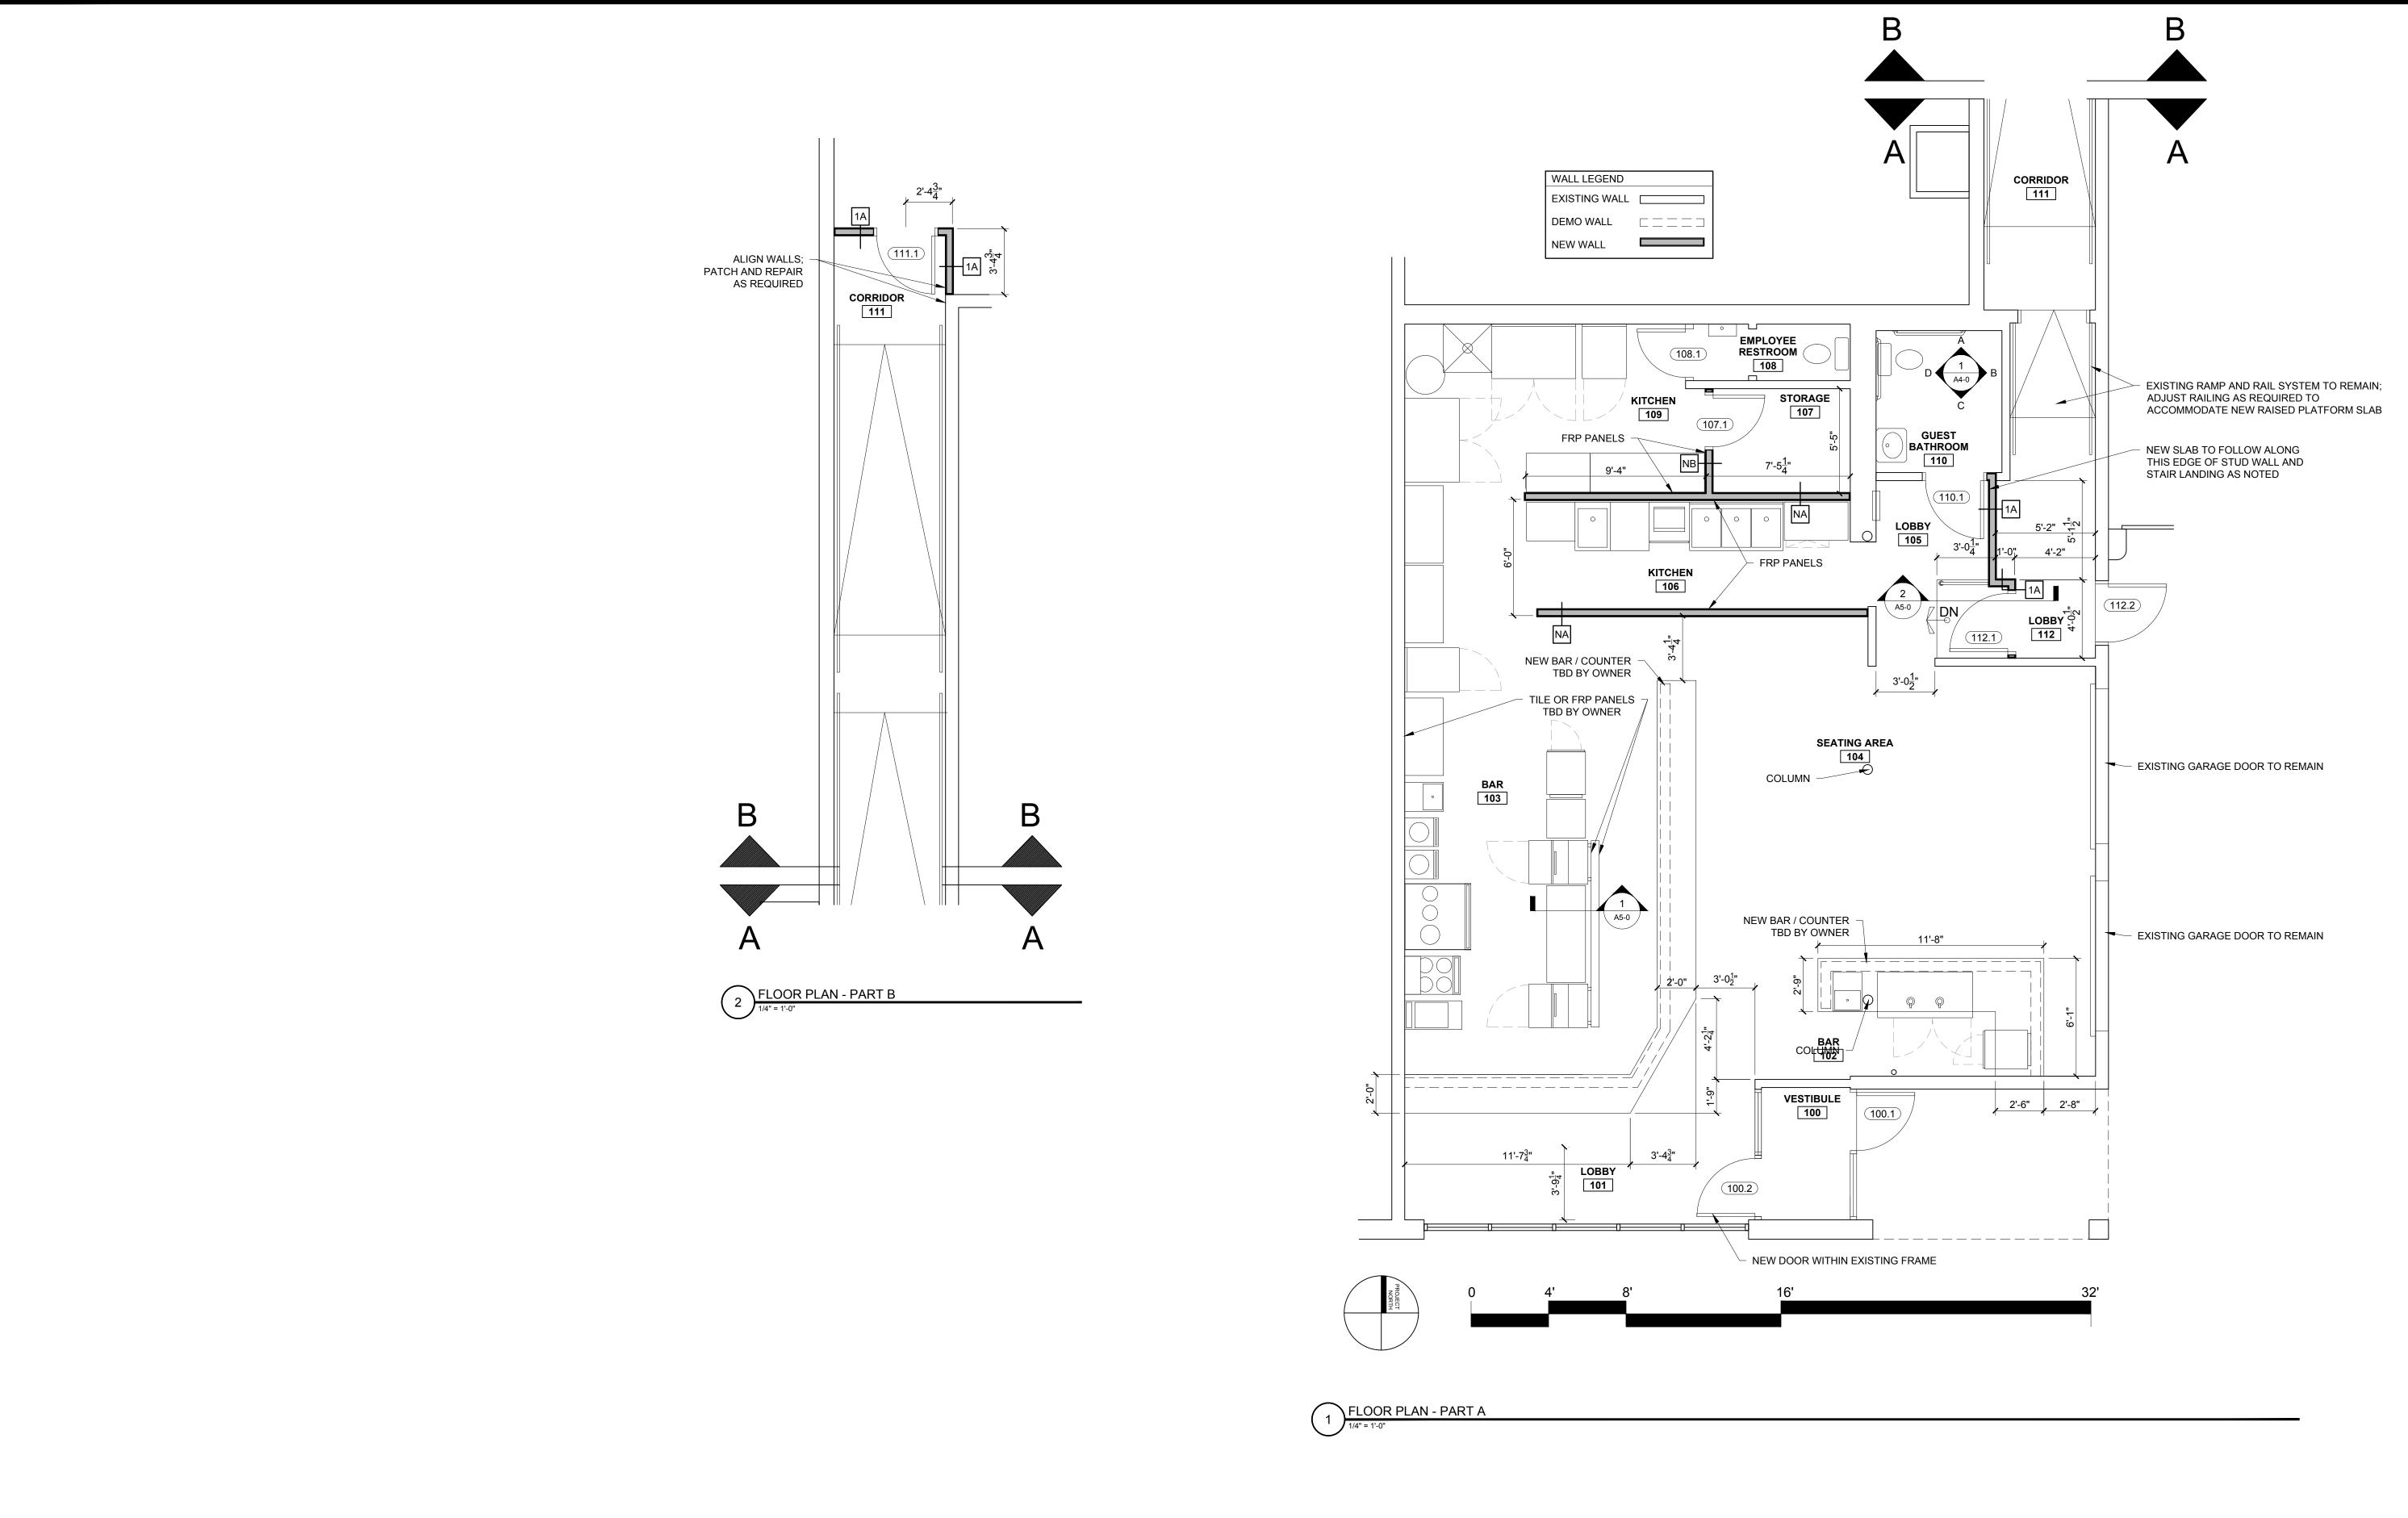

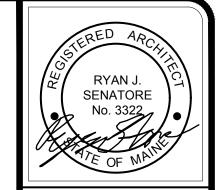

STAURANT FIT-UP WASHINGTON AVENUE PORTLAND, MAINE

59 CONG

ARCHITECTURE 565 CONGRESS STREET PORTLAND, MAINE 04101 207-650-6414 senatorearchitecture.com

CONSULTANTS:


REVISIONS:


DATE: 17, OCTOBER 2016 PROJECT No.

DRAWN BY: JPF, RJS CHECKED BY:

AS NOTED SCALE: SHEET TITLE:

FIRST FLOOR PLAN

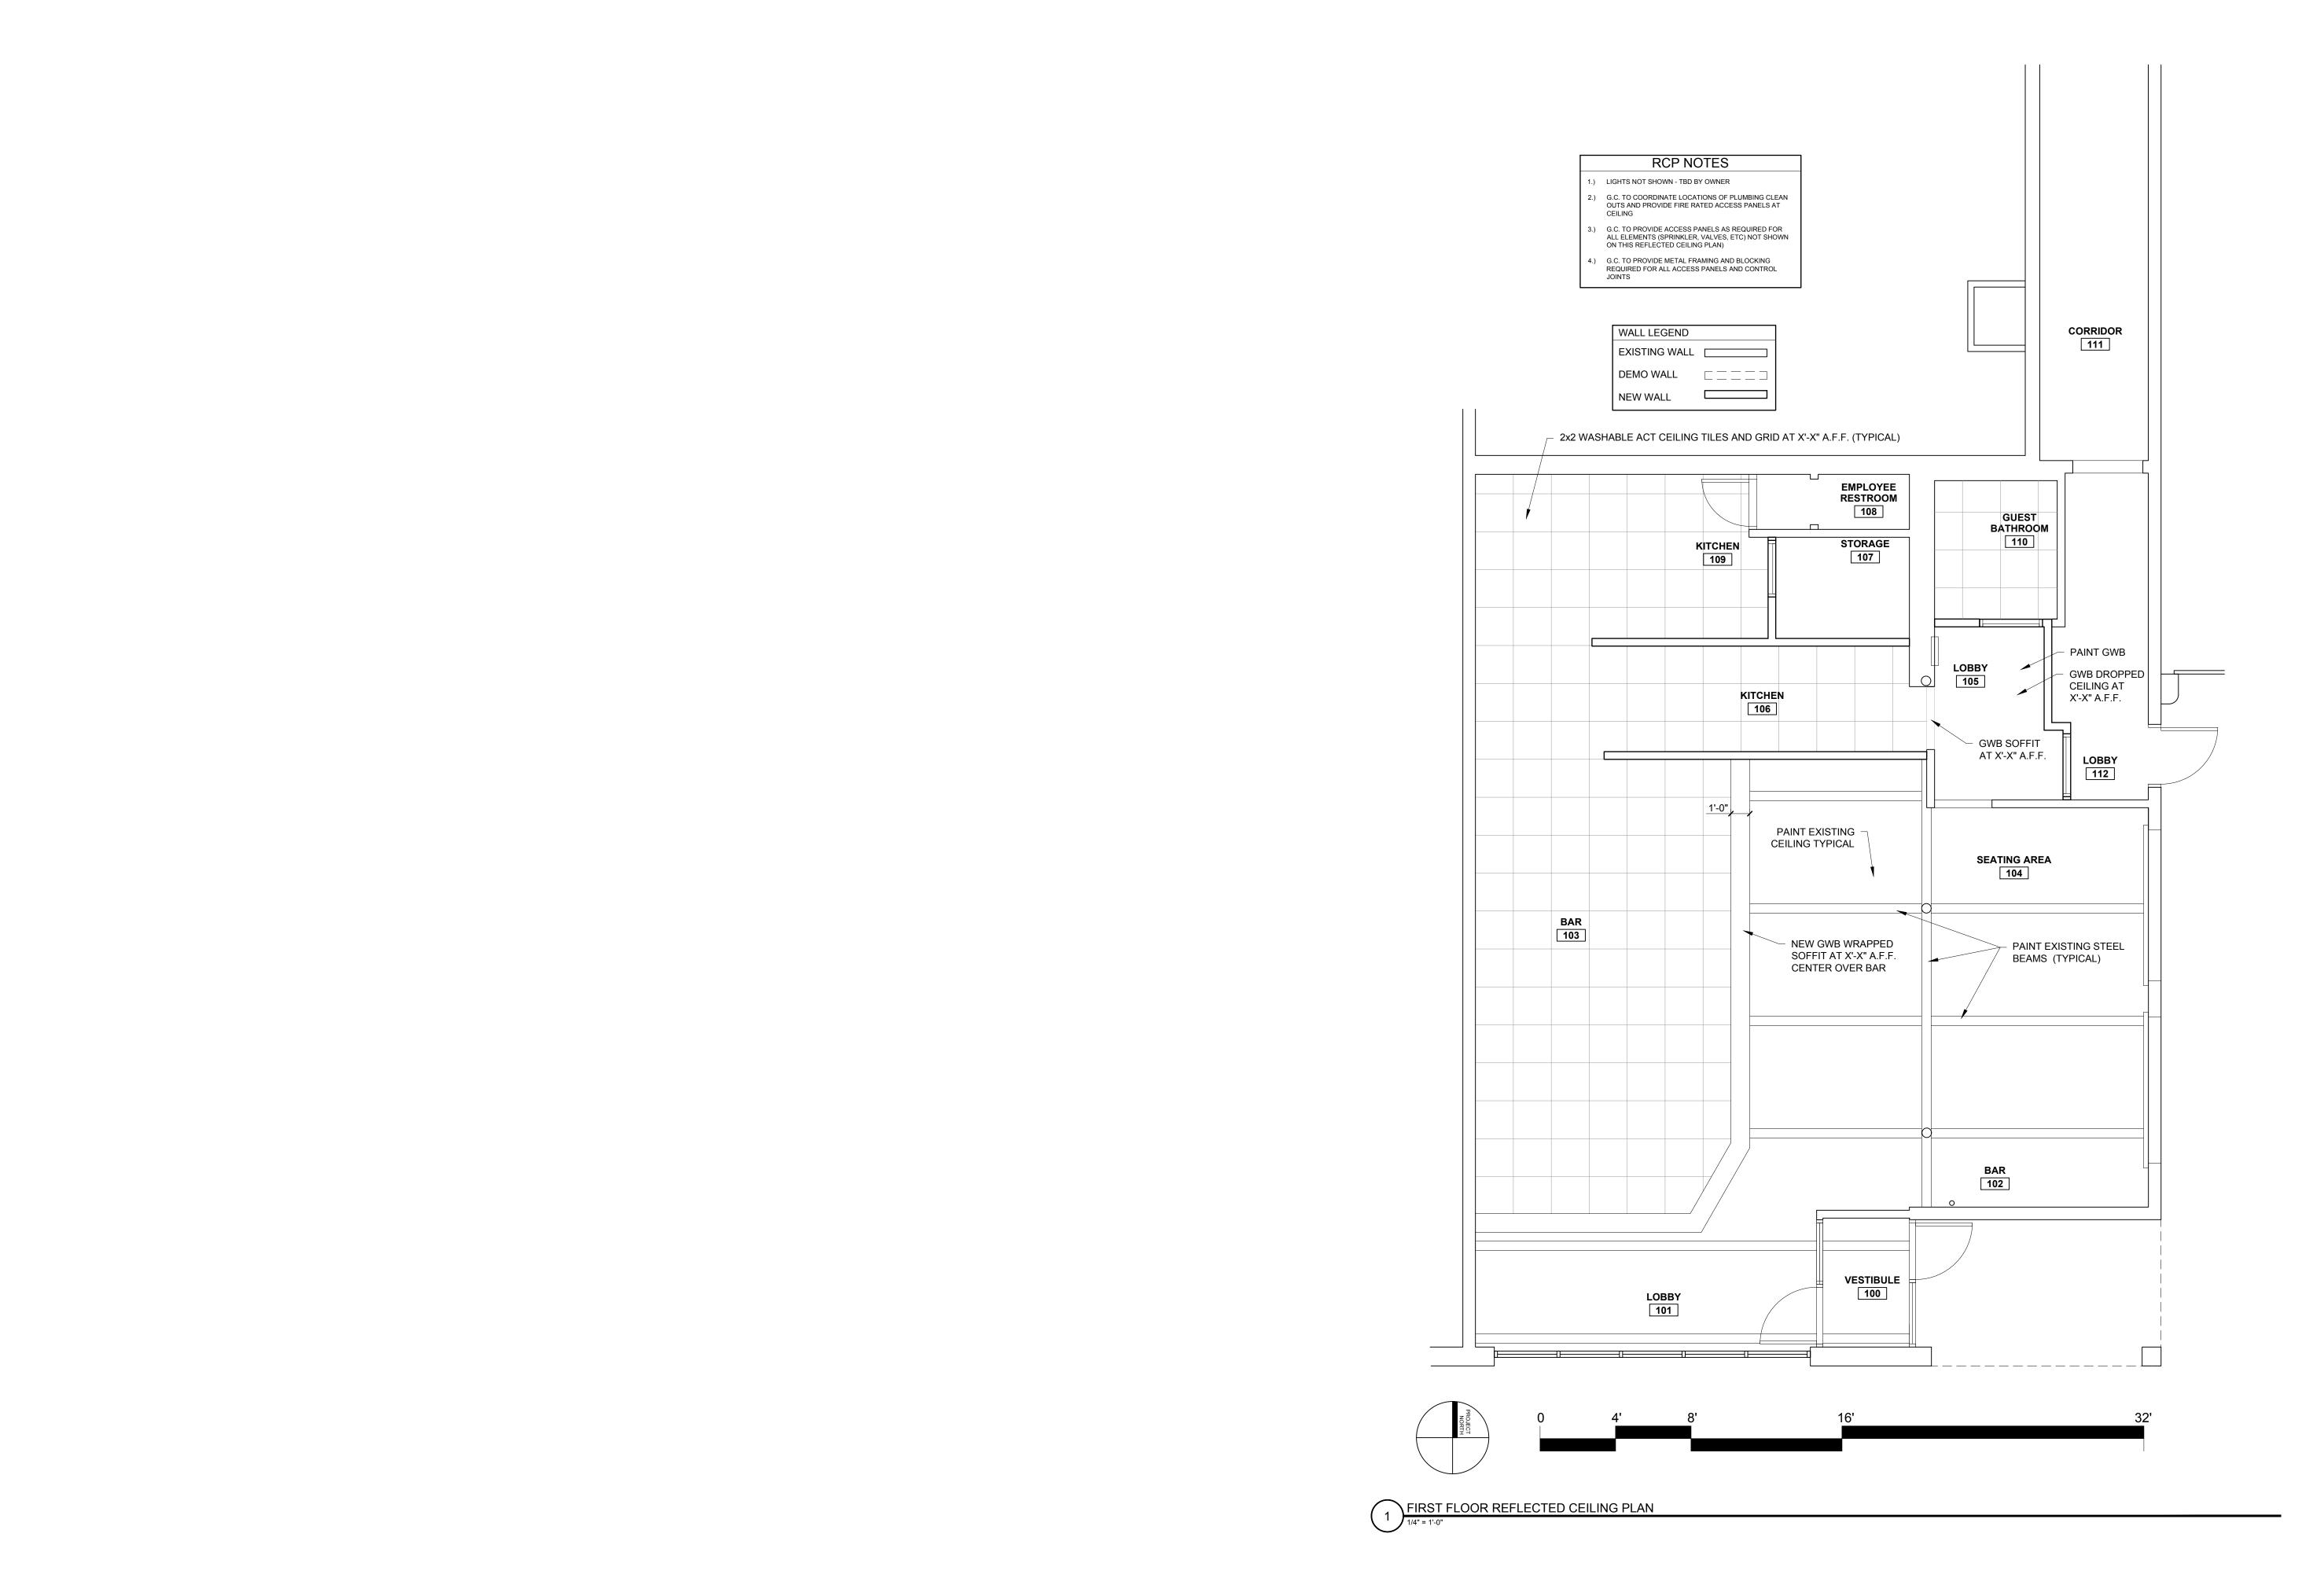

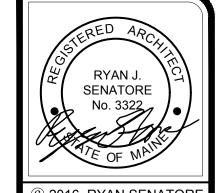

STAURANT WASHINGTON AVENUE PORTLAND, MAINE - RE

CONG ARCHITECTURE
565 CONGRESS STREET
PORTLAND, MAINE 04101
207-650-6414
senatorearchitecture.com

59

CONSULTANTS:

REVISIONS:


DATE: 17, OCTOBER 2016 PROJECT No.

DRAWN BY: JPF, RJS CHECKED BY: AS NOTED


SCALE: SHEET TITLE:

FIRST FLOOR REFLECTED **CEILING PLAN**

	(LOT/(OTO (IV) / II / LI	ANCE SCHEDULE:
#	EQUIPMENT	DIMENSIONS (W x D x H)
#1)	NOODLE BOILER	17.75" x 35.5" x 40.5"
#2)	4 BURNER RANGE	23.625" x 34.5" x 57"
#3)	DOUBLE WOK RANGE	41" x 48" x 36"
#4)	SINGLE STOCK RANGE	17.75" x 20.75" x 24.5"
#5)	PREP LOWBOY 1DR 1	27" x 38.375" x 45.5
#6)	PREP LOWBOY 1DR 2	27" x 38.375" x 45.5"
#7)	HAND SINK	TBD
#8)	METRO RACK SHELF	24" x 48"
#9)	METRO RACK SHELF	24" x 48"
#10)	METRO RACK SHELF	24" x 48"
#11)	SINGLE DOOR REACH-IN	27.25" x 33.75" x 78"
#12)	DOUBLE DOOR REACH-IN	52" x 33.75" x 78"
#13)	PREP SINK	TBD
#14)	DISHWASHER	25.25" x 25.25" x 76.75"
#15)	3 COMPARTMENT SINK	TBD
#16)	ICE MACHINE	39.5" x 23.625" x 33.5"
#17)	DOUBLE DOOR REACH-IN	52" x 33.75" x 78"
#18)	SINGLE DOOR FREEZER	27.25" x 33.75" x 78"
#19)	METRO RACK SHELF	24" x 30"
#20)	BACK BAR REFRIGERATOR	24" x 29.5" x 37.75"
#21)	HAND SINK	TBD
#22)	BACK BAR REFRIGERATOR	24" x 29.5" x 37.75"
#23)	BEER DIPENSER	59" x 28.25" x 37.25
#24)	PREP TABLE	VARIOUS SIZES
#25)	PREP TABLE	24" WIDE

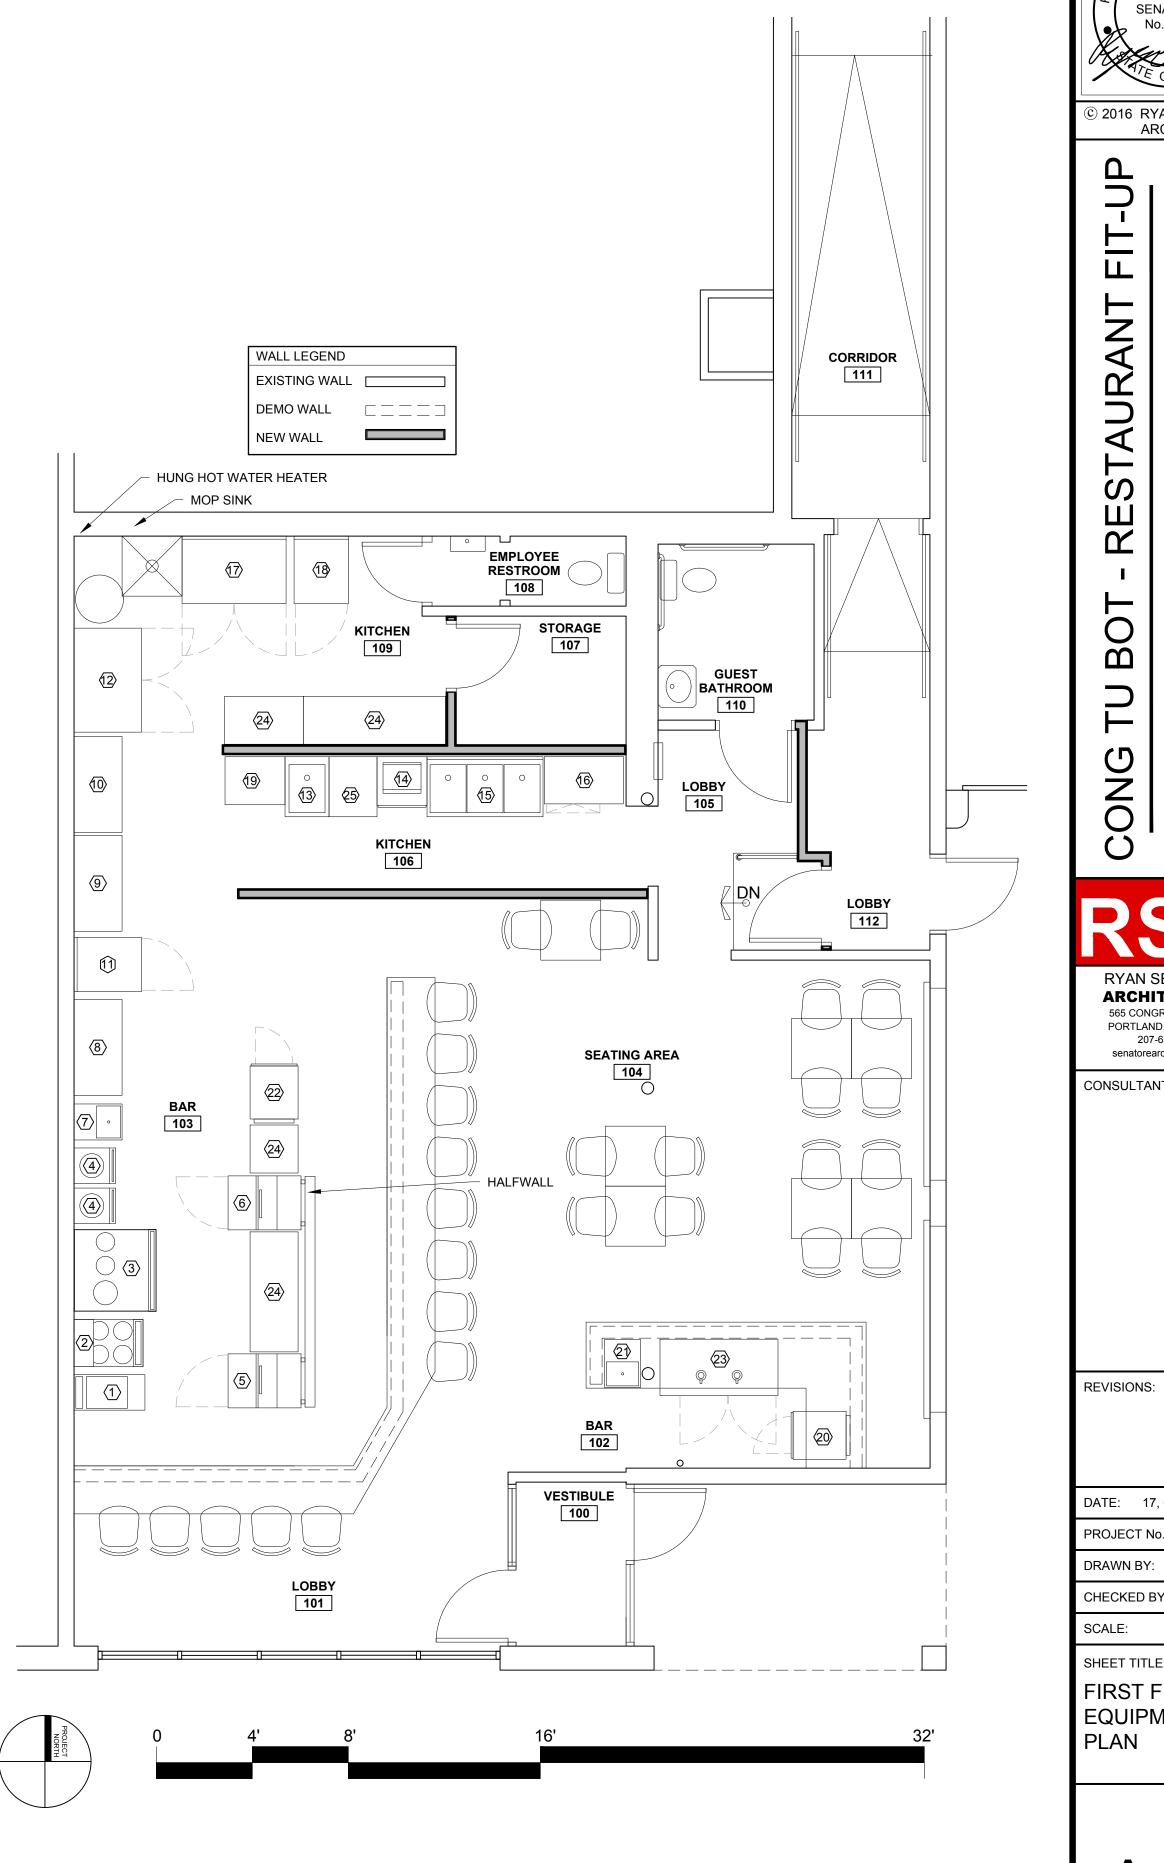

1 FIRST FLOOR EQUIPMENT PLAN

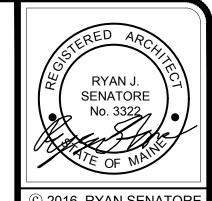

© 2016 RYAN SENATORE ARCHITECTURE

WASHINGTON AVENUE PORTLAND, MAINE

CONG ARCHITECTURE
565 CONGRESS STREET
PORTLAND, MAINE 04101
207-650-6414
senatorearchitecture.com

59

CONSULTANTS:

DATE: 17, OCTOBER 2016


PROJECT No. DRAWN BY: JPF, RJS CHECKED BY:

AS NOTED SHEET TITLE:

FIRST FLOOR EQUIPMENT

REVISIONS: PADDED INSULATION — JACKET ON ALL EXPOSED PIPING BELOW LAVATORY ┌ WALL MOUNTED MIRROR ADA GRAB BARS \neg 5'-0" CLEAR CHECKED BY: 3'-0" ADA GRAB BARS SOAP DISPENSER -─ FLOOR MOUNTED ADA TOILET В D RESTROOM INTERIOR ELEVATIONS

3/8" = 1'-0"

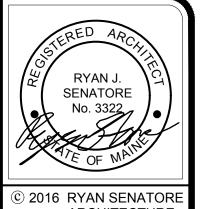

© 2016 RYAN SENATORE ARCHITECTURE

CONG TU BOT - RESTAURANT FIT-UP 59 WASHINGTON AVENUE PORTLAND, MAINE

ARCHITECTURE
565 CONGRESS STREET
PORTLAND, MAINE 04101
207-650-6414
senatorearchitecture.com


CONSULTANTS:


DATE: 17, OCTOBER 2016 PROJECT No. DRAWN BY: JPF, RJS


AS NOTED SCALE:

SHEET TITLE:

INTERIOR **ELEVATIONS**

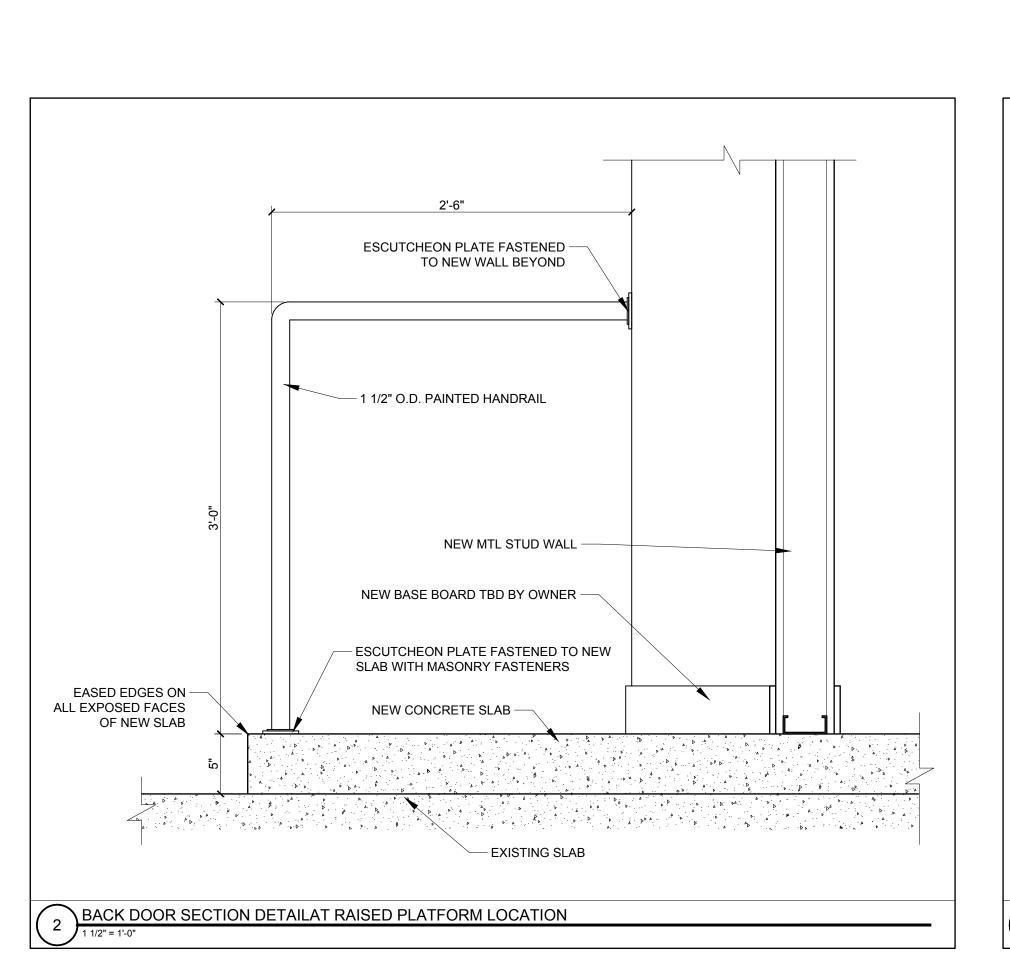

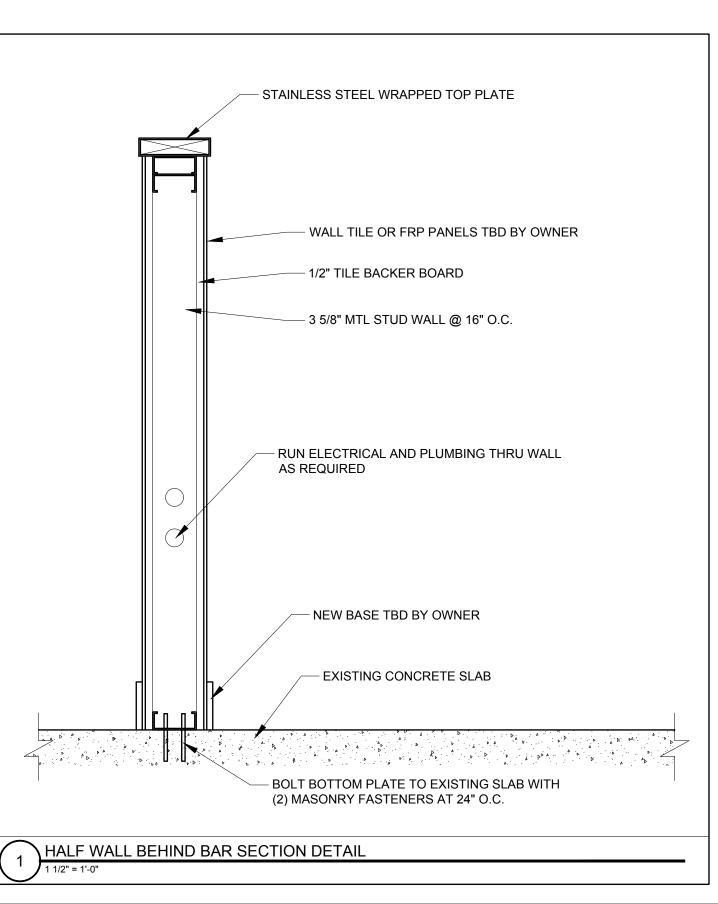

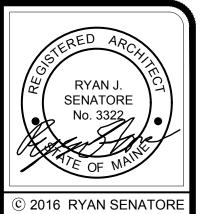

TU BOT - RESTAURANT FIT-UP 59 WASHINGTON AVENUE PORTLAND, MAINE

CONG ARCHITECTURE 565 CONGRESS STREET PORTLAND, MAINE 04101

senatorearchitecture.com

CONSULTANTS:


207-650-6414

REVISIONS:


DATE: 17, OCTOBER 2016 PROJECT No.

DRAWN BY: JPF, RJS CHECKED BY:

AS NOTED SCALE: SHEET TITLE: DETAILS

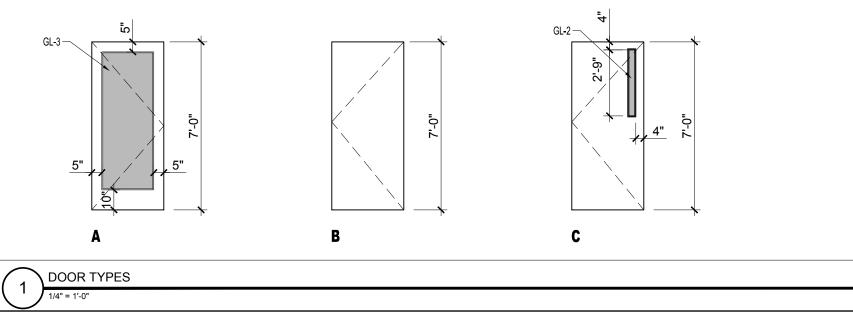

	DOOR SCHEDULE																			
	DOOR FRAME									FRA	AME				GENERAL					
			SIZE									DETAILS	S				HARDWARE KEY MLS - MORTISE LOCK SET NOTE: FOR DOOR HARDWARE SEE DOOR HARDWARE SECTION 02340			
DOOR NO.	TYPE	WIDTH	HEIGHT	THICKNESS	MATERIAL	MATERIAL	INSULATED	TYPE	MATERIAL	THRESHOLD	HEAD	JAMB	SILL	CLOSER	FIRE RATING (MINUTES)		MLS - MORTISE LOCK SET SPECIFICATION SECTION 08710 LS - LOCK SET PR - PRIVACY SET PS - PASSAGE SET LP - LEVER PULL PH - PEEPHOLE LENSE REMARKS			
100.1	EX	-	-	-	-	-	-	-	-	-	-	-	-	•	-	-	-			
100.2	Α	VIF	VIF	VIF	AL	PTD	Υ	-	AL	-	-	-	-	-	-	-	MATCH EXISTING DOOR DIMENSIONS - INSTALL IN EXISTING FRAME			
107.1	В	3'-0"	7'-0"	1-3/4"	WD	PTD	N	2	STL	-	-	-	-	-	-	-				
109.1	EX	-	-	-	-	-	-	-	-	-	-	-	-	-	-	-	-			
110.1	В	3'-0"	7'-0"	1-3/4"	WD	PTD	Υ	2	STL	-	-	-	-	Υ	-	-				
111.1	С	3'-0"	7'-0"	1-3/4"	AL	PTD	Υ	2	STL	AL	-	-	-	Υ	60	-	PANIC HARDWARE			
112.1	С	3'-0"	7'-0"	1-3/4"	AL	PTD	Υ	2	STL	AL	-	-	-	Υ	60	-	PANIC HARDWARE			
112.1	EX	-	-	-	-	-	-	-	-	-	-	-	-	-	-	-	-			

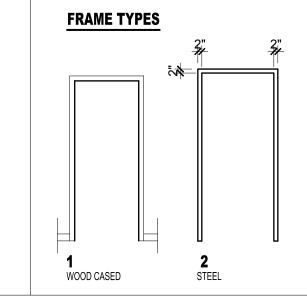

NOTES: 1. EXTERIOR DOOR JAMBS TO BE SEALED TO THIER ROUGH OPENINGS USING LOW EXPANDING FOAM, BACKER ROD OR CAULKING.

GL-5 FIRE RATED GLAZING

2. ALL EXTERIOR DOORS TO BE WEATHER STRIPPED
3. ALL INTERIOR DOORS TO BE SOLID CORE 4. ALL DOOR HARDWARE TO BE 'LEVER' TYPE ACCESSIBLE HARDWARE

	GLAZING SCHEDULE
KEY	GLAZING TYPE
GL-1	INSULATED CLEAR TEMPERED GLAZING
GL-2	FIRE RATED INSULATED GLAZING
GL-3	CLEAR TEMPERED GLASS
GL - 4	CLEAR INSULATED TEMPERED GLASS

- 1.) ALL EXTERIOR GLAZING TO BE LOW-E ARGON FILLED INSULATED GLAZING UNITS
- 2.) FRAME ALL OPENINGS WITH ELEVATIONS

3.) SEAL EXTERIOR DOORS TO ROUGH OPENING WITH LOW EXPANDING FOAM INSULATION - SEE DETAILS

4.) ALL DOOR HARDWARE TO BE 'LEVER' TYPE

5.) ALL EXTERIOR DOORS TO BE WEATHERSTRIPPED



© 2016 RYAN SENATORE ARCHITECTURE

- RESTAURANT WASHINGTON AVENUE PORTLAND, MAINE 59

CONG ARCHITECTURE
565 CONGRESS STREET
PORTLAND, MAINE 04101
207-650-6414
senatorearchitecture.com

CONSULTANTS:

REVISIONS:

DATE: 17, OCTOBER 2016

PROJECT No. DRAWN BY:

AS NOTED SCALE:

CHECKED BY:

SHEET TITLE: DOOR SCHEDULE