

NOTES FOR TYPICAL FLOOR/ROOF SHEATHING DETAIL: 1. SEE SOOO FOR WOOD NOTES FOR SHEATHING REQUIREMENTS.

2. USE APA RATED %-INCH CDX PLYWOOD SHEATHING ON ROOF. USE APA RATED  $\frac{\pi}{4}$ -INCH PLYWOOD SHEATHING ON FLOOR.

3. ATTACH ROOF AND FLOOR DIAPHRAGMS W/8d NAILS SPACED 12" o.c. ALONG


INTERMEDIATE FRAMING MEMBERS AND 6" o.c. AT SUPPORTED EDGES. 4. FLOOR AND ROOF DIAPHRAGMS ARE UNBLOCKED, EXCEPT AS NOTED ON ROOF

FRAMING PLAN. 5. USE SHEATHING CLIPS BETWEEN SHEETS ON ROOF WHERE BLOCKING IS NOT

REQUIRED.

TYPICAL FLOOR/ROOF SHEATHING DETAIL



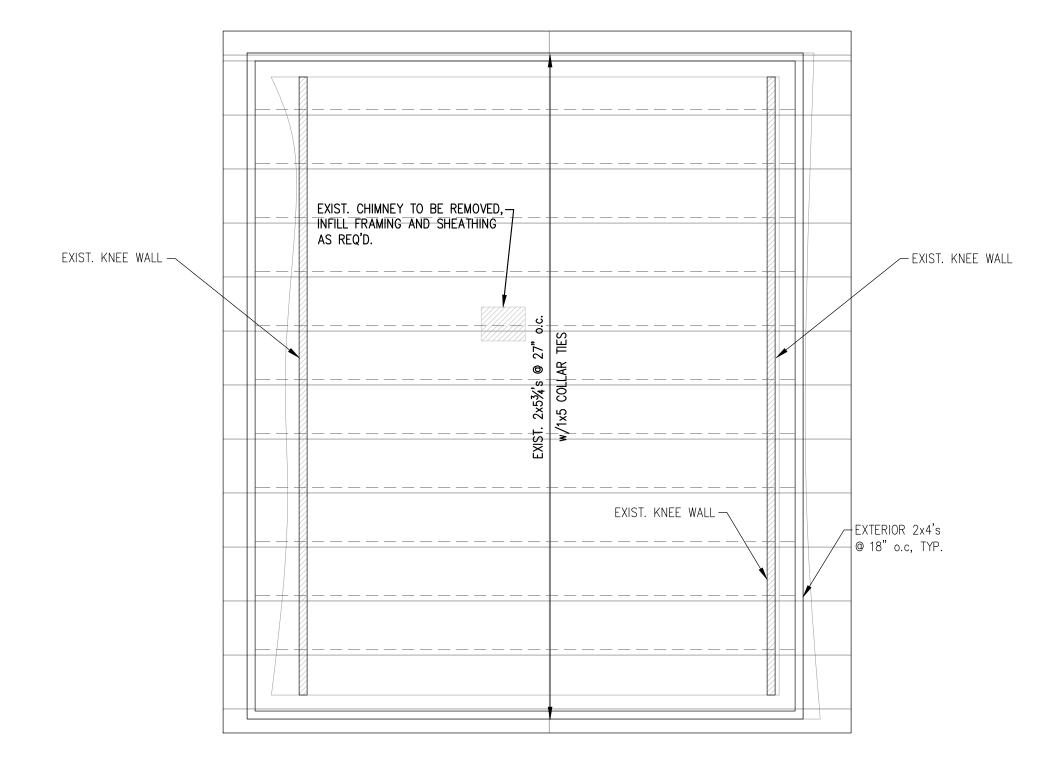

NOTES:

1. PROVIDE SIMPSON JOIST HANGERS AT ALL JOIST ENDS, TYP.

1. PROVIDE SIMPSON JOIST HANGERS AT ALL JOIST ENDS, TYP. WINDOW HEADERS SHALL BE (2)-2x10's, U.N.O, SEE TYPICAL HEADER DETAIL S101

PROVIDE (3) 2x6 STUDS AT ALL COLUMNS AND CORNERS, U.N.O. 4. CONTRACTOR TO VERIFY EXISTING CONDITIONS AND PROPOSED FRAMING AS SHOWN

ON PLAN AND NOTIFY ENGINEER OF ANY DISCREPANCIES PRIOR TO CONSTRUCTION 5. SEE TYPICAL SHEATHING DETAIL THIS DWG.

PLAN LEGEND	
	SHEAR WALL
	BEAM
0	HSS COLUMN
$\boxtimes$	COLUMN FROM ABOVE
	COLUMN BELOW
	COLUMN ABOVE AND BELOW
■	HOLD-DOWN

CASCO BAY ENGINEERING 424 Fore Street Portland, ME 04101 Phone 207.842.2800 Fax 207.842.2828

www.cascobayengineering.com CLIENT:

MIKE D'AMBOISE

93 CUMBERLAND AVE PORTLAND, ME 04101

RENOVATION

CUMBERLAND
93 CUMBERLAND AVE

THIRD FLOOR & FRAMING PLAN

DESIGNED: SJP DRAWN: SJP 9-17-13 PROJECT NUMBER: 13-099

S102

THIRD FLOOR FRAMING PLAN ROOF FRAMING PLAN SCALE: 1/4"=1'-0" SCALE: 1/4"=1'-0"