



STAIR OPENING DIMENSIONS ARE REQ'D

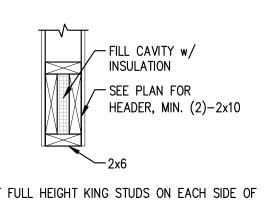

1. PROVIDE # OF FULL HEIGHT KING STUDS ON EACH SIDE OF OPENING TO MATCH ½ OF INTERRUPTED STUDS @ WALL OPENING. MINIMUM (2) FULL HEIGHT KING STUDS @ EACH SIDE OF OPENING. 2. ALL HEADERS SUPPORTED BY MINIMUM OF (1) JACK STUD. 3. WINDOW SILL PLATES MINIMUM (2)-2x6 ON THE FLAT.

TYPICAL HEADER DETAIL

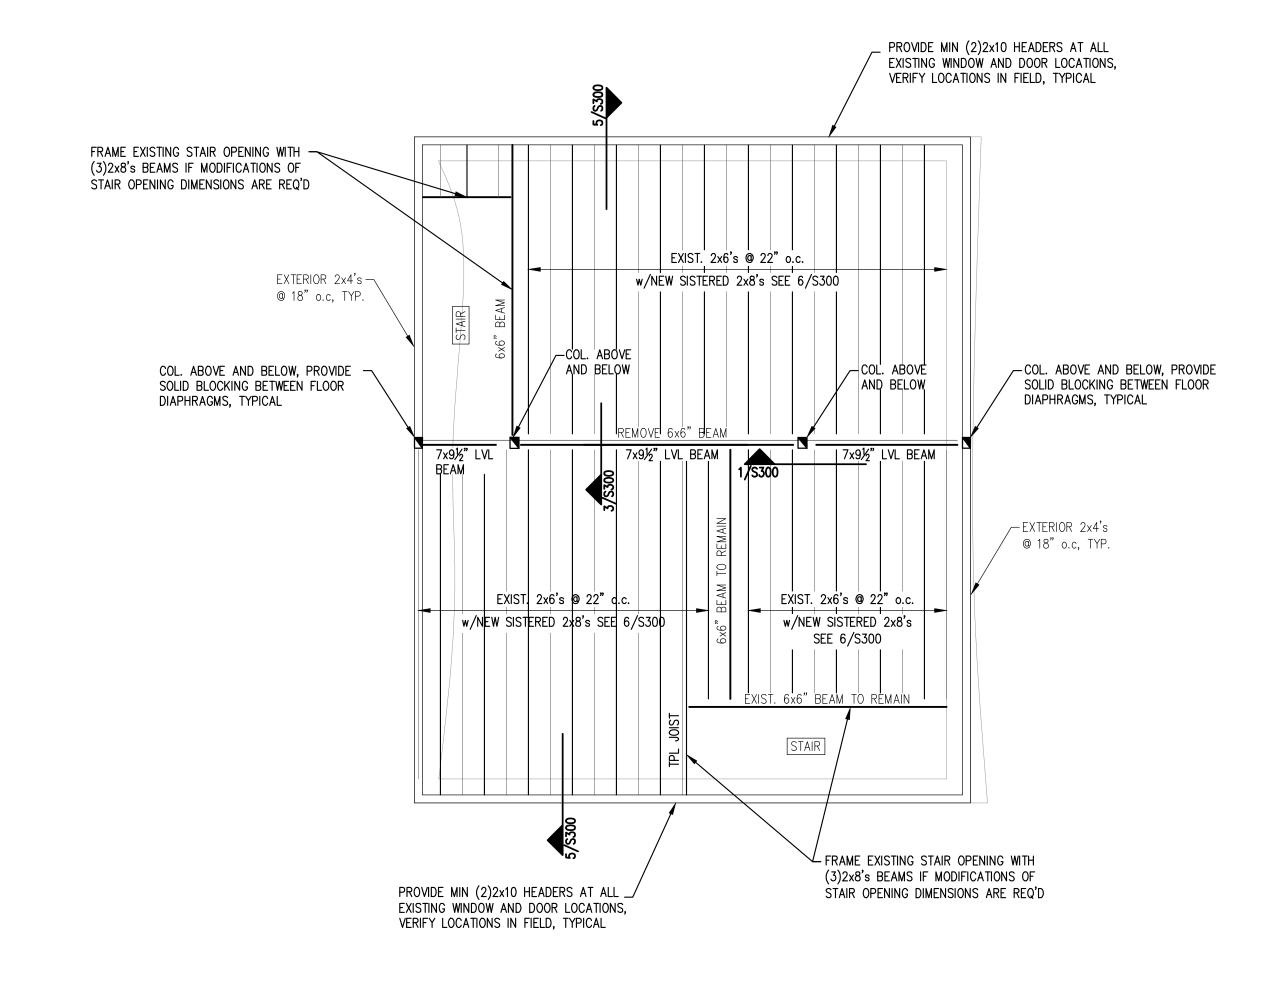

NOTES:

1. PROVIDE SIMPSON JOIST HANGERS AT ALL JOIST ENDS, TYP.

2. WINDOW HEADERS SHALL BE (2)—2x10's, U.N.O, SEE TYPICAL HEADER DETAIL THIS DWG.

3. PROVIDE (3) 2x6 STUDS AT ALL COLUMNS AND CORNERS, U.N.O.

4. CONTRACTOR TO VERIFY EXISTING CONDITIONS AND PROPOSED FRAMING AS SHOWN ON PLAN AND NOTIFY ENGINEER OF ANY DISCREPANCIES

PRIOR TO CONSTRUCTION

5. SEE TYPICAL SHEATHING DETAIL S102

PLAN LEGEND SHEAR WALL HSS COLUMN COLUMN FROM ABOVE

COLUMN BELOW COLUMN ABOVE AND BELOW

SCALE: 1/4"=1'-0" 2

DESIGNED: SJP DRAWN: SJP 9-17-13 PROJECT NUMBER: 13-099

FIRST AND

SECOND FLOOR

FRAMING PLANS

S101

CASCO BAY ENGINEERING

424 Fore Street

Portland, ME 04101 Phone 207.842.2800 Fax 207.842.2828 www.cascobayengineering.com

MIKE D'AMBOISE 93 CUMBERLAND AVE PORTLAND, ME 04101

CLIENT:

RENOVATION

CUMBERLAND ASS CUMBERLAND AND

BUILDI

FIRST FLOOR FRAMING PLAN SECOND FLOOR FRAMING PLAN SCALE: 1/4"=1'-0"

HOLD-DOWN

SHEET TITLE: