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DATE: JULY 26, 2016

PROJECT No. 1626


DRAWN BY: RJS / RRT

CHECKED BY: RJS

SCALE: AS NOTED

SHEET TITLE:
DOOR SCHEDULE

A7-0

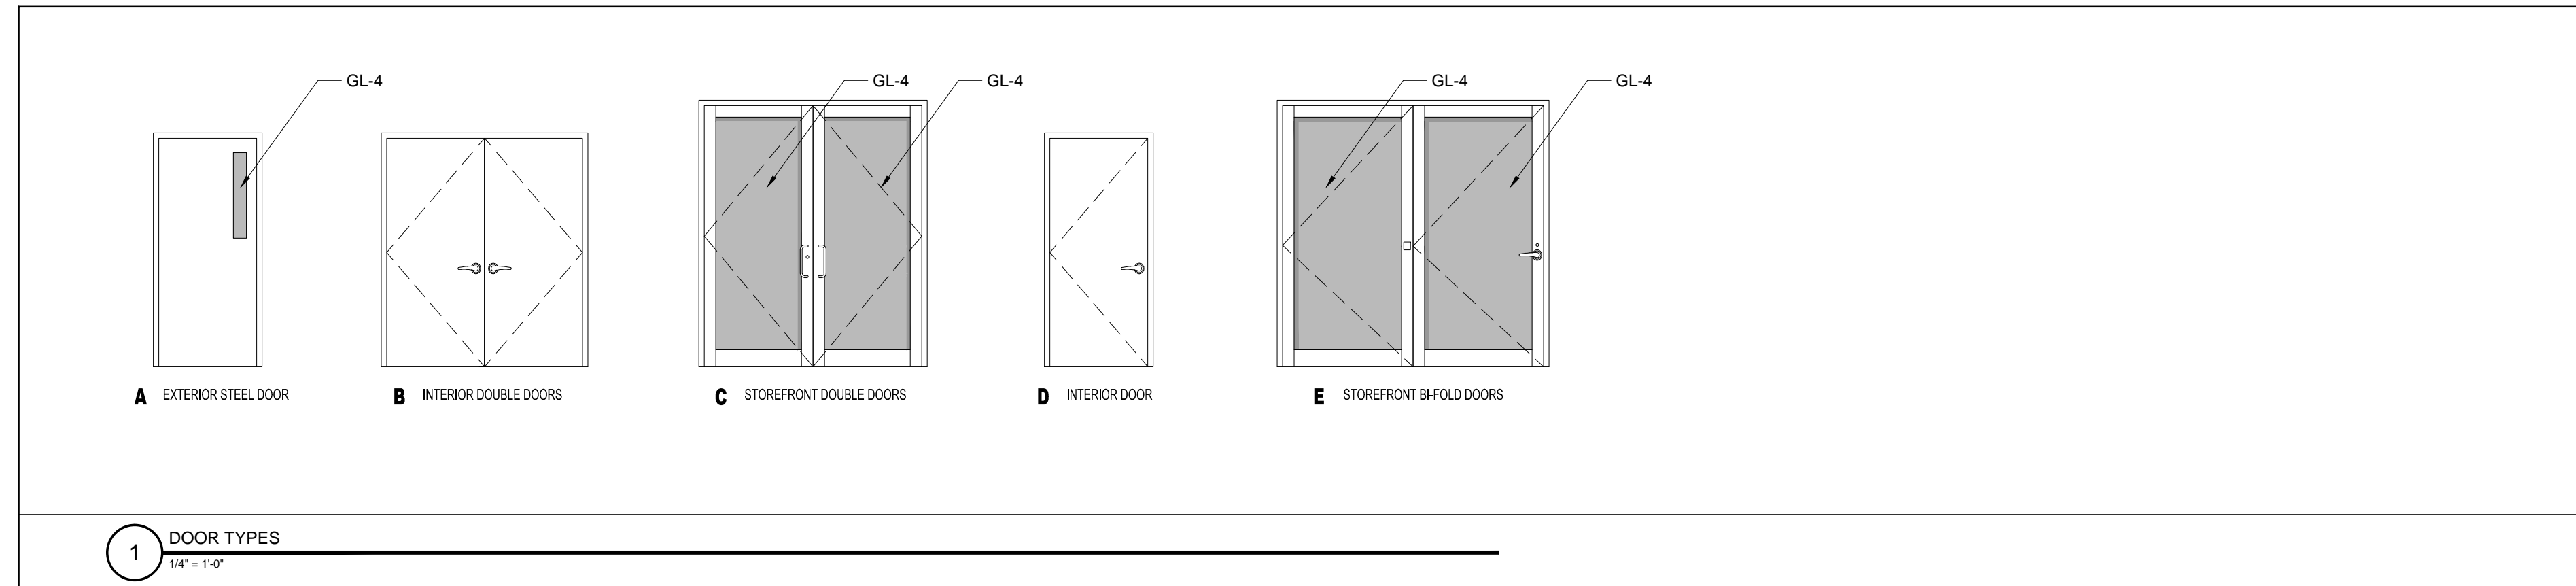


1 DOOR TYPES
1/4" = 1'-0"

DOOR SCHEDULE																		
DOOR NO.	TYPE	DOOR				FRAME						GENERAL						
		WIDTH	HEIGHT	THICKNESS	MATERIAL	FINISH	INSULATED	TYPE	MATERIAL	THRESHOLD	DETAILS			CLOSER	FIRE RATING (MINUTES)	HARDWARE KEY	SCHEDULE KEY	
											HEAD	JAMB	SILL					LS - LOCK SET
100.1	A	3'-0"	7'-0"	-	-	-	-	-	-	-	-	-	-	-	Y	-	-	PAINTED STEEL HIM THERMALLY BROKEN DOOR AND FRAME. PANIC HARDWARE
100.2	B	6'-0"	7'-0"	-	-	-	-	-	-	-	-	-	-	Y	45	-	-	
101.1, 102.1, 103.1, 104.1, 105.1	C	6'-8"	8'-0"	-	-	-	-	-	-	-	-	-	-	-	-	-	-	OLD CASTLE - FG 3000 THERMAL ENTRANCE DOORS WITH EXTERIOR PULLS
101.2, 102.2, 103.2, 104.2, 105.2	D	3'-0"	7'-0"	-	-	-	-	-	-	-	-	-	-	Y	45	-	-	INTERIOR DOORS WITH ADA HARDWARE
101.3, 105.3	E	8'-0"	8'-0"	-	-	-	-	-	-	-	-	-	-	-	-	-	-	OLD CASTLE - FG 3000 THERMAL BI-FOLD ENTRANCE DOORS WITH EXTERIOR PULL AND LATCH HARDWARE FOR BOLLARD CONNECTION
106.1	D	3'-0"	7'-0"	-	-	-	-	-	-	-	-	-	-	Y	45	-	-	INTERIOR DOORS WITH ADA HARDWARE
107.1	D	3'-0"	7'-0"	-	-	-	-	-	-	-	-	-	-	N	45	-	-	INTERIOR DOORS WITH ADA HARDWARE, NO CLOSER

DOOR NOTES:

- 1.) ALL EXTERIOR GLAZING TO BE LOW-E ARGON FILLED INSULATED GLAZING UNITS
- 2.) FRAME ALL OPENINGS WITH ELEVATIONS
- 3.) SEAL EXTERIOR DOORS TO ROUGH OPENING WITH LOW EXPANDING FOAM INSULATION - SEE DETAILS
- 4.) ALL DOOR HARDWARE TO BE 'LEVER' TYPE
- 5.) ALL EXTERIOR DOORS TO BE WEATHERSTRIPPED

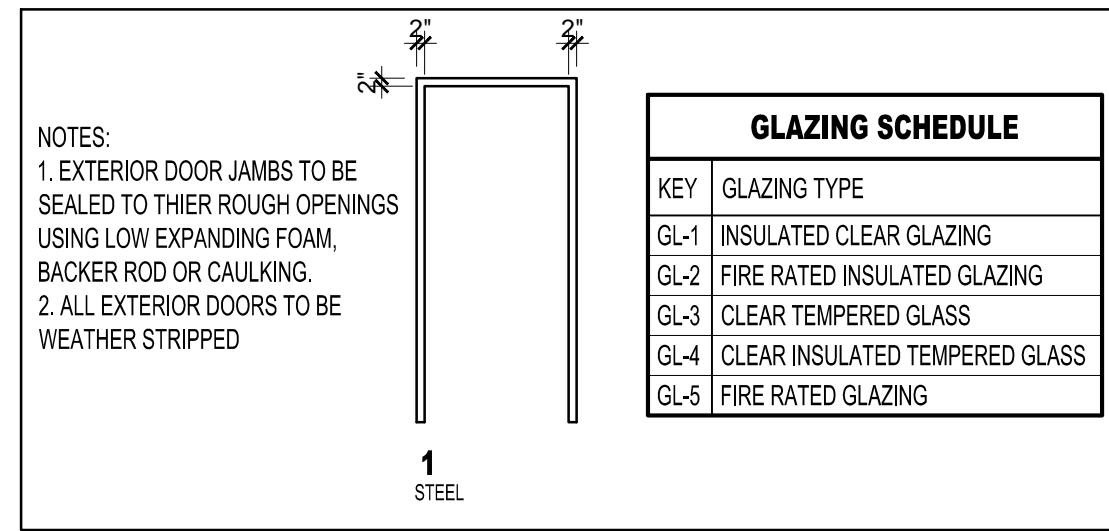

NOTES:
1. EXTERIOR DOOR JAMBS TO BE SEALED TO THEIR ROUGH OPENINGS USING LOW EXPANDING FOAM, BACKER ROD OR CAULKING.
2. ALL EXTERIOR DOORS TO BE WEATHER STRIPPED