



EXTERIOR PROJECTION DETAIL AT APARTEMENT ENTRY

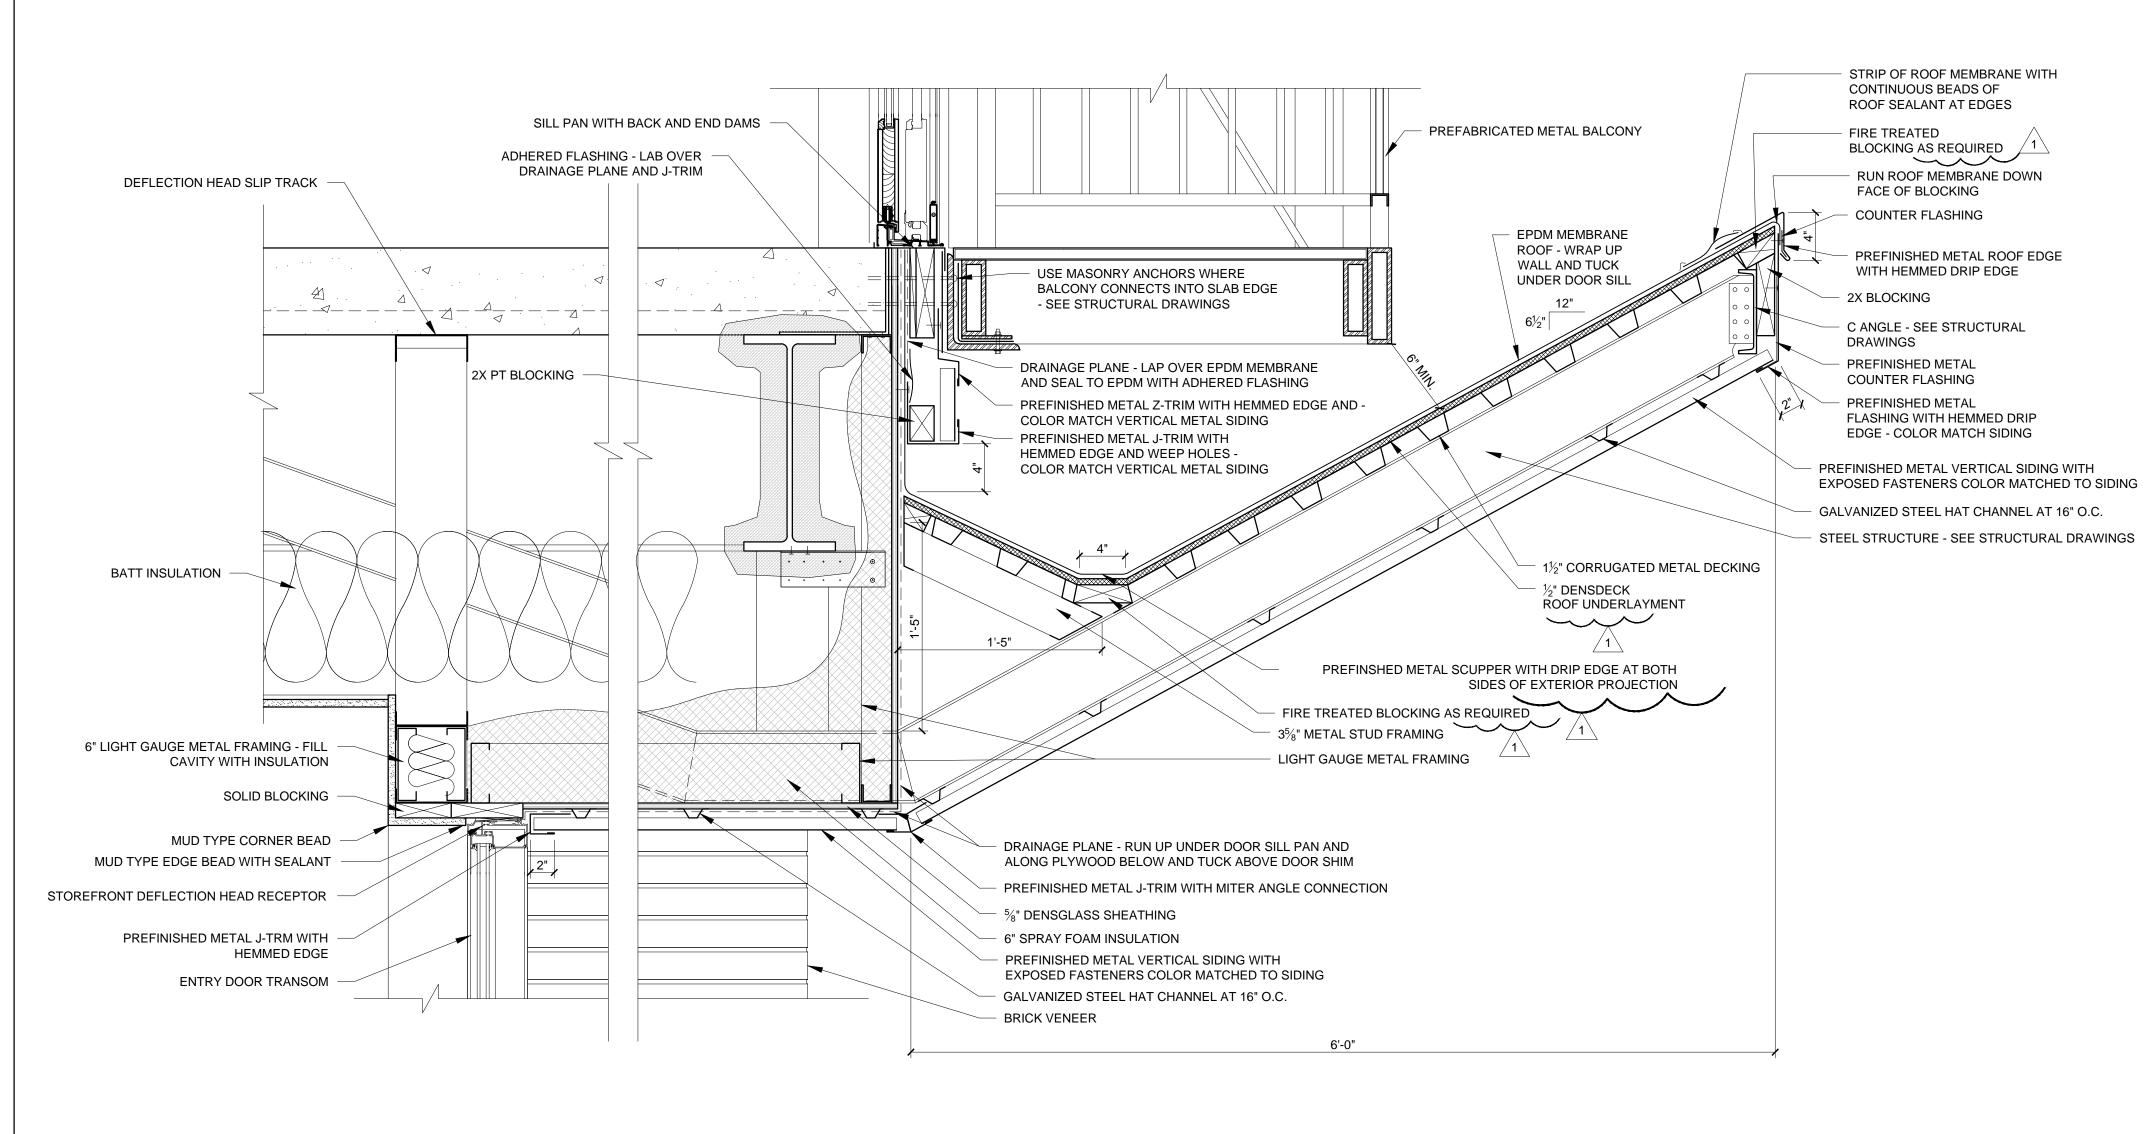

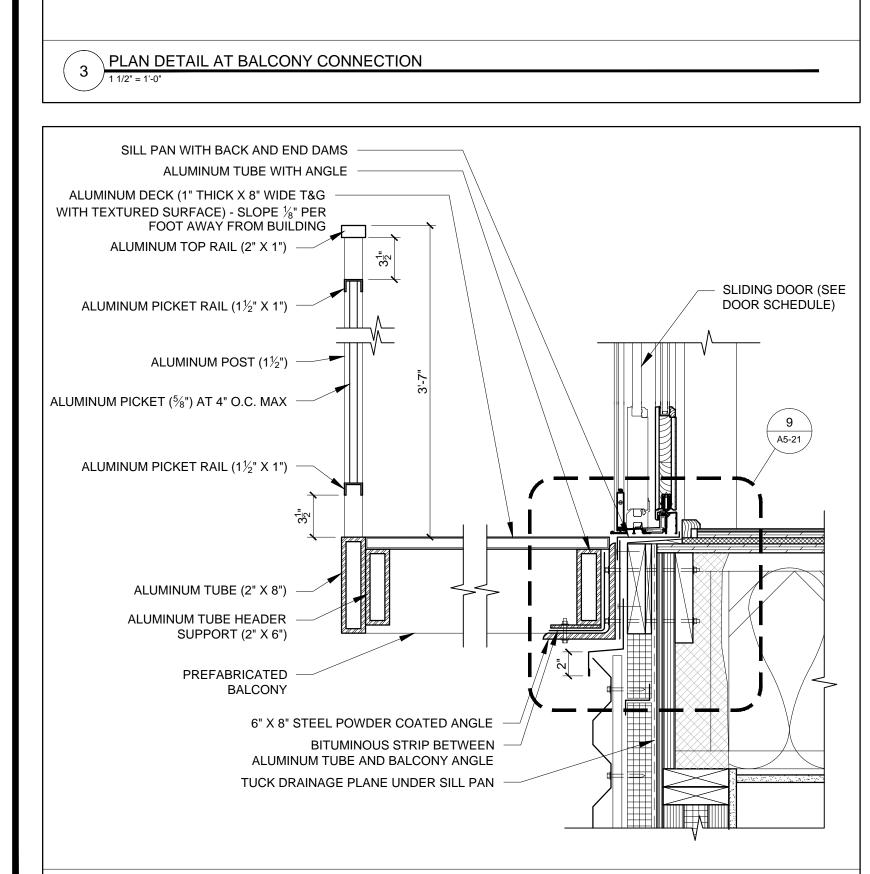

SHIM, SEALANT

PREFINISHED METAL J-TRIM

WITH HEMMED EDGE AND -

(SEE ELEVATION FOR SIDING TYPE)

COLOR MATCH SIDING

SECTION DETAIL AT BALCONY CONNECTION

AND BACKER ROD

RIGID INSULATION WITH HORIZONTAL

Z-FURRING (NOTCH AROUND T-PLATE)

- GALVANIZED STEEL T-PLATE - SEE


ROD AND CLEVIS BY PRE-MANUFACTURED

STRUCTURAL DRAWINGS

(CONTINUOUS AROUND T-PLATE)

SEALANT AND BACKER ROD

BALCONY PROVIDE

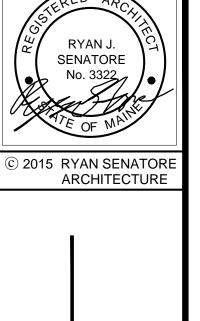

MUD TYPE CORNER BEAD

MUD TYPE EDGE BEAD WITH SEALANT

DRAINAGE PLANE AND UNDER DOOR SHIM

SHIM, SEALANT AND BACKER ROD

PREFINISHED METAL J-TRIM WITH

HEMMED EDGE - COLOR MATCH

PREFINISHED METAL VERTICAL

COLOR MATCHED TO SIDING

SIDING WITH EXPOSED FASTENERS

VERTICAL METAL SIDING

ADHERED FLASHING - LAP OVER

THERMALLY BROKEN

STOREFRONT DOOR

2X BLOCKING

APARTMENTS 89 ANDERSON STREE

RYAN SENATORE
ARCHITECTURE
565 CONGRESS STREET
SUITE 304
PORTLAND, MAINE 04101

senatorearchitecture.com
CONSULTANTS:

STRUCTURAL: Structural Integrity 77 Oak Street Portland, ME 04101 207-774-4614

207-650-6414

REVISIONS:

1 REVISION #1 - 10/16/15

PROJECT No. 1415

DRAWN BY: RRT / RJ

CHECKED BY: RJ

DATE: AUGUST 12, 201

SCALE: AS NOTED
SHEET TITLE:

DETAILS

A5-14