

**HEADER FRAMING PLAN**

HEADERS SUPPORTING LEVEL 3	R.O. SPAN	HEADER TO USE:
L < 3'-6"		DHL 2x8 HDR
3'-6" < L < 6'-6"		TRIPLE 2x10 HDR
L > 6'-6"		SEE PLAN

HEADERS SUPPORTING LEVEL 4	R.O. SPAN	HEADER TO USE:
L < 3'-6"		DHL 2x8 HDR
3'-6" < L < 6'-6"		TRIPLE 2x10 HDR
L > 6'-6"		SEE PLAN

HEADERS SUPPORTING ROOF	R.O. SPAN	HEADER TO USE:
L < 3'-6"		DHL 2x8 HDR
3'-6" < L < 6'-6"		TRIPLE 2x10 HDR
L > 6'-6"		SEE PLAN

\* UNLESS NOTED ON PLAN

**FRAMING PLAN SYMBOLS KEY**

□	WOOD POST
○	STEEL COLUMN
⊗	NUMBER OF WOOD STUDS IN POST BELOW
A	COLUMN ABOVE THIS LEVEL
C	COLUMN CONTINUOUS THROUGH THIS LEVEL
↔	JOIST BEARING
— —	CONTINUOUS JOIST WITH INTERMEDIATE BEARING
— —	FLUSH FRAMED JOIST BEARING WITH HANGER
— —	WOOD STUD BEARING WALL BELOW
— —	SHEAR WALL
—X—	NUMBER OF TRIM STUDS UNDER HEADER
—X—	NUMBER OF KING STUDS ADJACENT TO HEADER

**LEGEND**

---	DROPPED BEAM
—	FLUSH BEAM


ALL FLOOR TRUSSES TO BE DESIGNED FOR A LIVE LOAD DEFLECTION LESS THAN L/600.

LAYOUT FLOOR TRUSSES TO AVOID CONFLICTS WITH PLUMBING (SHOWERS, TUBS, TOILETS AND MEP SHAFTS)

**THIRD FLOOR FRAMING PLAN**

- NOTES:
- SEE SHEET S1.0 FOR GENERAL STRUCTURAL NOTES
  - FLOOR SHEATHING SHALL BE 3/4" T&G SHEATHING. SEE GEN NOTES FOR MORE INFO.
  - ALL WOOD COLUMNS IN 2x6 WALLS SHALL BE (3) 2x6 AND IN 2x4 WALLS SHALL BE (3) 2x4 UNO.
  - ALL HEADERS ARE DROPPED UNO.
  - ALL BEAMS ARE FLUSH UNO.
  - ALL WINDOW HEADERS ARE PER SCHEDULE ON THIS SHEET

SCALE: 1/8" = 1'-0"

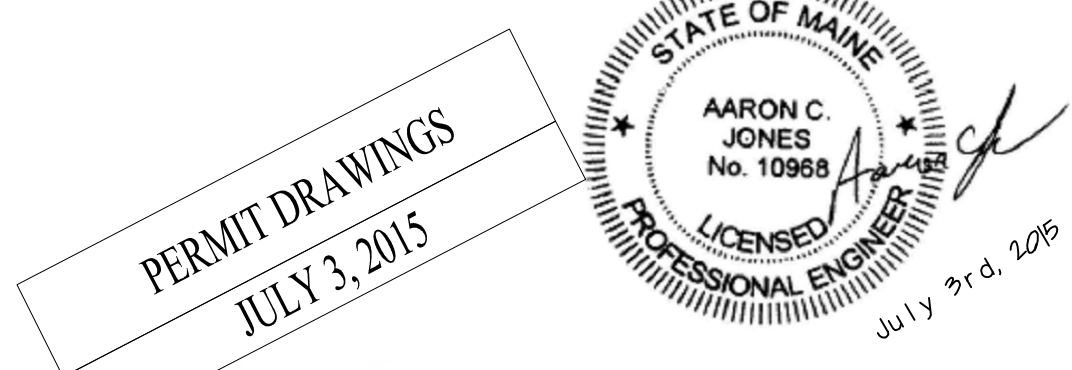

PERMIT DRAWINGS  
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REVISIONS:

DATE: 07/03/2015

PROJECT No.

DRAWN BY: BDH

CHECKED BY: ACJ

SCALE: 1/8" = 1'-0"

SHEET TITLE:

THIRD FLOOR FRAMING PLAN

**S1-3**