

3.) G.C. TO CONFRIM ALL R.O. FRAMING DIMENSIONS INDICATED AROUND BUILT IN ELEMENTS SUCH AS TUB/SHOWER UNITS, SHOWER BASES, ETC. WITH PRODUCT CUT SHEETS AND

4.) PARTITON FRAMING, MECHANICAL, PLUMBING AND

5.) SEE A6 SERIES DRAWINGS FOR STAIR INFORMATION

ELECTRICAL ELEMENTS TO ACCOMMODATE AND WORK AROUND POCKET DOOR 'IN-WALL' ASSEMBLIES

INSTALLATION INSTRUCTIONS

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ARCHITECTURE

**MUNJOY** 

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DCBA EF


SITE KEY PLAN REVISIONS: 1 REVISION #1 - 03/05/14


DATE: DECEMBER 13, 201

PROJECT No. RJS / RR DRAWN BY: CHECKED BY:

SCALE: AS NOTE

SHEET TITLE: **BUILIDNG D** GROUND FLOOR PLAN

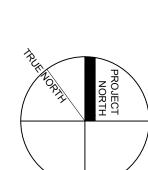

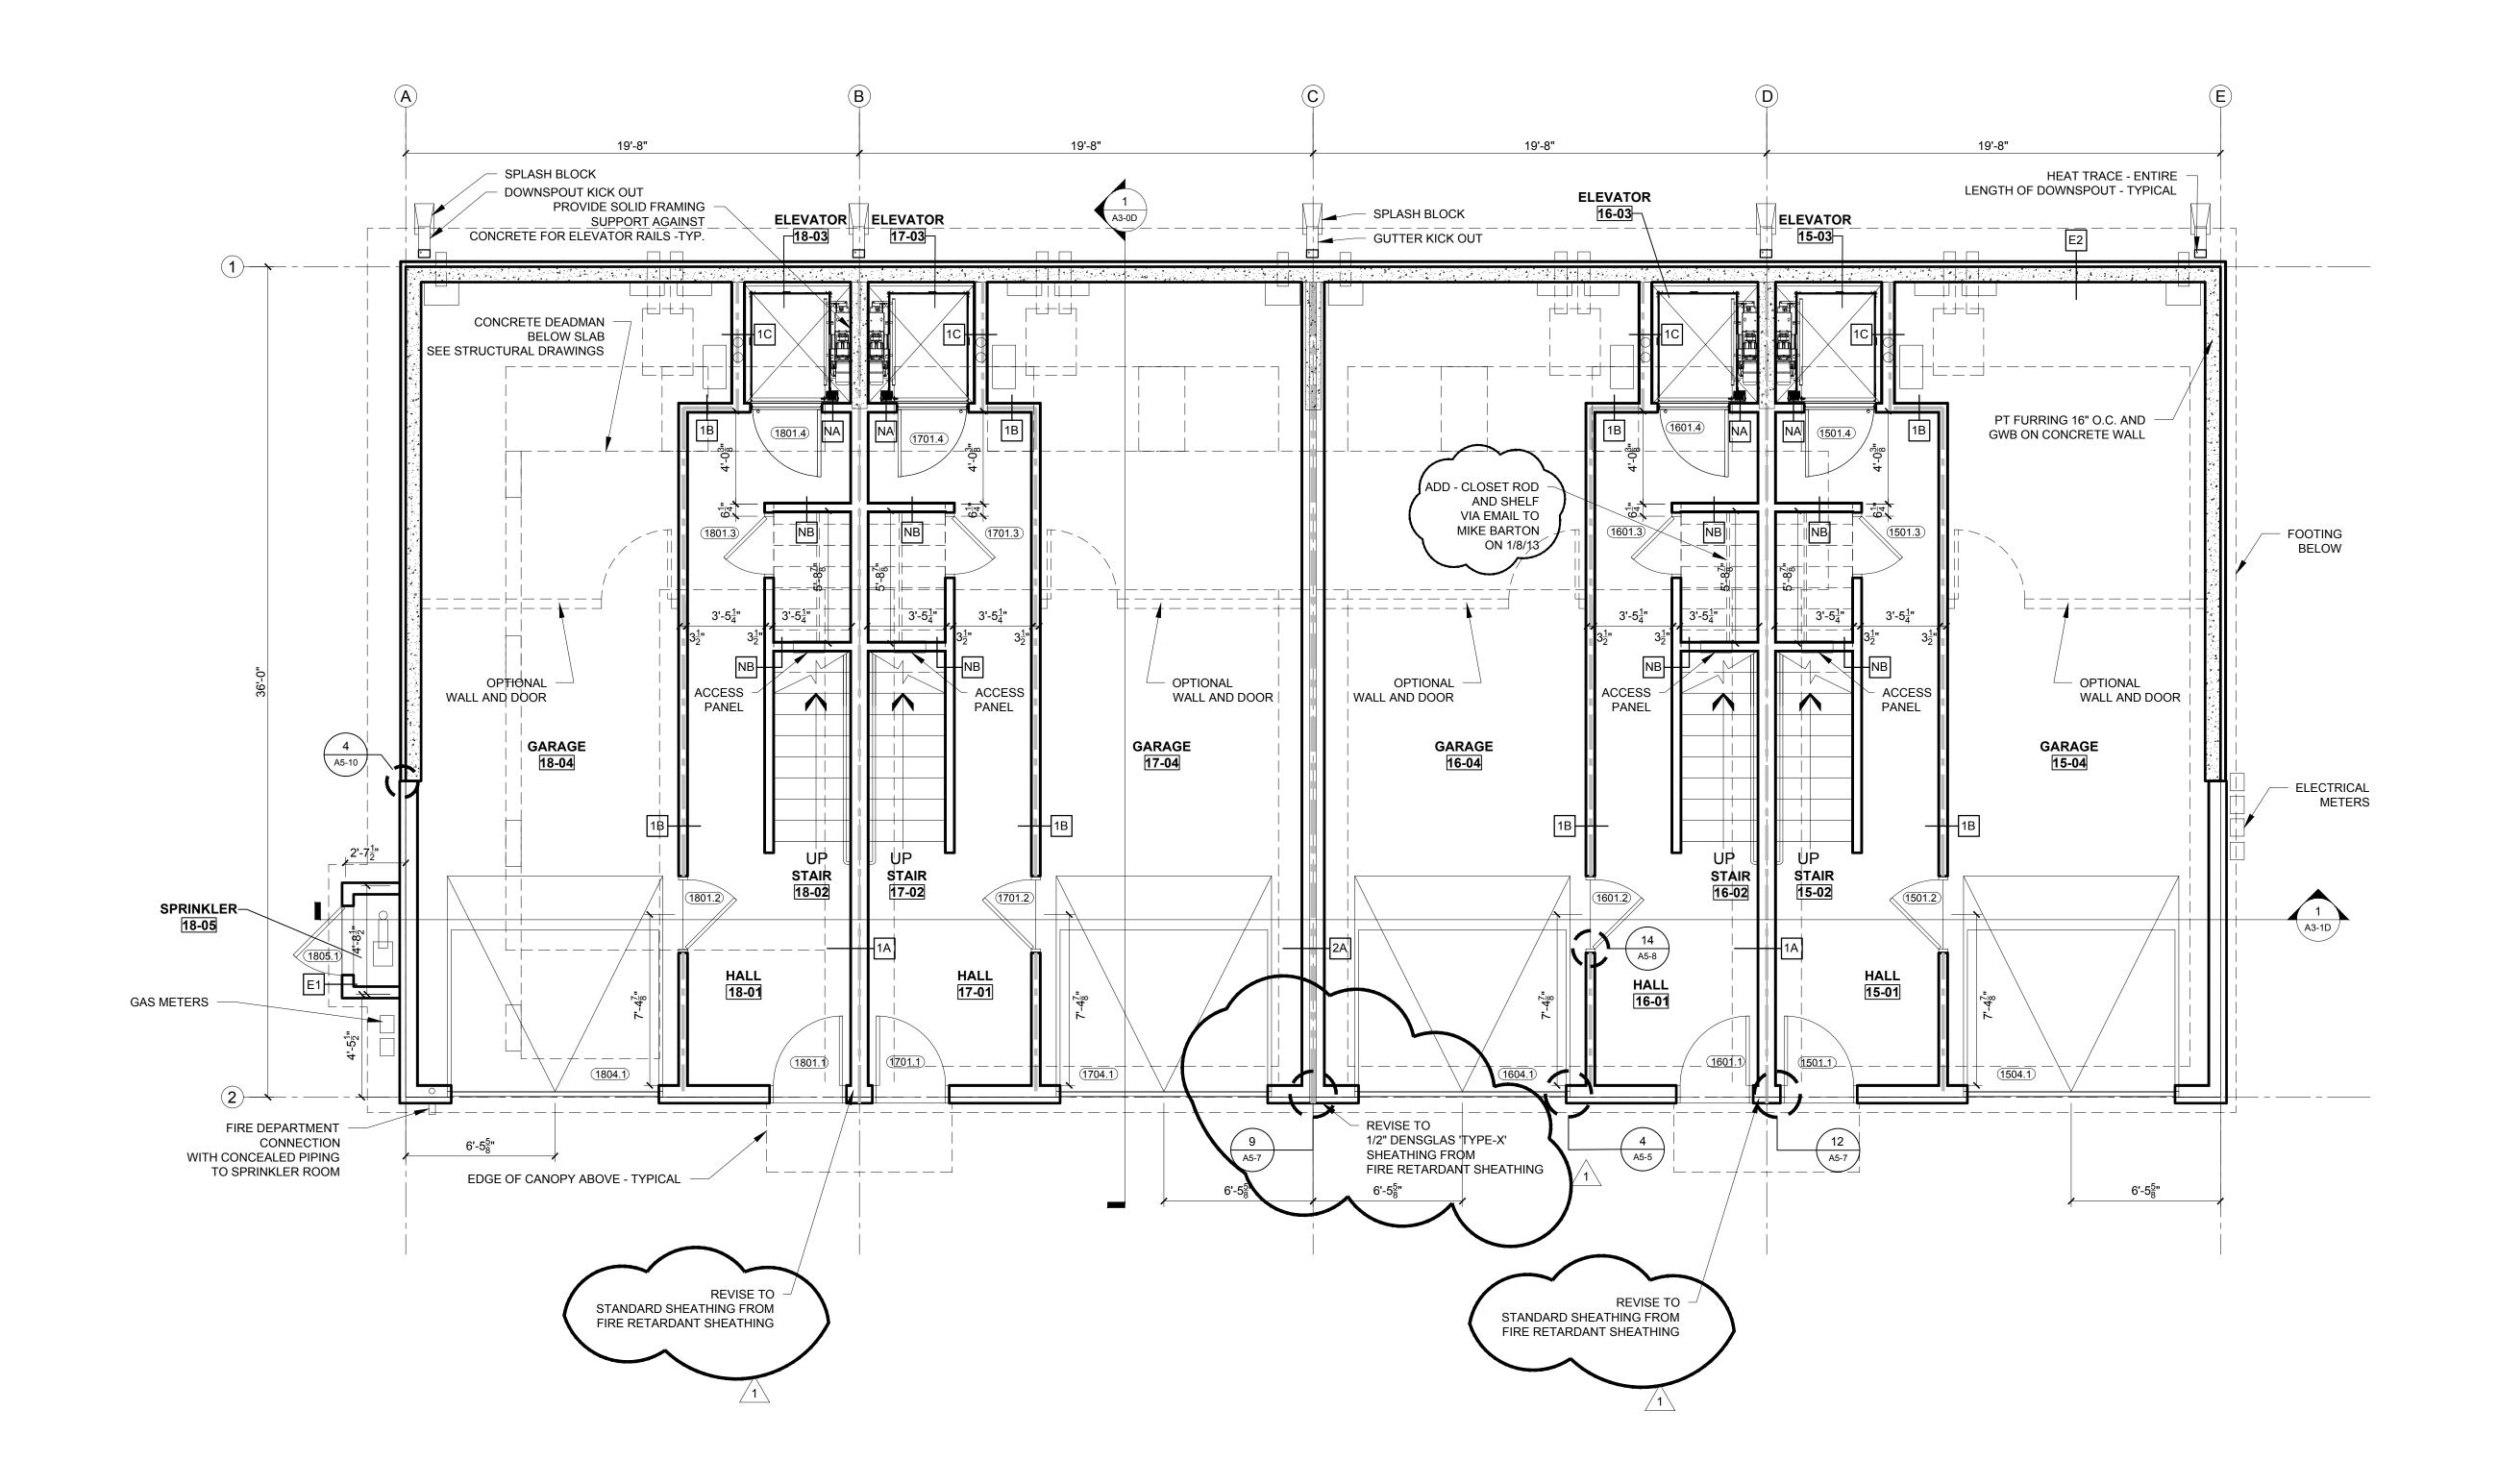

GROUND FLOOR PLAN

SCALE: 1/4" = 1'-0"