

(SEE STRUCT FRAMING PLANS (S-1.2 FOR ROOF FRAMING INFO.)

36" HIGH HALF WALL  
SOLID RAIL 34-36" ABOVE TREAD

HU CLIP TYP.

HEADER (SEE STRUCT.)

TYPICAL WALL ASSEMBLY  
(EXTERIOR TO INTERIOR)

-4" LAP SIDING  
-3/4" RAIN SCREEN  
-1/2" ZIP SYSTEM SHEATHING, TAPE SEAMS & PENETRATIONS  
-2X6 WALL

PROVIDE CAPILARY  
BREAK BETWEEN SILL  
PLATE & T.O. FDN. WALL

3/4" ANCHOR BOLT, EMBED 8"  
INTO T.O. FDN. (TYP.)

1X8 RISER  
1X SOUTHERN YELLOW  
PINE TREADS

W16X45

2X10 @ 16" O.C.

4" CLEAN, COMPACTED AGGREGATE.  
3" RIGID XPS INSUL.  
4" REINFORCED SLAB

BOND OUT FOR DOORS


PROSPECT

RD

DESIGN


58 FORE ST., PORTLAND, ME  
www.prospectdesign.me

T: 207-749-7400

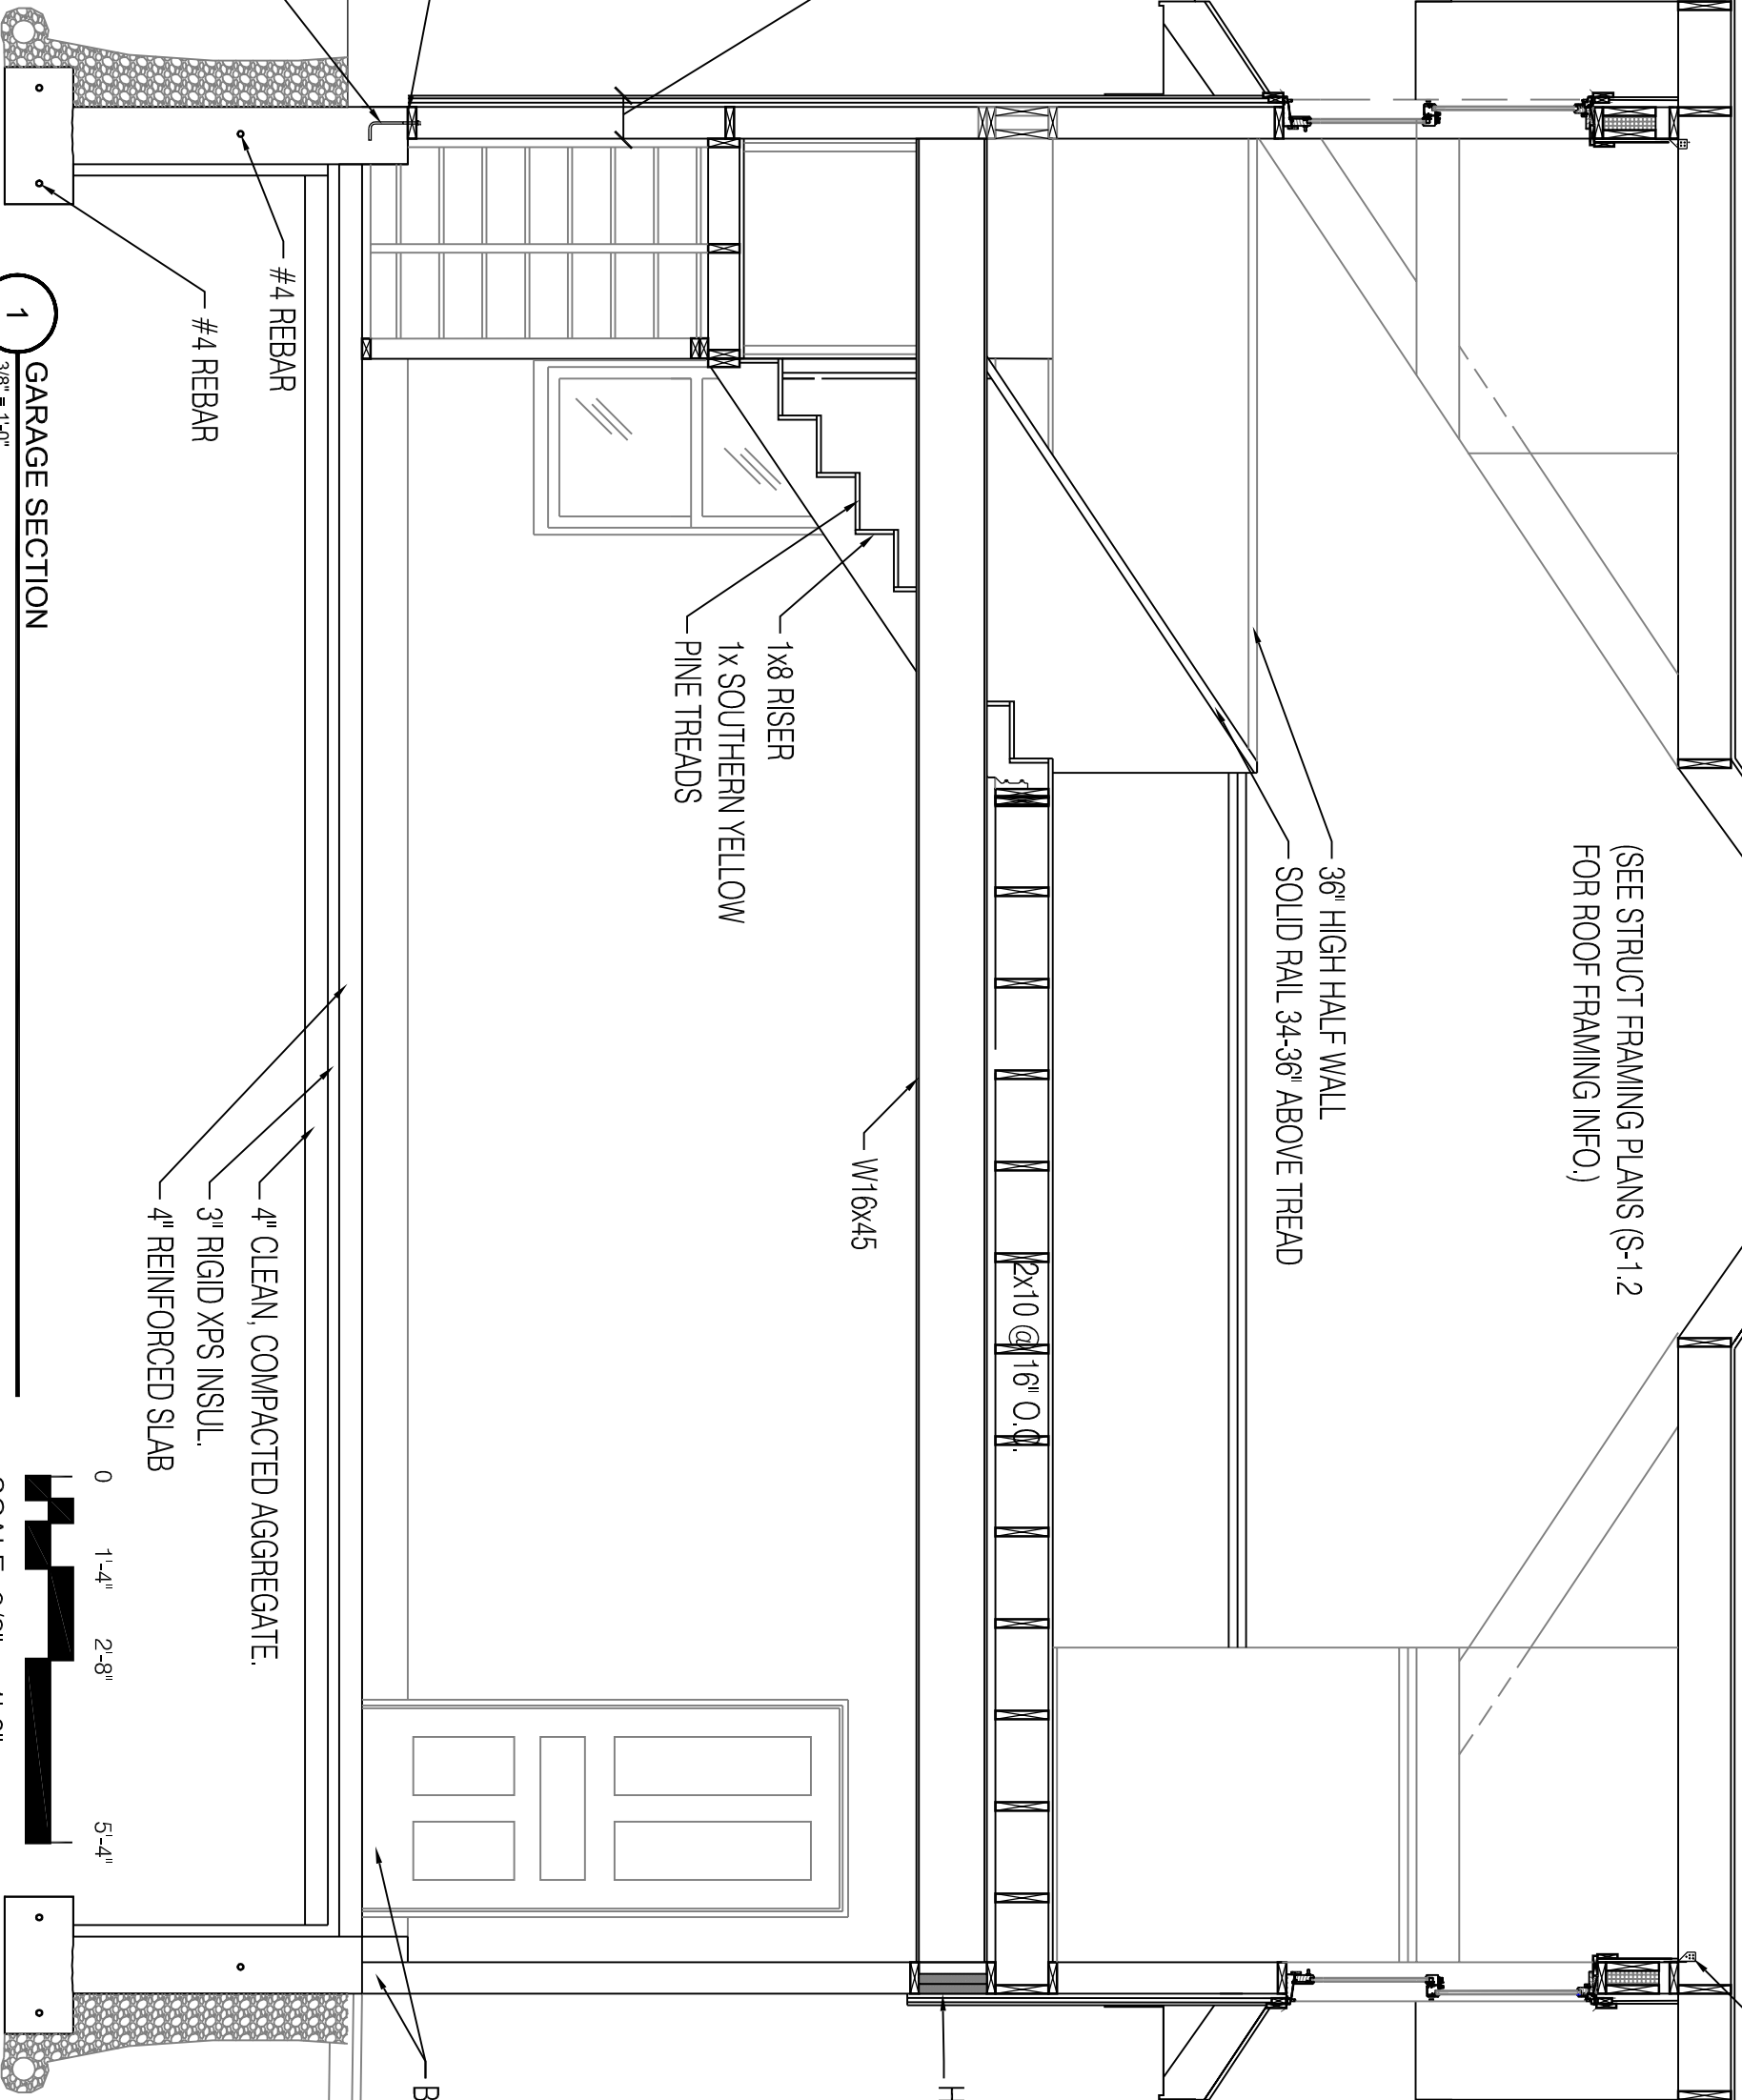

1 GARAGE SECTION  
3/8" = 1'-0"

GARAGE SECTION  
DETROY ROY

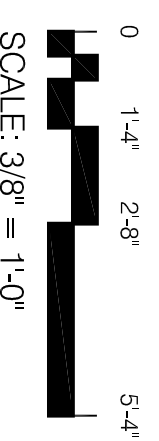

DATE:	3.27.2014
DRAWN BY:	BB

A-3.2