



1 PERIMETER FOUNDATION UNDERDRAIN
NOT TO SCALE

1. DRYWELL AS MANUFACTURED BY SUPERIOR CONCRETE OR APPROVED EQUAL.
2. CONCRETE 4000 PSI AFTER 28 DAYS.
3. FINISH GRADE VARIATIONS TO BE INDICATED BY DIMENSIONS.
4. 1/2" REBAR TO BE REINFORCED FOR N-20 LOADING.
5. 2" SLOPE TO BE SOLID CONC. SECTION.
6. 2" SLOPE TO BE SOLID CONC. SECTION.
7. SET GRADING PLAN FOR PFE INVERTS.

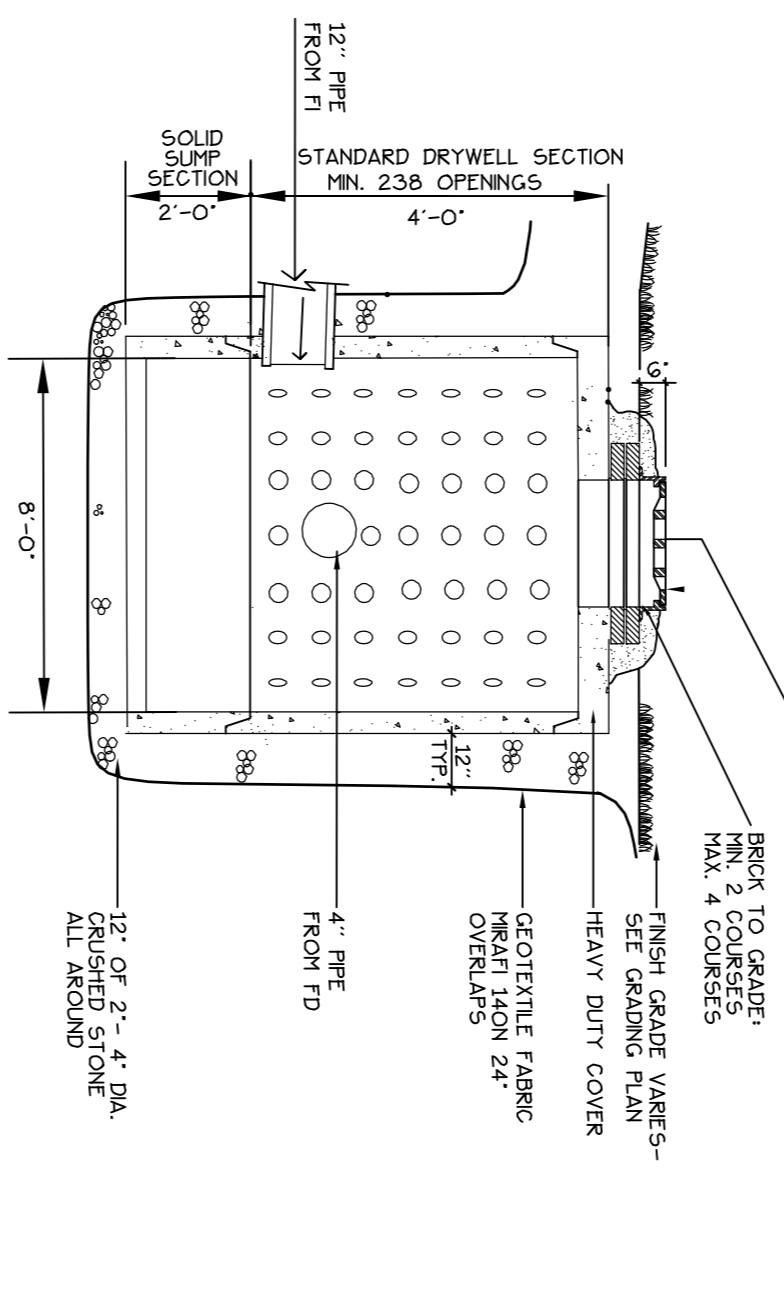


2 PRECAST CONCRETE DRYWELL
NOT TO SCALE

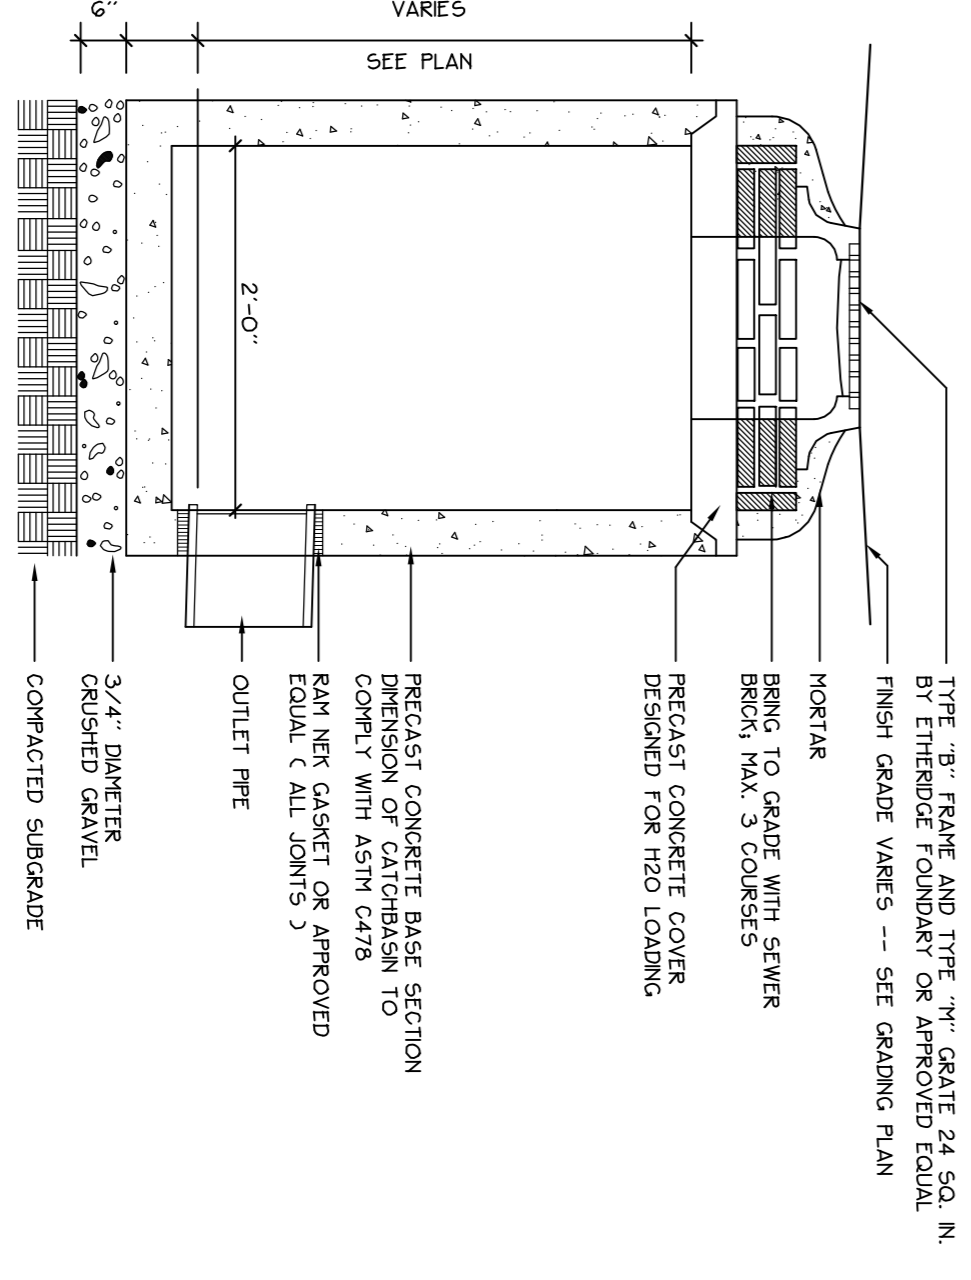


3 PRECAST CONCRETE DRAIN INLET
NOT TO SCALE

- NOTES:
1. ALL UNDERGROUND UTILITY SERVICE FOR POWER SHALL BE INSTALLED WITH THE CMP STANDARD REQUIREMENTS- ELECTRICAL SERVICE AND METER.
 2. ONE CONDUIT CAPPED FOR SPARE. PROVIDE GALVANIZED STEEL LONG SWEEP AT RISER GALVANIZED CONDUIT TO 10' ABOVE GRADE AT POLE WITH STAND-OFF BRACKETS.

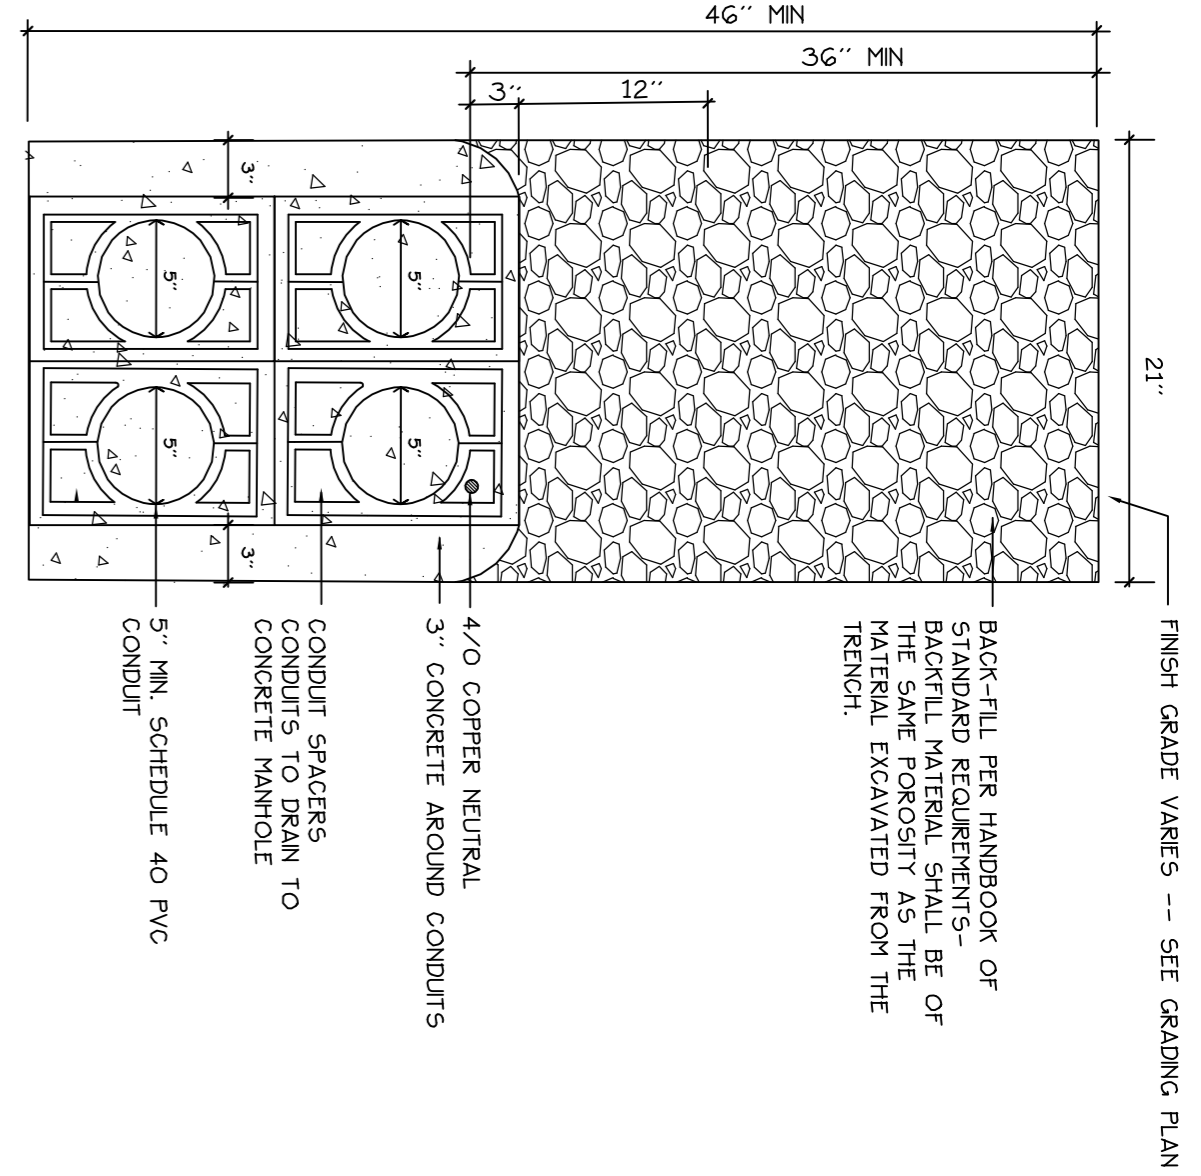

4 ELECTRICAL TRENCH: CMP CONCRETE ENCASED DUCTS-(WITHIN PUBLIC STREETS)
NOT TO SCALE

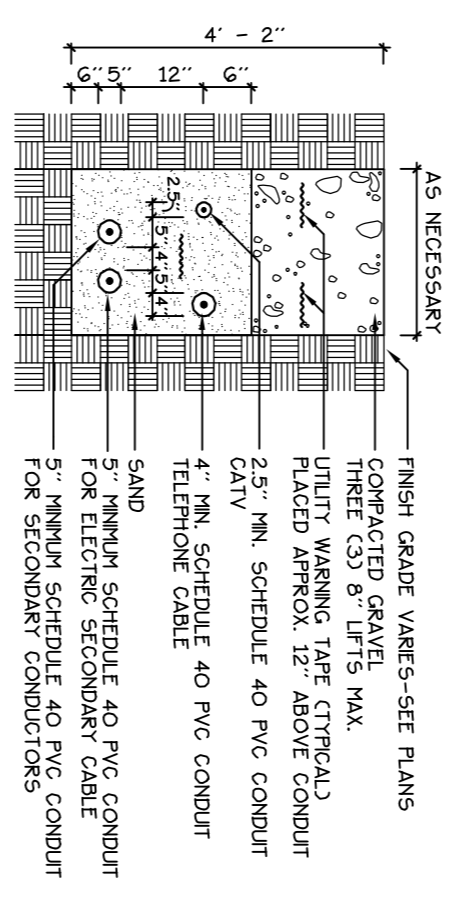

5 ELECTRICAL TRENCH
NOT TO SCALE



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DATE OF APPROVAL: June 10, 2014
PLANNER: Christine Grimando
PROJECT NO.: 2014-053

WASHINGTON AVENUE EFFICIENCIES
134 Washington Avenue **Portland, Maine**

Date: APRIL 14, 2014

Issued For: SITE PLAN AND SUBDIVISION PLAN REVIEW

Revisions:
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Revised: August 13, 2013

Title: SITE DETAILS

Scale: AS NOTED

Sheet No.: 7

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