

© 2006 TFH ARCHITECTS

ANDERSON STREET CONDOMINIUM
FOR
WILLIAM P. SIMPSON



TFH ARCHITECTS
100 COMMERCIAL STREET
PORTLAND MAINE 04101
TELEPHONE 207 775 6141
ARCHITECTURE PLANNING

CONSULTANTS:
RESURGENCE
ENGINEERING AND PRESERVATION, INC.
130 BIRCHWOOD STREET
PORTLAND, ME 04103
1/19/02 775-4850
RESURGENCE@VERIZON.NET

REVISIONS:

DATE: 9-6-06 -- PERMIT

PROJECT No. 06-014

DRAWN BY: AHH


CHECKED BY: AHH

SCALE: AS NOTED

SHEET TITLE:
Roof Framing Plan

S1.2

BEAM AND GIRDER SCHEDULE	
MARK	SIZE
B1	5 1/4" x 14" VERSA-LAM
B2	5 1/4" x 9 1/4" VERSA-LAM
B3	5 1/4" x 11 7/8" VERSA-LAM
B4	1 3/4" x 11 7/8" VERSA-LAM

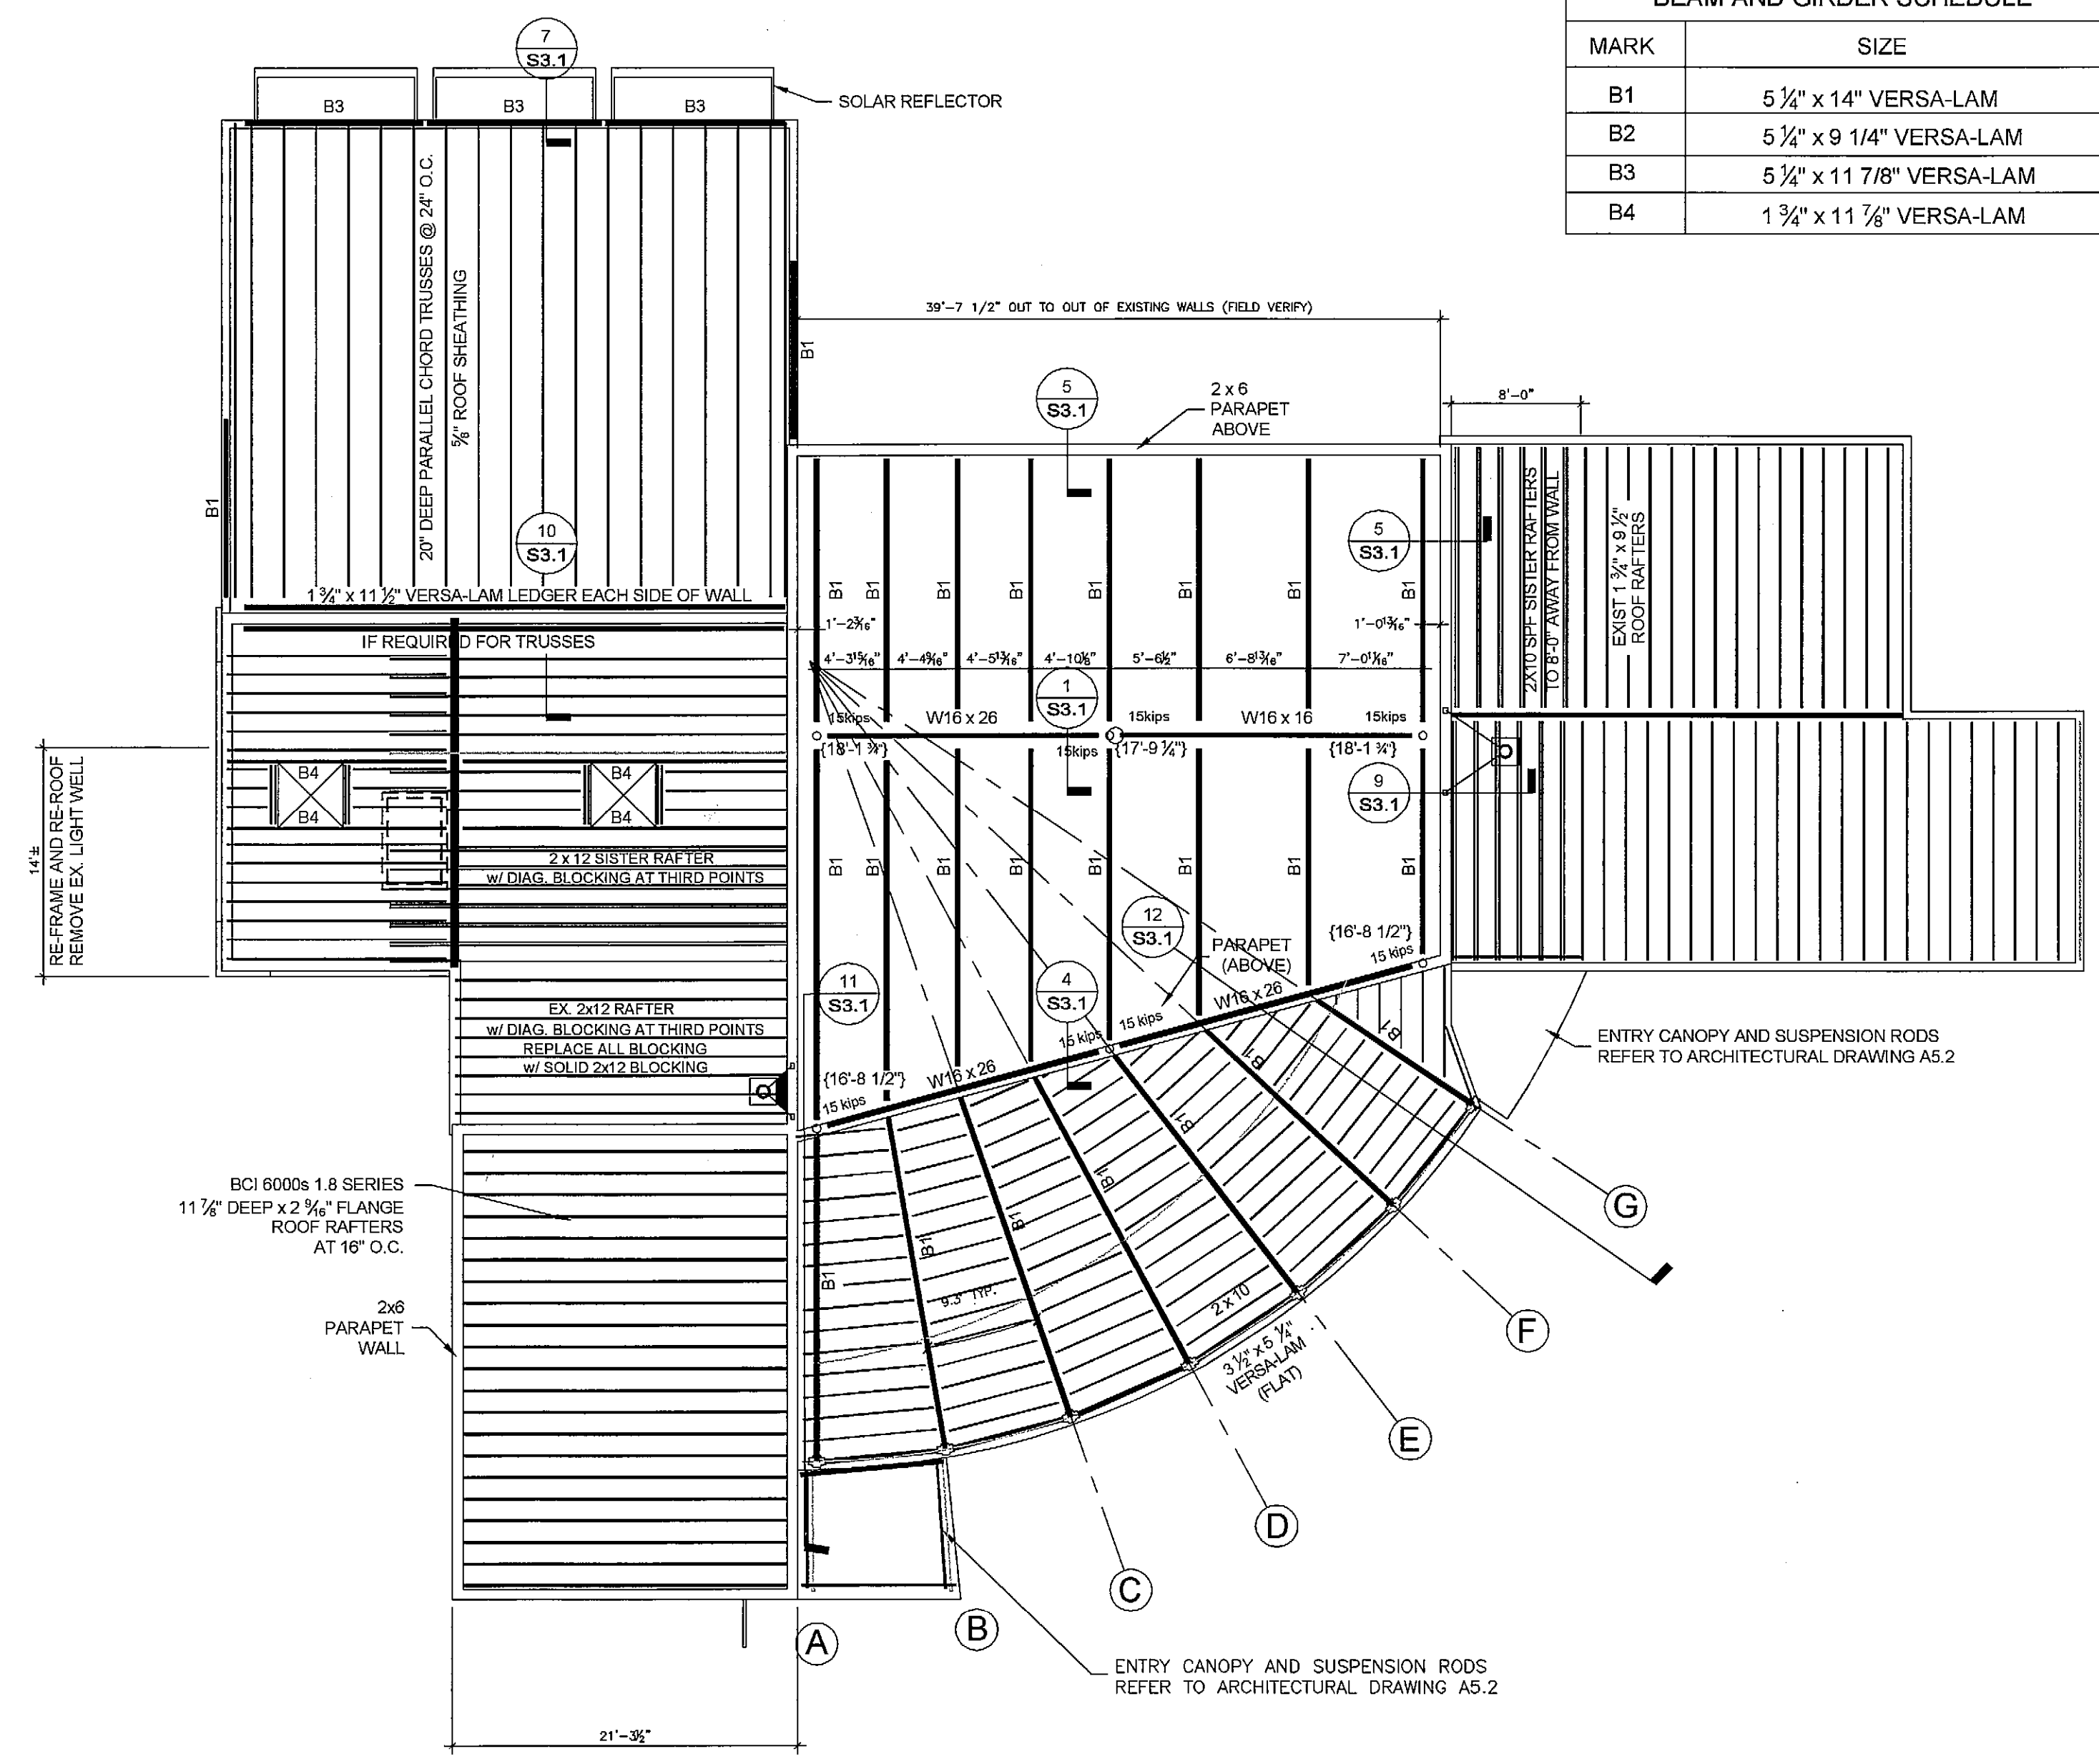

1 ROOF PLANS
1/8" = 1'-0"

- NOTES:
- {16'-4"} INDICATES TOP OF STEEL ELEVATION.
 - NO PROVISIONS HAVE BEEN MADE FOR ROOFTOP HVAC UNITS. HVAC DESIGNER TO CONTACT ENGINEER PRIOR TO PURCHASING EQUIPMENT TO COORDINATE ROOF LOADS, OPENINGS, AND FRAMING MEMBER SIZE INCREASES. STRUCTURAL ENGINEER IS NOT RESPONSIBLE FOR DEFICIENCIES CAUSED BY HVAC EQUIPMENT LOADS OR OPENINGS, IF NOT PREVIOUSLY COORDINATED.

