


ROOF FRAMING PLAN SCALE: 1/4" = 1'-@"

ACCORDINGLY

REDUCED
0 1'

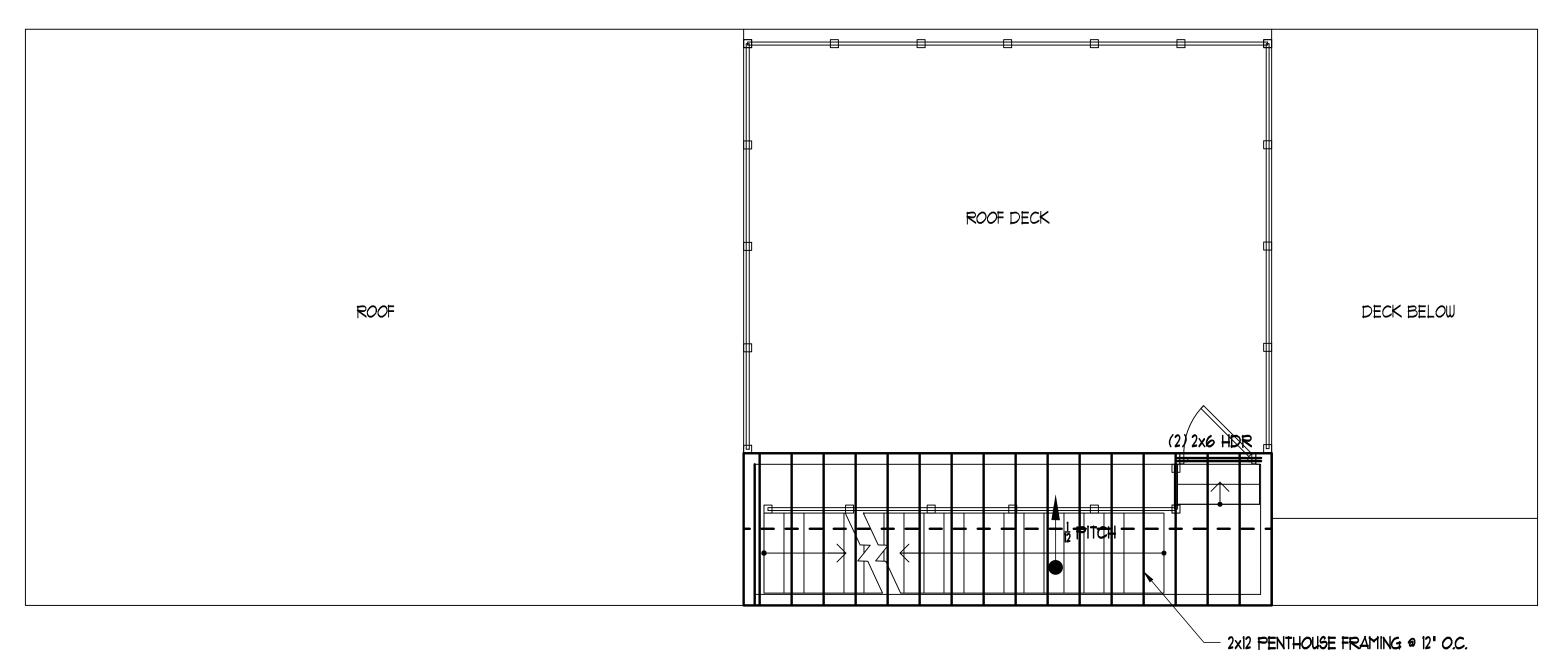

PENTHOUSE FRAMING PLAN SCALE: 1/4" = 1'-0"

STRUCTURAL SPECIFICATION NOTES: 1) FOOTINGS ARE DESIGNED FOR A PRESUMPTIVE SOIL BEARING PRESSURE OF 2,000 PSF, TO BE VERIFIED IN THE FIELD.

2) CONCRETE SLAB ON GRADE SHALL BE 4,000 PSI (F'C) CONCRETE STRENGTH W/6x6 WI.4x1.4 WWF 3 CLR FROM TOP OF SLAB. JOINTS ( $\frac{1}{2}$  WIDE x 1" DEEP) @ MAX. 15'x15' SPACING (225 SF. MAX), TYP. 3) PROVIDE SIMPSON HURRICANE CLIPS AT EACH RAFTER-TO-PLATE CONNECTION 4) WALL FRAMING SHALL ALIGN W/FLOORS ABOYE/BELOW AND ROOF JOISTS. 4) WALL SHEATHING SHALL BE APA-RATED 1/2" EXTERIOR SHEATHING. PROVIDE 2x6 SOLID BLOCKING AT ALL PANEL EDGES & FASTEN W/10d NAILS @ 3" O.C. @ PANEL EDGES AND 6' O.C. @ INTERMEDIATE. 5) WHEN NON-LOAD BEARING WALLS ABOVE ARE INSTALLED PARALLEL TO, THE OPEN JOIST BELOW, TWO

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REVISIONS

Date Issued 07.09.14 Project Number |42111

Drawing Scale AS NOTED SHEET NAME

> FRAMING PLANS

Drawn By

Checked By

METHODS ARE RECOMMENDED. A) ADD A SUPPORTING JOIST UNDER THE WALL ABOVE, OR B) ADD 2x SUPPORT OR LADDER BRACING EVERY 2'-0' O.C. W/SIMPSON Z28

CLIPS, OR EQUIVILLANT.