General Building Permit Application

property within the City, payment arrangements must be made before permits of any kind are accepted. If you or the property owner owes real estate or personal property taxes or user charges on any

Location/Address of Construction: レウダ みつかとえらった シテスモニア	ATUMAS ON STAMINT	
Total Square Footage of Proposed Structure/Area	Square Footage of Lot SEE PLOT PLAN	Number of Stories
sessor's Chart, Block & L	Applicant *must be owner, Lessee or Buyer*	Telephone:
# B1	Name 203 ANDERSON LC	C-838-7981
	Address Po Box 6610	
	City, State & Zip Portuna, ME 04103	7
Lessee/DBA (If Applicable)	Owner (if different from Applicant) C Name CRAKE W	Cost Of Work: \$ 8620
	Address	C of O Fee: \$
	City, State & Zip	Total Fee: \$
Current legal use (i.e. single family) OFFICE If vacant, what was the previous use? NA	Number of Residential Units.	Jnits&A
Proposed Specific use:		A COMMISSION OF THE PROPERTY O
Is property part of a subdivision?	If yes, please name	
Project description: CONSTRUCT A STAR , TO 2-15 FROM, ADD A WINDOWS PARTITION WALLS ON 2-15 FLOOR MICHE WIT	STAR FROM 1ST FROM L WILLDOWS ON ZOD FROM A MICHEWITH 3 RELOCATES OFFICE	NESTRONE ADD 3 NONBEARNE
Contractor's name: $S \in X $	LI RIC	
e & Zip PORT L		Telephone: 774-4755
ontact when the permit	SEWALL	Telephone: 838-7981
Mailing address: Po Box 6610	PORTIAND MANE CA103	***************************************

Please submit all of the information outlined on the applicable Checklist. Failure to do so will result in the automatic denial of your permit.


this form and other applications visit the Inspections Division on-line at www.portlandmaine.gov, or stop by the Inspections may request additional information prior to the issuance of a permit. For further information or to download copies of In order to be sure the City fully understands the full scope of the project, the Planning and Development Department Division office, room 315 City Hall or call 874-8703.

authorized representative shall have the authority to enter all areas covered by this permit at any reasonable hour to enforce the laws of this jurisdiction. In addition, if a permit for work described in this application is issued, I certify that the Code Official's I hereby certify that I am the Owner of record of the named property, or that the owner of record authorizes the proposed work and provisions of the codes applicable to this permit. that I have been authorized by the owner to make this application as his/her authorized agent. I agree to conform to all applicable

	Signature:	
This is not a permit; you may not commence ANY work until the permit is issu	re: Adolfend Date:	
ce ANY work until the permit is issued	te:	

SEWALL ASSOCIATES, INC.
PORTLAND, MAINE
(207) 774-4755
Fax (207) 774-5448

DET*145 0~ STAIR 1 DATE. DATE. Ö \ N ANDER SON S. SEWA \bar{z} φ CALCULATED BY. CHECKED BY N SHEET NO.

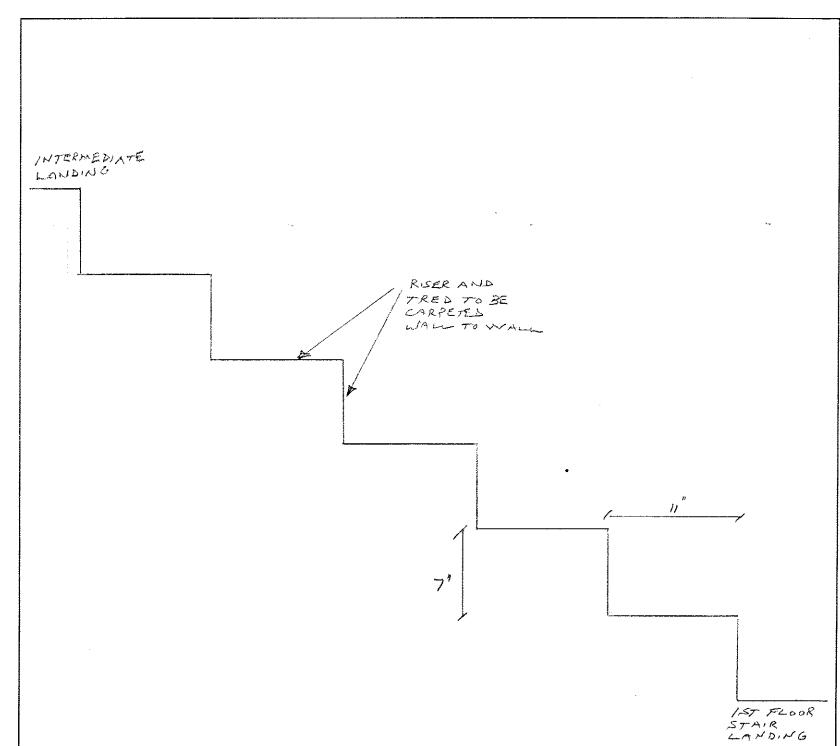


203 Anderson, LLC P.O. Box 6610 Portland, ME 04103

Submission For Building Permit at 203 Anderson Street

The proposed plan to install an interior stair requires fire extinguishers which will be provided.

The two egress exits from the second floor will be maintained and snow will be cleared during the winter.

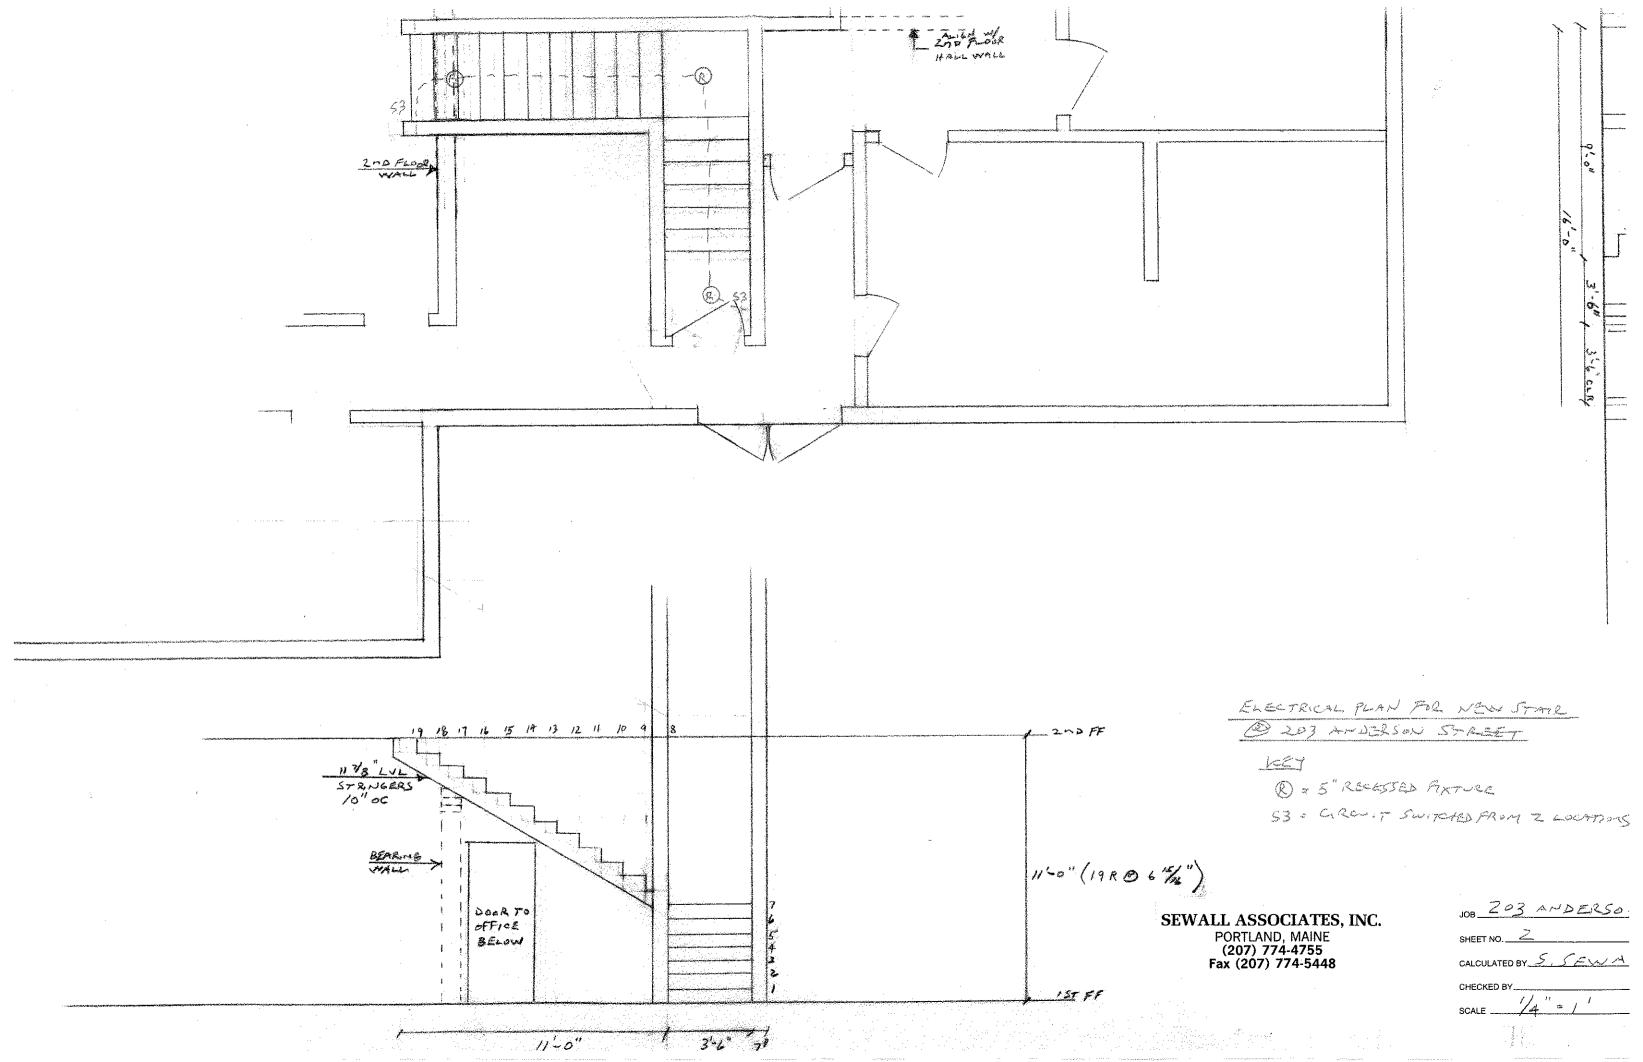

GENERAL NOTES

- 1. THE STRUCTURAL DESIGN OF THESE REPAIRS IS BASED ON THE FULL INTERACTION OF ALL CONNECTED COMPONENTS. NO PROVISIONS HAVE BEEN MADE FOR ANY TEMPORARY CONDITIONS THAT MAY ARISE DURING CONSTRUCTION. THE CONTRACTOR SHALL BE RESPONSIBLE FOR ADEQUATE DESIGN AND CONSTRUCTION OF ALL FORMS, SHORING, AND TEMPORARY BRACING DURING THE PROGRESS OF THE PROJECT. CONSULT THE ENGINEER IF THERE ARE QUESTIONS ABOUT SEQUENCING THE TEMPORARY SHORING.
- 2. WORK NOT INDICATED ON A PART OF THE DRAWINGS BUT REASONABLY IMPLIED TO BE SIMILAR TO THAT SHOWN AT CORRESPONDING PLACES SHALL BE INCLUDED.
- 3. NOTIFY ENGINEER OF ANY DISCREPANCIES BETWEEN THE DRAWINGS AND EXISTING CONDITIONS THAT MAY AFFECT THE WORK.
- 4. ANY MODIFICATION OR ALTERATION OF THESE CONSTRUCTION DOCUMENTS OR CHANGES IN CONSTRUCTION FROM THE INTENT OF THESE DRAWINGS BY THE CONTRACTOR WITHOUT WRITTEN APPROVAL OF THE ARCHITECT AND/OR ENGINEER SHALL REMOVE ALL PROFESSIONAL AND LIABILITY RESPONSIBILITY OF THE ARCHITECT AND/OR ENGINEER.
- 5, DO NOT SCALE FROM THE DRAWINGS.

DESIGN CRITERIA

1. INTERNATIONAL BUILDING CODE, 2003 EDITION: INCLUDING CONSIDERATION OF CHAPTER 34. EXISTING BUILDINGS.

ADDRESS: 203 ANDERSON STREET, PORTLAND, MAINE

SNOW LOAD: NOT APPLICABLE TO PROJECT WIND LOAD: NOT APPLICABLE TO PROJECT

LIVE LOAD: 100 POUNDS PER SQUARE FOOT, OFFICE COORIDOR FLOORS AND STAIRS

SEISMIC LOAD: PER IBC SECTION 1615.0; EARTHQUAKE DESIGN DATA PER SECTION 1616.3;

SEISMIC IMPORTANCE FACTOR, le SEISMIC USE GROUP
SHORT-PERIOD RESPONSE ACCELLARATION 0.37 1-SECOND RESPONSE ACCELLARATION 0.10 SEISMIC DESIGN CATEGORY BASIC SEISMIC FORCE-RESISTING SYSTEM SHEAR WALLS RESPONSE MODIFICATION FACTOR ANALYSIS PROCEDURE: EQUIVALENT LATERAL FORCE

GENERAL REQUIREMENTS

- 1. COORDINATE CONSTRUCTION TO ENSURE EFFICIENT AND ORDERLY INSTALLATION OF EACH PART OF THE WORK.
- 2. DELIVER, STORE, AND HANDLE PRODUCTS USING MEANS AND METHODS THAT WILL PREVENT DAMAGE, DETERIORATION, AND LOSS, INCLUDING THEFT, COMPLY WITH MANUFACTURER'S WRITTEN INSTRUCTIONS.
- 3. SCHEDULE DELIVERY TO MINIMIZE LONG-TERM STORAGE AT PROJECT SITE AND TO PREVENT OVERCROWDING OF CONSTRUCTION SPACES. DELIVER PRODUCT IN MANUFACTURER'S ORIGINAL SEALED CONTAINER OR PACKAGEING, COMPLETE WITH LABELS AND INSTRUCTIONS FOR HANDLING, STORING, UNPACKING, PROTECTING, AND INSTALLING.
- 4. STORE PRODUCTS THAT ARE SUBJECT TO DAMAGE BY THE ELEMENTS UNDER COVER IN A WEATHERTIGHT ENCLOSURE ABOVE GROUND, WITH VENTILATION ADEQUATE TO PREVENT CONDENSATION.
- 5. WHERE DRAWINGS SPECIFY A SINGLE PRODUCT OR MANUFACTURER, PROVIDE THE ITEM INDICATED THAT COMPLIES WITH REQUIREMENTS.

ROUGH CARPENTRY MATERIALS AND REQUIREMENTS


1. DIFFERING TIMBER MATERIALS ARE SPECIFIED AT VARIOUS LOCATIONS, MATERIAL GRADES SHALL CONFORM TO THE FOLLOWING SPECIES AND GRADES:

CONVENTIONAL LUMBER: COMPOSITE LUMBER: PLYWOOD:

SPRUCE-PINE-FIR (south) NO. 2 GRADING PER NELMA PRESSURE-TREATED TIMBER: SOUTHERN YELLOW PINE NO. 2 GRADING PARALLAM BY WEYERHAUSER, Fb=3,100 psi, E=2000ksi. 3* THICK, EXTERIOR GRADE, B/C FINISH

ALL LUMBER AND TIMBER FRAMING MATERIAL SHALL BE STORED IN A PROTECTED, DRY AREA OFF OF THE GROUND AND GROUND FLOOR SURFACES. STORE MATERIAL OUT OF DIRECT SUNLIGHT TO PREVENT DIFFERENTIAL DRYING AND WARPING.

- 2. TIMBER FRAMING SCREWS, WHERE INDICATED, SHALL BE MANUFACTURED BY FASTENMASTER, (413) 789 0252. TIMBER FRAMING SCREWS MAY INCLUDE THE FOLLOWING TYPES: TIMBERLOK, HEADLOK, OR TRUSSLOK AS INDICATED ON THE DRAWINGS. INSTALL ALL FASTENMASTER FASTENERS IN PRE-DRILLED HOLES, USING 1 / 8" PILOT BIT.
- 3. JOIST HANGERS SHALL BE MANUFACTURED BY SIMPSON STRONG-TIE, INC. ALL HANGERS SHALL BE Z-MAX COATED, ATTACHED WITH 10d x 1 1 /2" HANGER NAILS.
- 4. THIS PROJECT INVOLVES JOINING NEW MATERIALS WITH EXISTING TIMBER AND LUMBER AND SHORING AND LEVELLING EXISTING FLOORS.
 IT IS ESSENTIAL TO LIFT EXISTING FLOOR JOISTS AND GIRDERS INCREMENTALLY, NOT RAISING FRAMING TOO MUCH IN ANY ONE LIFT OR DAY.
- 5. RIGHT-ANGLE DRILLS ARE AN ESSENTIAL TOOL TO ACCOMPLISH ANY SISTERING OR SPLICING WORK UNDER THE FIELD CONDITIONS. INSTALL ALL FASTERMASTER FASTENERS IN PRE-DRILLED HOLES, USING 1/8" PILOT BIT, TACK JOIST HANGERS INTO POSITION AND PREDRILL PILOT HOLES WITH 3/32" WOOD BIT INTO EXISTING LUMBER, IF SUCH CONDITIONS ARISE.
- 6. NOTIFY ENGINEER IF, DURING COURSE OF CONSTRUCTION, CONTRACTOR DECIDES THAT IT IS MORE EXPEDIENT TO REMOVE AND REPLACE EXISTING FLOOR JOISTS THAN TO TRY TO

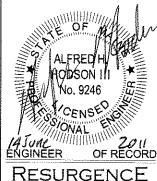

ENGINEERING & PRESERVATION, INC. 132 BRENTWOOD STREET PORTLAND, ME 04103 207.773.4880

Drawn By: Erin Alello

Checked By: Affred H. Hodson III P.E.


MAINE ON LLC STRE NO **ANDERSON** PORTLAND, 2 Ш ANDI 3 20, 203


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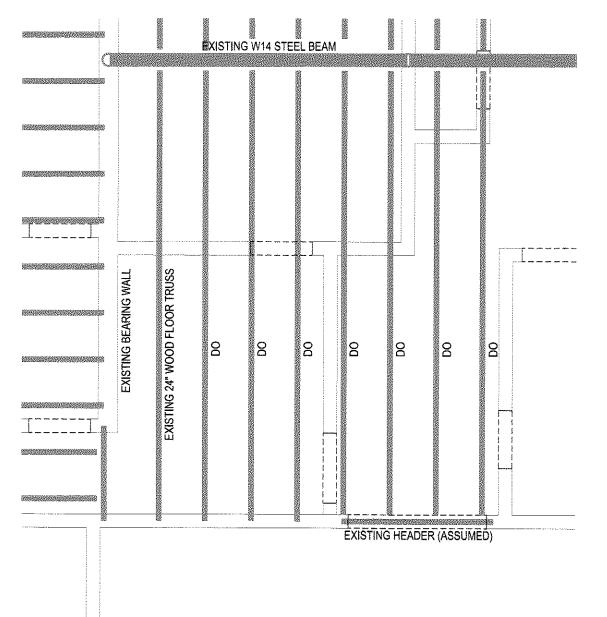
STRUCTURAL NOTES

Date: 06/14/11 Issued for:

CONSTRUCTION



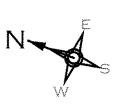

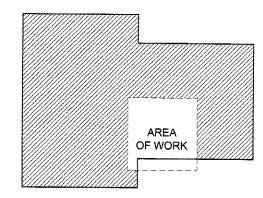

EXISTING W14 STEEL BEAM 3 SIMPSON L70 3½" X 24" LVL HEADER BRACKETS EACH END 35 X 24" LVL HEADER EACH SIDE LVL HEADER GUSSET EXISTING HEADER (ASSUMED) NOTE 1: TRIM EXISTING BEARING WALL TO ACCOMODATE STAIR

SECOND FLOOR FRAMING PLAN (EXISTING CONDITIONS) SCALE: 1/4" = 1'-0"

SECOND FLOOR FRAMING PLAN (PROPOSED)

SEE SECTION A FOR STAIR STRINGERS AND LANDING PLATFORM FRAMING

SCALE: 1/4" = 1'-0"



RESURGENCE

132 BRENTWOOD STREET PORTLAND, ME 04103 207.773.4880

Drawn By: Erin Alello Checked By: Alfred H. Hodson III P.E.

> 203 ANDERSON STREET PORTLAND, MAINE 203 ANDERSON LLC


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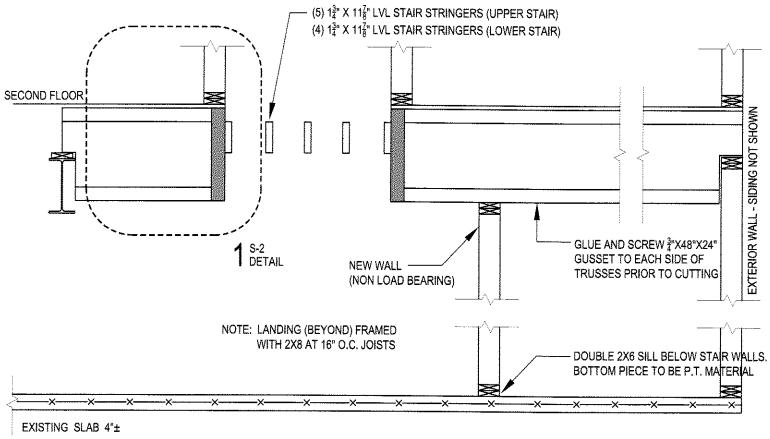
FRAMING PLAN SECOND FLOOR

Date: 06/14/11 Issued for:

CONSTRUCTION


S-2



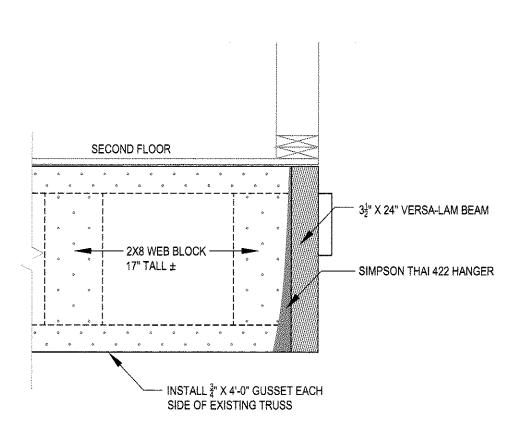

1 DETAIL
S-3 1" = 1'-0"



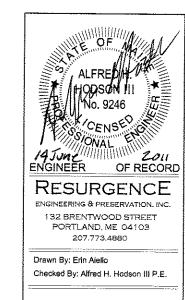

203 ANDERSON STREET PORTLAND, MAINE 203 ANDERSON LLC

Drawing:

SECTION DETAILS

Date: 06/14/11 Issued for:

CONSTRUCTION

S-3