



1 North Elevation (Washington Ave.)  
Scale: 1/8" = 1'-0"

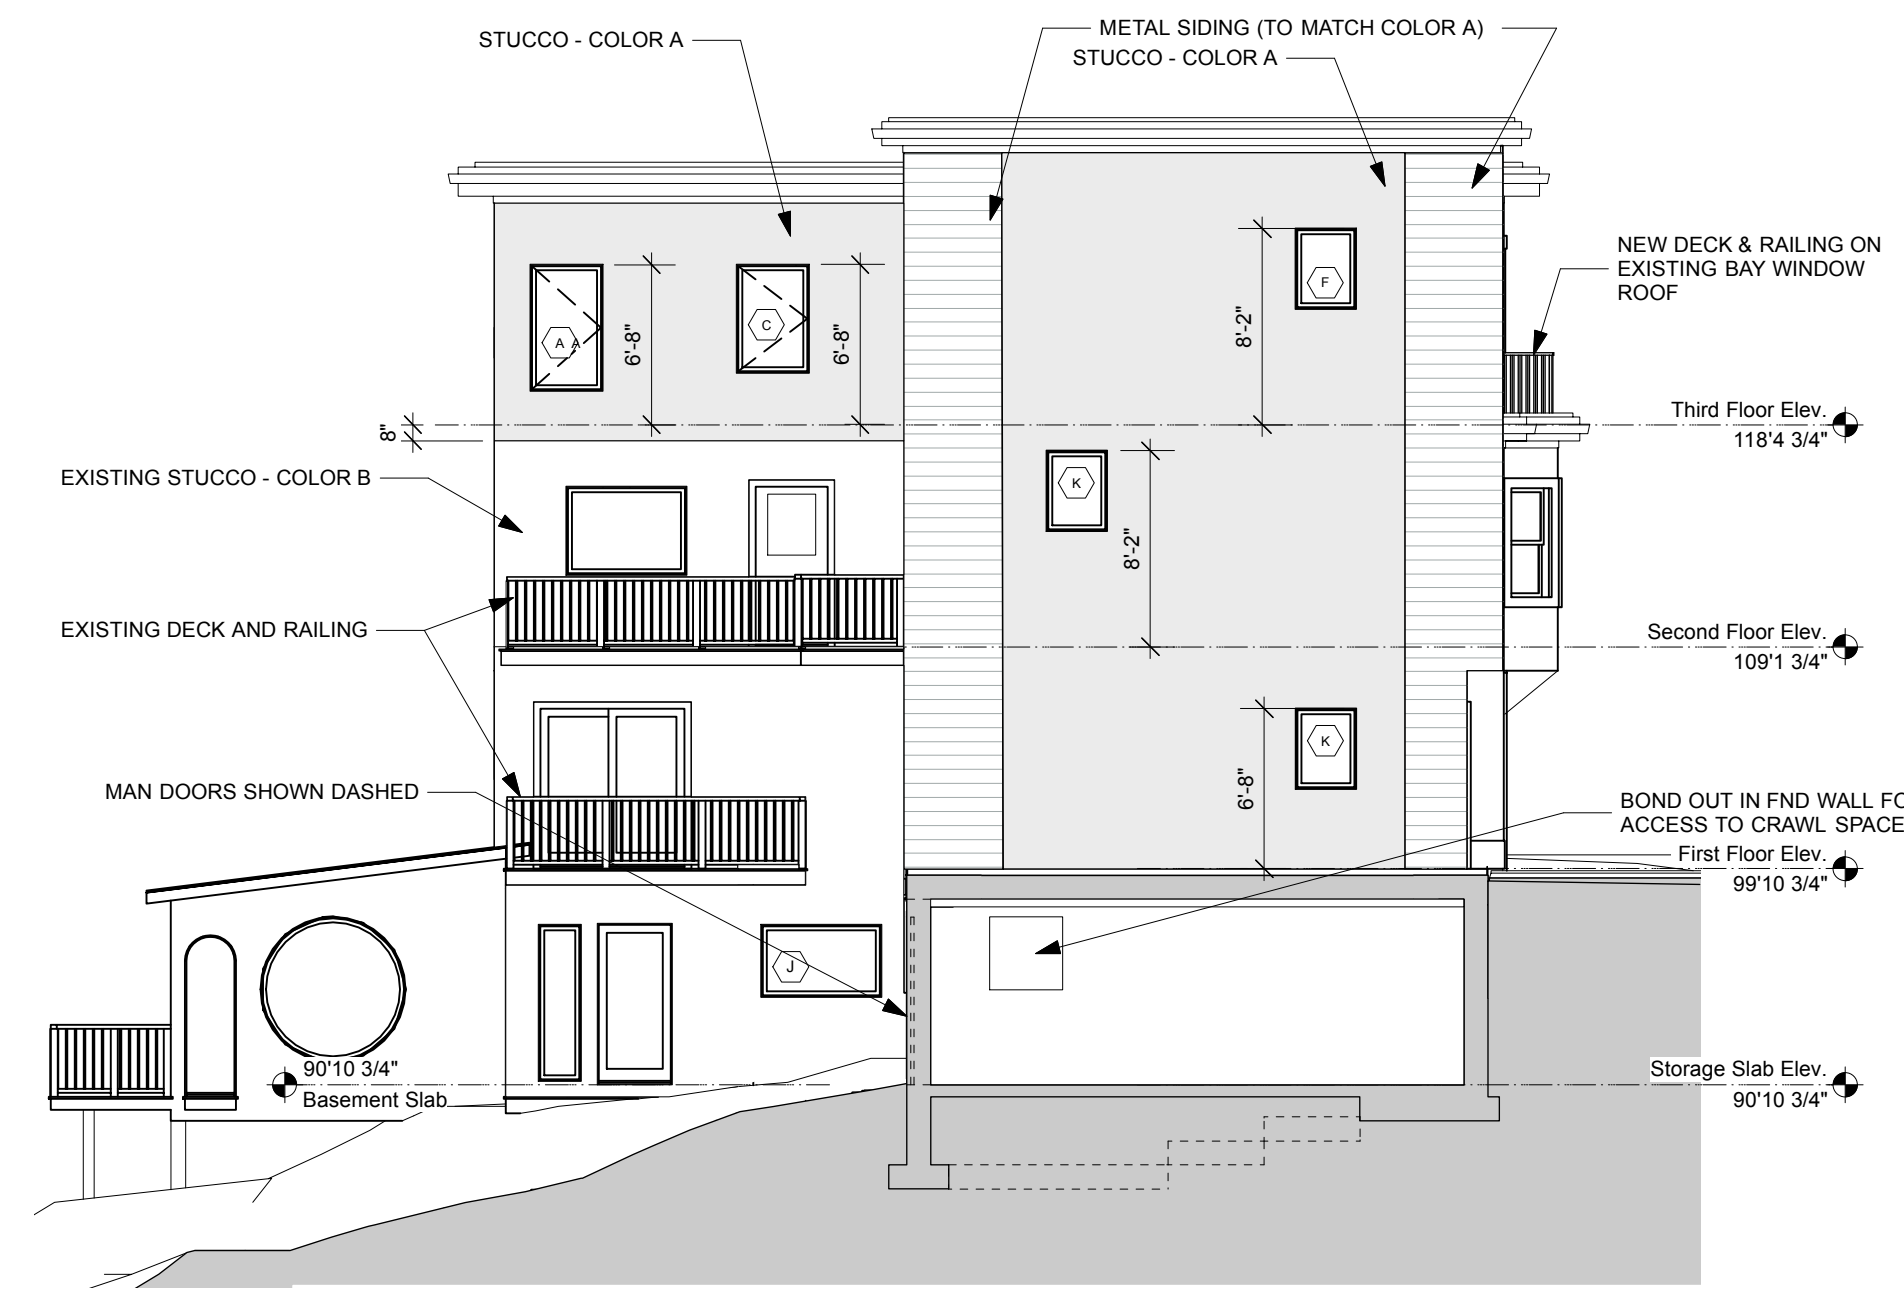


2 East Elevation  
Scale: 1/8" = 1'-0"

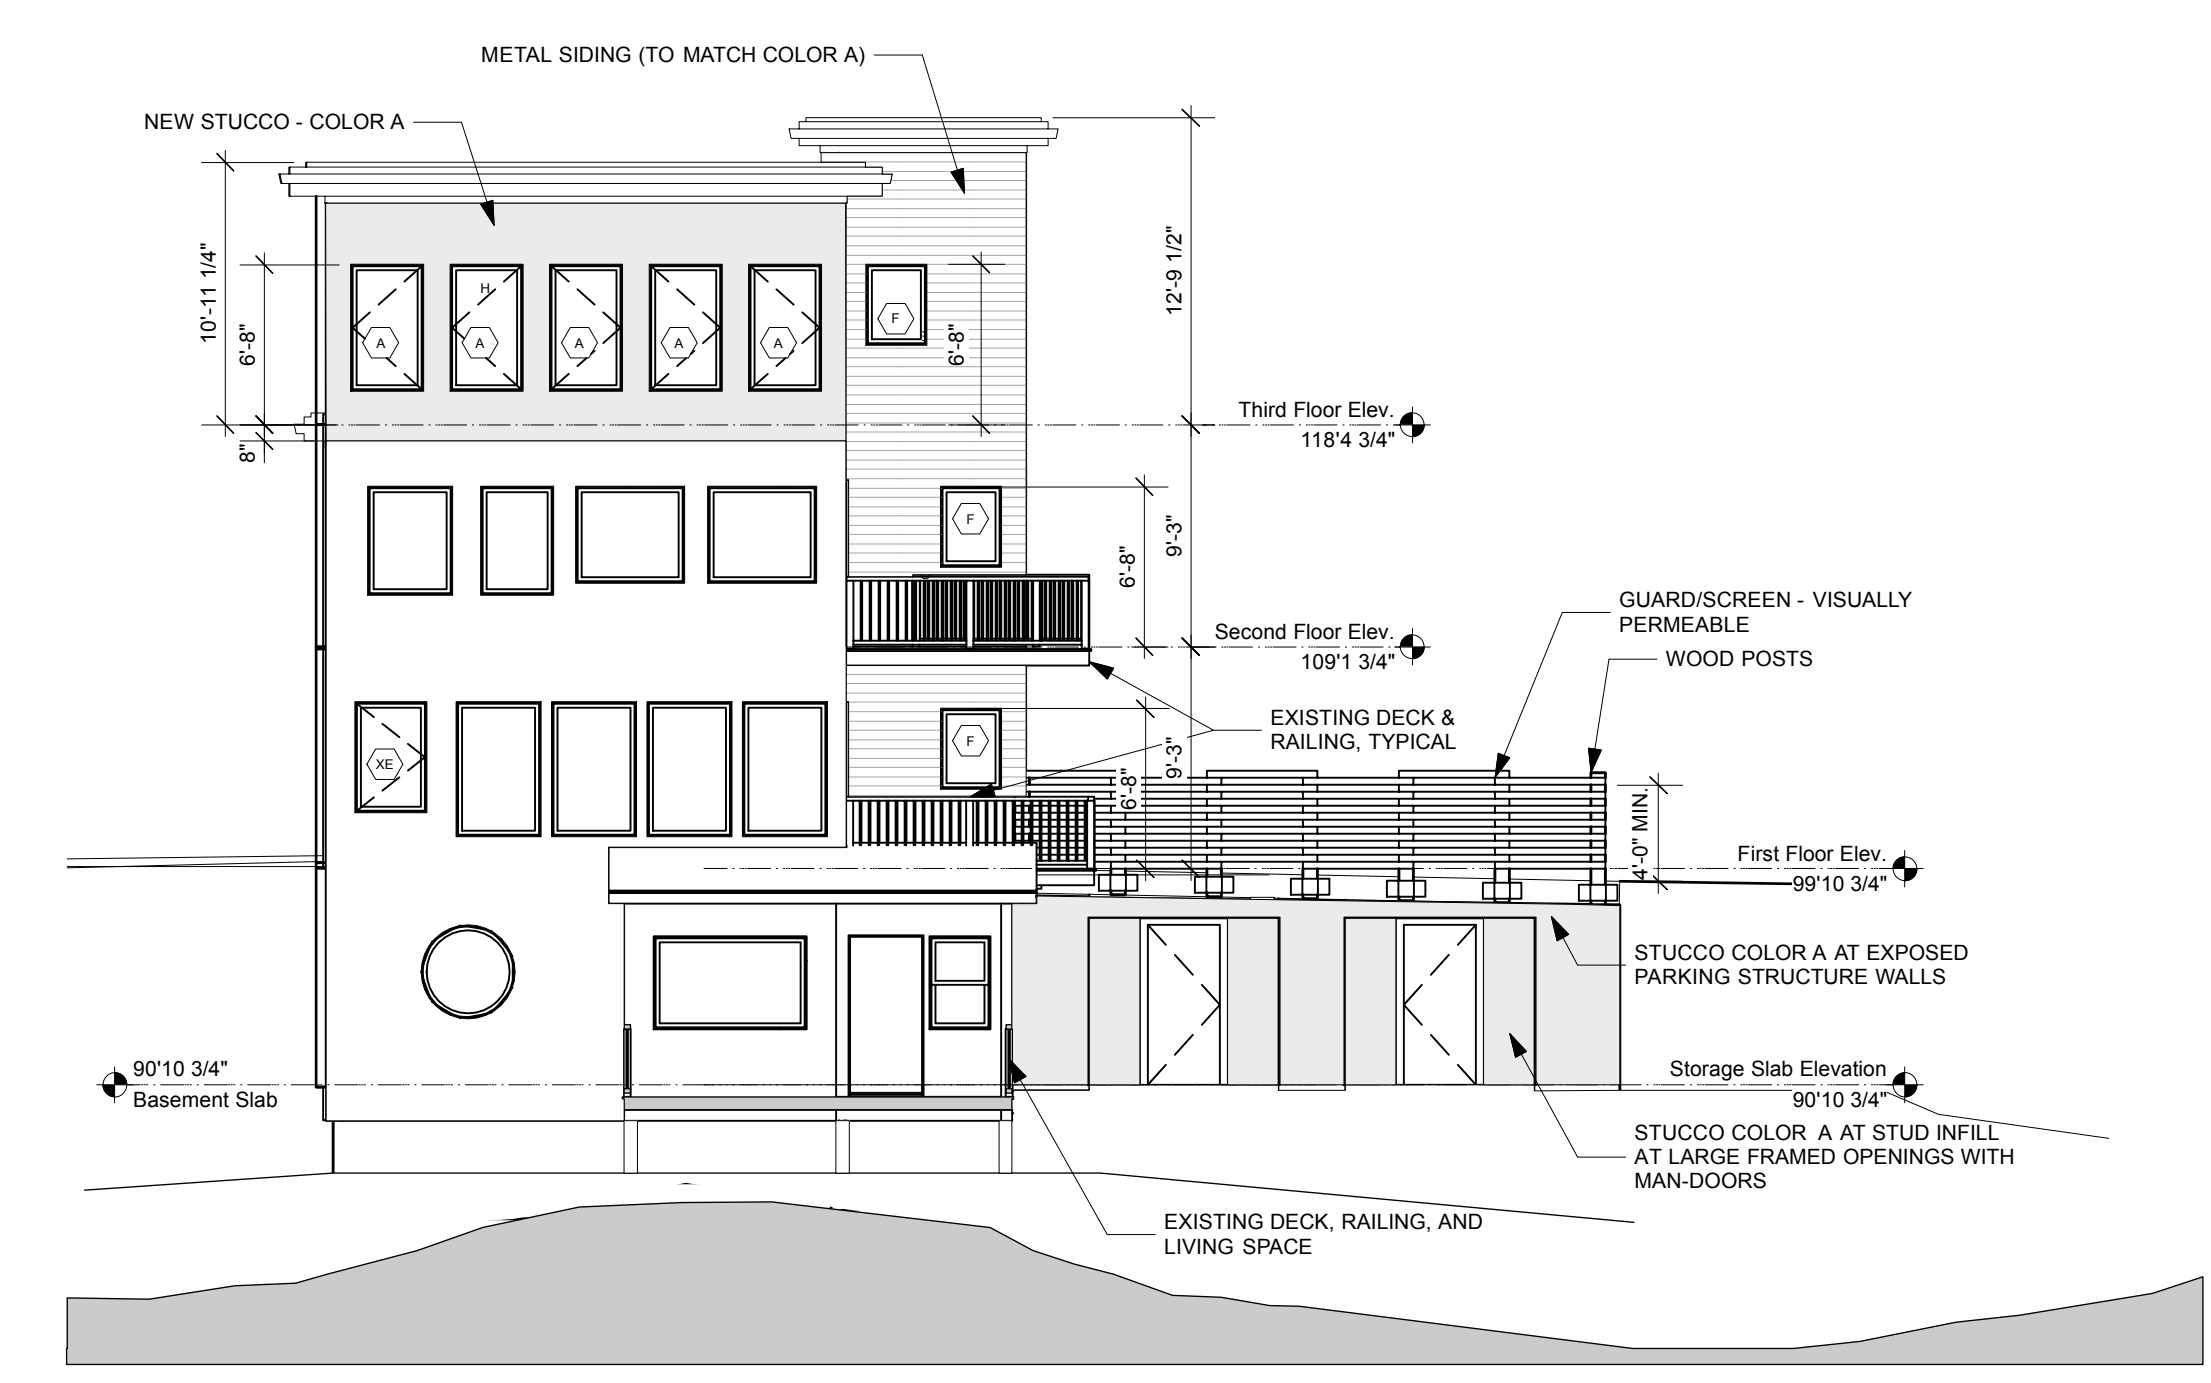

3 South Elevation  
Scale: 1/8" = 1'-0"

Window Schedule—Summarized by Mark																
Mark	Qty	Nominal Size	Glass	Frame Details	Openings			Window Data								
		O.A. Width	O.A. Height	Sash Operation	Head Detail	Jamb Detail	SH Detail	Egress Win	RO Width	RO Height	Max O Width	Max O Height	Mfr	Model No.	Accessories	Comments
A	8	30"	53"	Casement					30 1/2"	53 1/2"	34"	54"				
B	2	32"	36"	Casement					32 1/2"	36 1/2"	34"	40"				
C	1	30"	46"	Casement					30 1/2"	46 1/2"	34"	48"				
D	1	50"	40"	Fixed Glass					50 1/2"	40 1/2"	54"	48"				
E	1	26"	50"	Fixed Glass					26 1/2"	50 1/2"	28"	54"				
F	4	26"	34"	Fixed Glass					26 1/2"	34 1/2"	28"	40"				
G	1	26"	30"	Fixed Glass					26 1/2"	30 1/2"	28"	34"				
H	1	26"	26"	Fixed Glass					26 1/2"	26 1/2"	28"	28"				
J	1	50"	30"	Fixed Glass				FALSE	50 1/2"	30 1/2"	54"	34"				
K	2	26"	34"	Fixed Glass					26 1/2"	34 1/2"	28"	40"				
XE	1	2'11 1/2"	47"	Casement				YES	30"	47 1/2"	34"	48"				

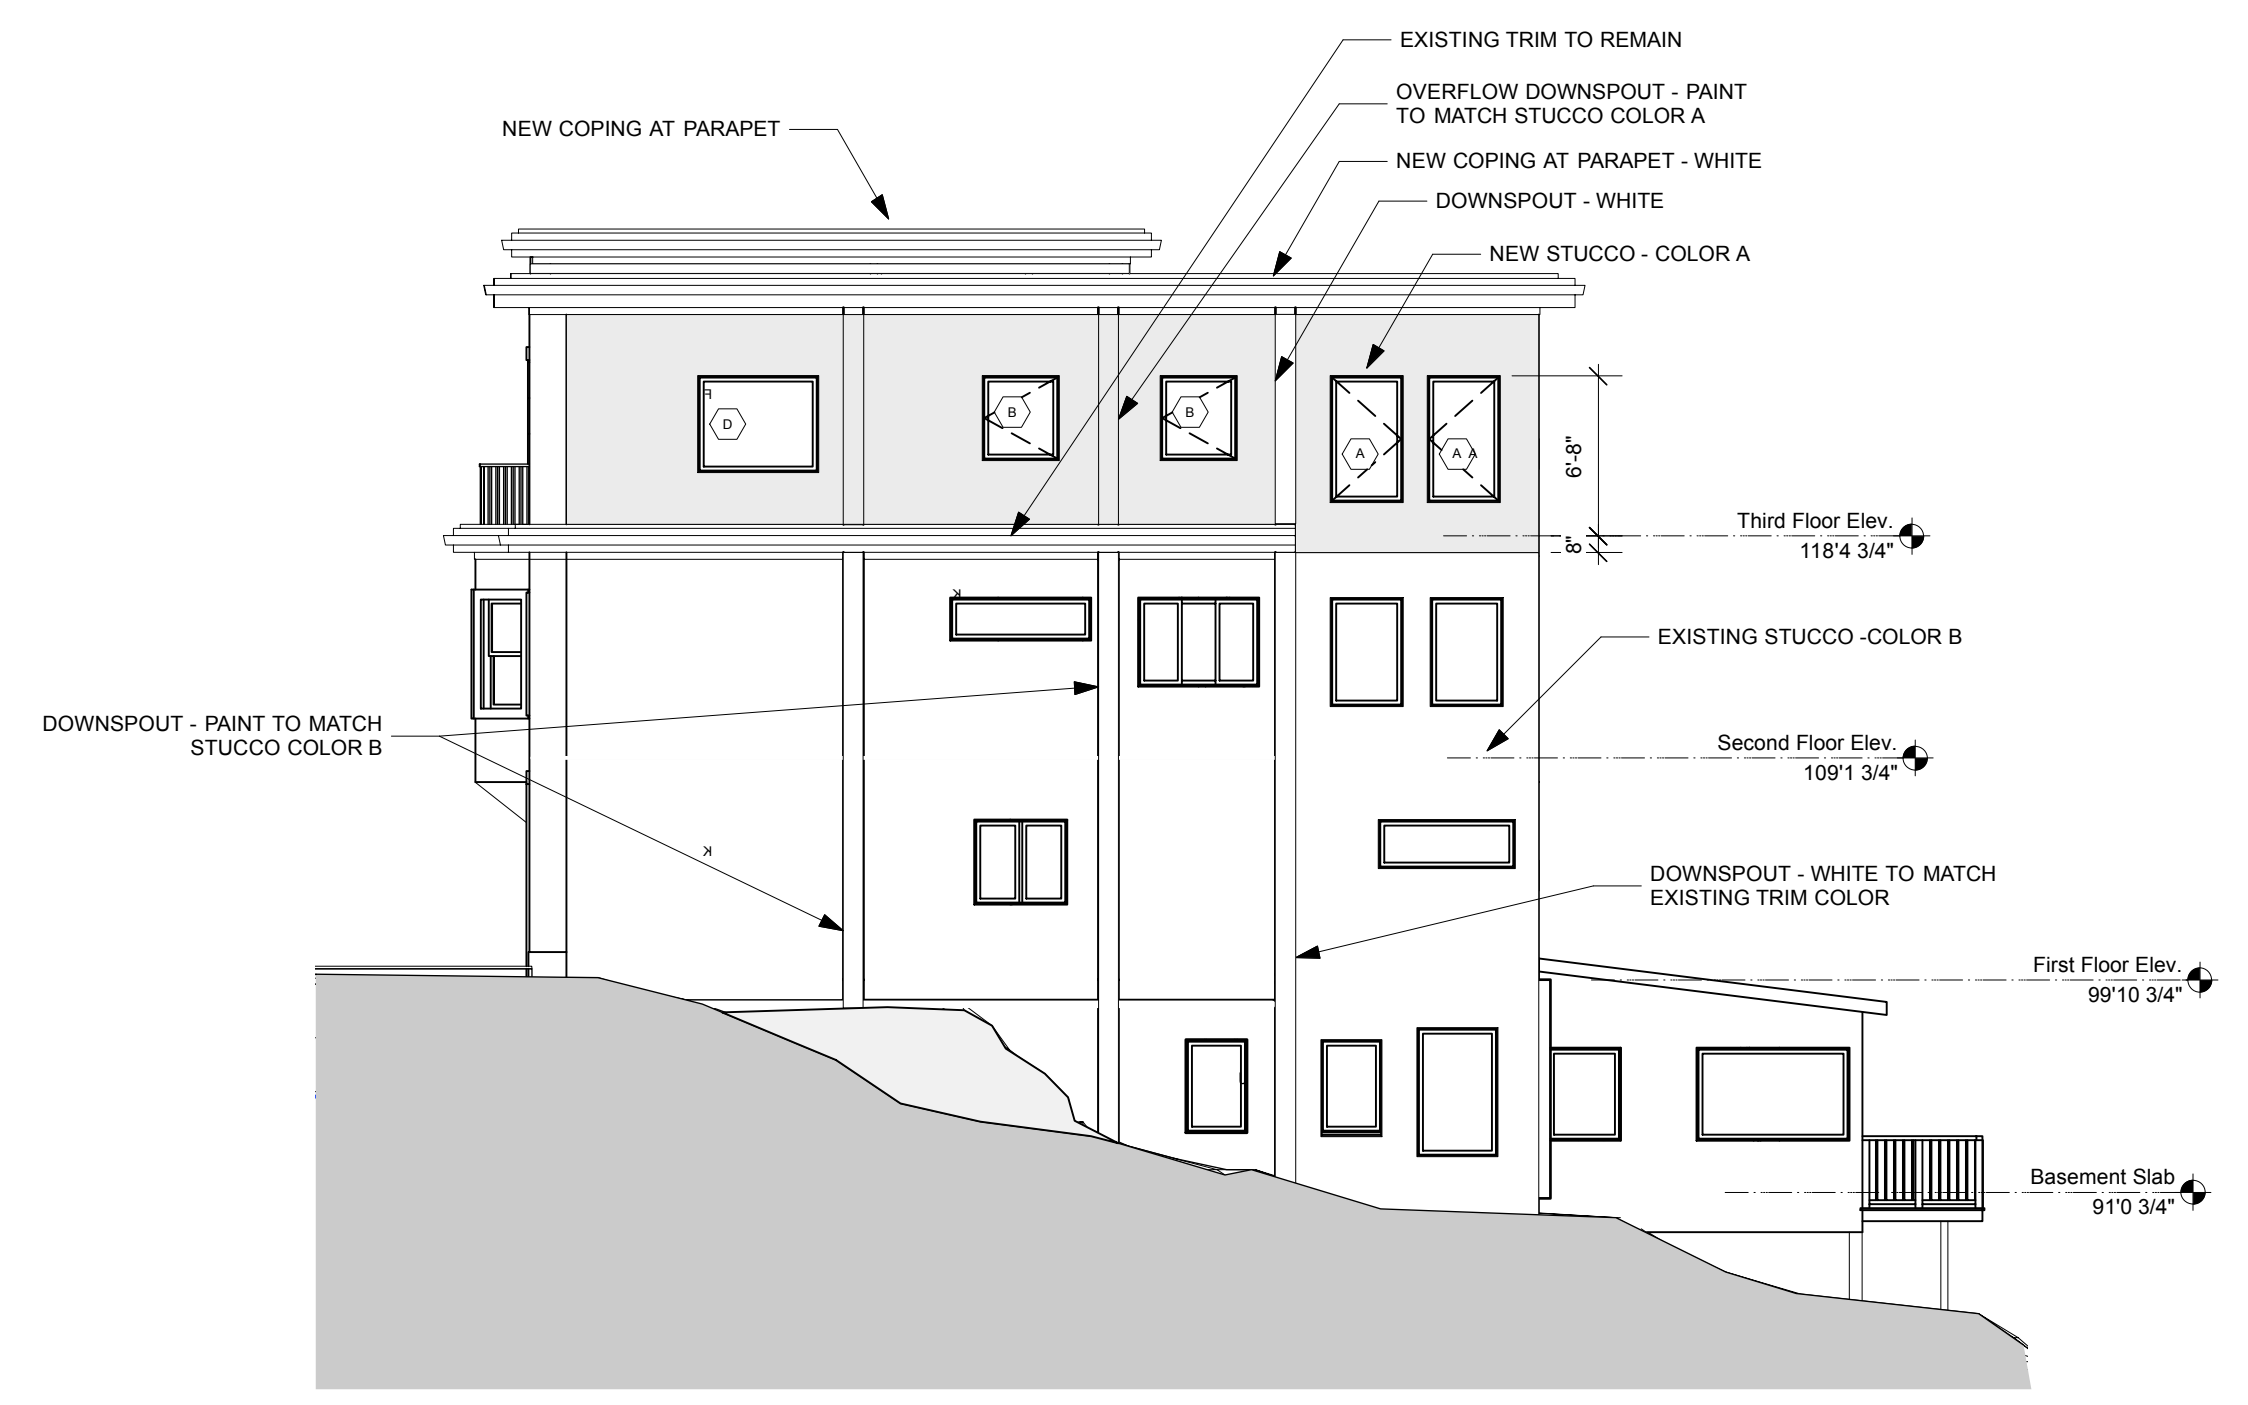

4 West Elevation  
Scale: 1/8" = 1'-0"

Door Schedule													
Mark	Nominal Size		Door Operation	Side Lights	Fire Rating	Openings		Door Data					
	Width	Height		L Slab Wid	R Slab Wid	Frame	Door Slab	RO Width	RO Height	Mfr	Model No.	Accessories	Comments
DB_01	30"	68"	Swing Simple					31 1/2"	68 3/4"				
DB_02	30"	68"	Swing Simple					31 1/2"	68 3/4"				
DB_03	26"	68"	Swing Simple					27 1/2"	68 3/4"				
DB_04	26"	68"	Swing Simple					27 1/2"	68 3/4"				
DB_05	26"	68"	Swing Simple					27 1/2"	68 3/4"				
DB_06	26"	68"	Swing Simple					27 1/2"	68 3/4"				
DB_07	30"	68"	Swing Simple					31 1/2"	68 3/4"				
DB_08	30"	68"	Swing Simple					31 1/2"	68 3/4"				
DB_09	30"	68"	Swing Simple					31 1/2"	68 3/4"				
DB_10	30"	68"	Swing Simple					31 1/2"	68 3/4"				
DB_11	30"	68"	Swing Simple					31 1/2"	68 3/4"				
DB_12	30"	68"	Swing Simple					31 1/2"	68 3/4"				
DB_13	30"	68"	Swing Simple					31 1/2"	68 3/4"				
DB_14	30"	68"	Swing Simple					31 1/2"	68 3/4"				
DB_15	30"	68"	Swing Simple					31 1/2"	68 3/4"				
DB_16	30"	68"	Swing Simple					31 1/2"	68 3/4"				
DB_17	30"	68"	Swing Simple					31 1/2"	68 3/4"				
DB_18	30"	68"	Swing Simple					31 1/2"	68 3/4"				
DB_19	30"	68"	Swing Simple					31 1/2"	68 3/4"				
DB_20	30"	68"	Swing Simple					31 1/2"	68 3/4"				

**PRELIMINARY - NOT FOR CONSTRUCTION**

Design Firm <b>RESIDENTIAL DESIGN STUDIO, LLC</b> Carol A. Morrisette 174 Danforth Street Portland, Maine 04102 T 207.699.4184 C 207.671.7965	Project Title <b>218 Washington Avenue</b> Portland, Maine B-1b Zone	Sheet Status Progress Set - Not for Construction Project Number <b>13.70</b> Drawn By <b>CAAM</b> Sheet No. <b>A2.1</b>
Revisions 1 2 3	Sheet Title CBL 10-A-15 <b>Exterior Elevations &amp; Schedules</b>	Date <b>18 JUNE 2014</b> Scale <b>1/4" = 1'-0" UNO</b> CAD File Number <b>MorsePlanAv2014</b>