

1 ROOF PLAN  
SCALE: 1/4" = 1'-0"


- GENERAL NOTES**
1. FLASHING CONTRACTOR IS RESPONSIBLE TO VERIFY ALL SKYLIGHTS ARE PROPERLY FLASHED TO PREVENT LEAKS. FLASHING SHALL BE INSTALLED TO THE EXTERIOR OF THE ROOF. FLASHING SHALL BE INSTALLED TO THE INTERIOR OF THE ROOF. FLASHING SHALL BE INSTALLED TO THE EXTERIOR OF THE ROOF. FLASHING SHALL BE INSTALLED TO THE INTERIOR OF THE ROOF.
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  3. AVERAGE INSULATION R VALUE: 30.0 NOT 14 3/4" (THICKNESS)
  4. CONTRACTOR SHALL USE 20'-0" WIDE ROLLS TO MINIMIZE JOINTS.
  5. ALL SEAMS SHALL BE REINFORCED WITH MANUFACTURER'S RECOMMENDED REINFORCEMENT.
  6. VERIFY SKYLIGHT CURB DIMENSIONS BY MANUFACTURER'S DETAILS.
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**LEGEND**

EF	EXHAUST FAN	EPDM	EPDM
SF	SUPPLY FAN	ASB	ASBESTOS
EH	EXHAUST HOOD	INS	INSULATION
HPT	HIGH POINT OF PITCH INSUL. DEPTH	W/P	WALK PAD
LPT	LOW POINT OF PITCH INSUL. DEPTH	SD	SCUPPER
RD	ROOF DRAIN	DIR	DIRECTION
SRD	SCUPPER ROOF DRAIN	VTR	VENT THROUGH ROOF
VTR	VENT THROUGH ROOF	CU	CONDENSING UNIT

**SKYLIGHT SCHEDULE**

TYPE	UNIT DIMENSION	MODEL #	REMARKS
A	4'-3" x 8'-0"	DDRVV-48	SHIPPED ASSEMBLED
B	5'-0" x 8'-0"	DD-CA-300	SHIPPED ASSEMBLED
C	10'-0" x 20'-0"	CUSTOM GABLE	SEE NOTE 8, 7/42 PITCH
D	4'-3" x 8'-0"	DDRVV-48	SHIPPED ASSEMBLED
E	3'-0" x 3'-0"	DD-CA-300	SEE ALTERNATE #
F	3'-2" x 3'-2"	DD-CA-402	SEE ALTERNATE #

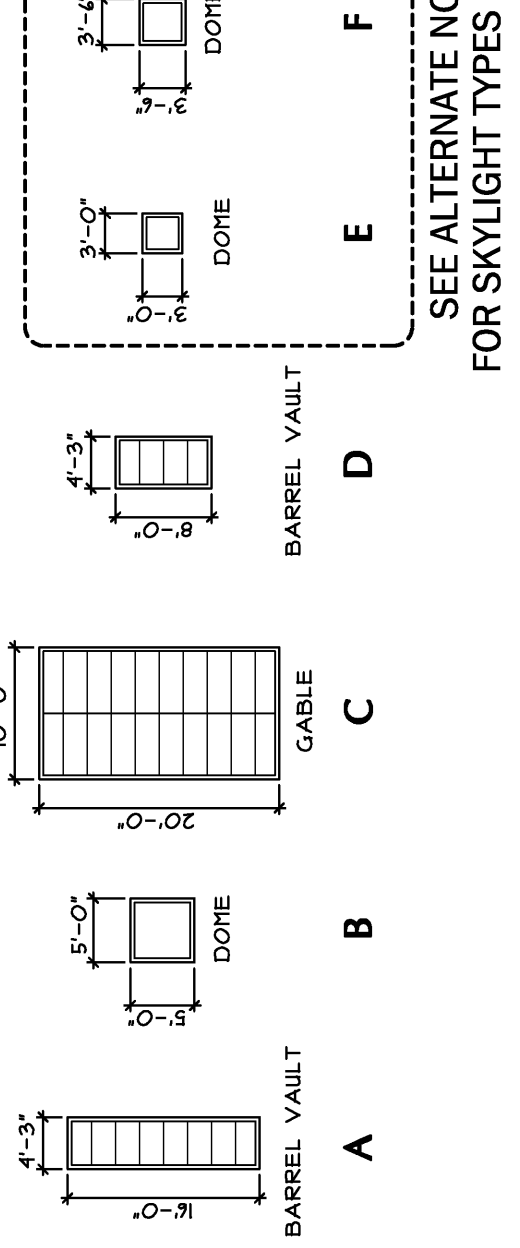

SEE ALTERNATE NO. 8 FOR SKYLIGHT TYPES 'E' & 'F'

**East End Elementary School**  
Portland Public Schools  
Portland, Maine

DATE: 03/15/2004  
DRAWN BY: oab  
CHECKED BY: jpb  
DRAWING TITLE: Roof Plan

**A1.12**

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**CONSULTANTS**  
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Structural Engineer: Pinkham & Greer  
Mechanical Engineer: Bennett Engineering  
Electrical Engineer: Bartlett Design  
Architect: T.M. Consulting  
Fire Solutions: Fire Solutions

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REVISED: 03/15/2004  
BY: oab  
REASON: 1/15/04 - 1/15/04  
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