



DOOR SCHEDULE																APPLICABLE	REMARKS	
NO.	W.	HT.	THK.	TYPE	MATL.	GLASS	LOUVER	INS.	LABEL	FRAMES					HDWE. SET			
										TYPE	MATL.	HEAD	JAMB	SILL			LABEL	INS.
PQ1	2'-8"	7'-0"	1-w"	F	HM	-	-	•	-	2	HM	2	11/12	21	-	•	1	SEE NOTE 4
PQ2	2'-4'-0"	8'-0"	1-w"	FNV	HM	5/8" INSUL	-	•	-	3	HM	2	11	21	-	•	3	
PQ3	2'-3'-0"	8'-0"	1-w"	F	HM	-	-	-	B	EXISTING FRAME					2			
PQ4	2'-4'-0"	5'-0"	1-w"	F	HM	-	-	-	B	1	HM	1	13	21	B	-	2	
P11	2'-3'-0"	6'-8"	1-w"	F	HM	-	-	-	-	5	HM	SM 2	13	SM 13	-	-	4	
P12	-	-	-	-	-	1" INSUL	-	-	-	4	HM	SIN 1	14	SM 14	-	-	-	
P13	2'-3'-0"	7'-0"	1-w"	FNV	HM	5/8" INSUL	-	•	-	6	HM	2	11/16	21	-	•	4	
P14	3'-8"	3'-0"	1-w"	F	HM	-	-	-	-	▲	HM	-	17/8	-	-	-	5	▲ CUSTOM FRAME. SEE NOTE 5
P15	EXISTING DOOR					EXISTING FRAME					3		3	PROVIDE NEW HARDWARE				
P18	2'-2'-0"	2'-10"	1-w"	F	FRP	-	-	•	-	7	FRP	3	SIN 3	22	-	-	6	SEE NOTE 7

**NOTES:**  
1. FIELD VERIFY ALL EXISTING CONDITIONS, DIMENSIONS AND CLEARANCES. SPECIFICALLY VERIFY ALL DIMENSIONS INDICATED WITH AN "X" AND ALL NEW DOORS AND FRAMES THAT ARE TO BE FABRICATED TO FIT WITHIN THE EXISTING STRUCTURE.  
2. INSULATED HM TRANSOM PANELS SHALL BE THE SAME CONSTRUCTION AS THE DOORS.  
3. COORDINATE THE NEW DOOR HARDWARE WITH THE EXISTING DOOR FRAMES INDICATED TO REMAIN.  
4. THE RELOCATED STEAM AND CONDENSATE LINES PENETRATE THE HM TRANSOM PANEL. SEE DRAWING M-7.  
5. PROVIDE SUPPORT AS REQUIRED FOR INSTALLATION OF THE DOOR STOP.  
6. CUT AND SPLICE THE FRAME AND TRANSOM PANEL AS REQUIRED AT THE EXISTING CONDUITS.  
7. DOOR P18 IS LOCATED AT THE NEW CHEMICAL FILL STATION TO BE INSTALLED IN THE EXISTING CHEMICAL ROOM #108. REMOVE THE EXISTING WINDOW AND INSTALL DOOR P18. SEE DRAWINGS PR-13 AND PR-21.  
8. SEE THE LINTEL SCHEDULE ON DRAWING A-4.  
9. ALL PENETRATIONS IN THE HOLLOW METAL TRANSOMS AND FRAMES SHALL BE SEALED.

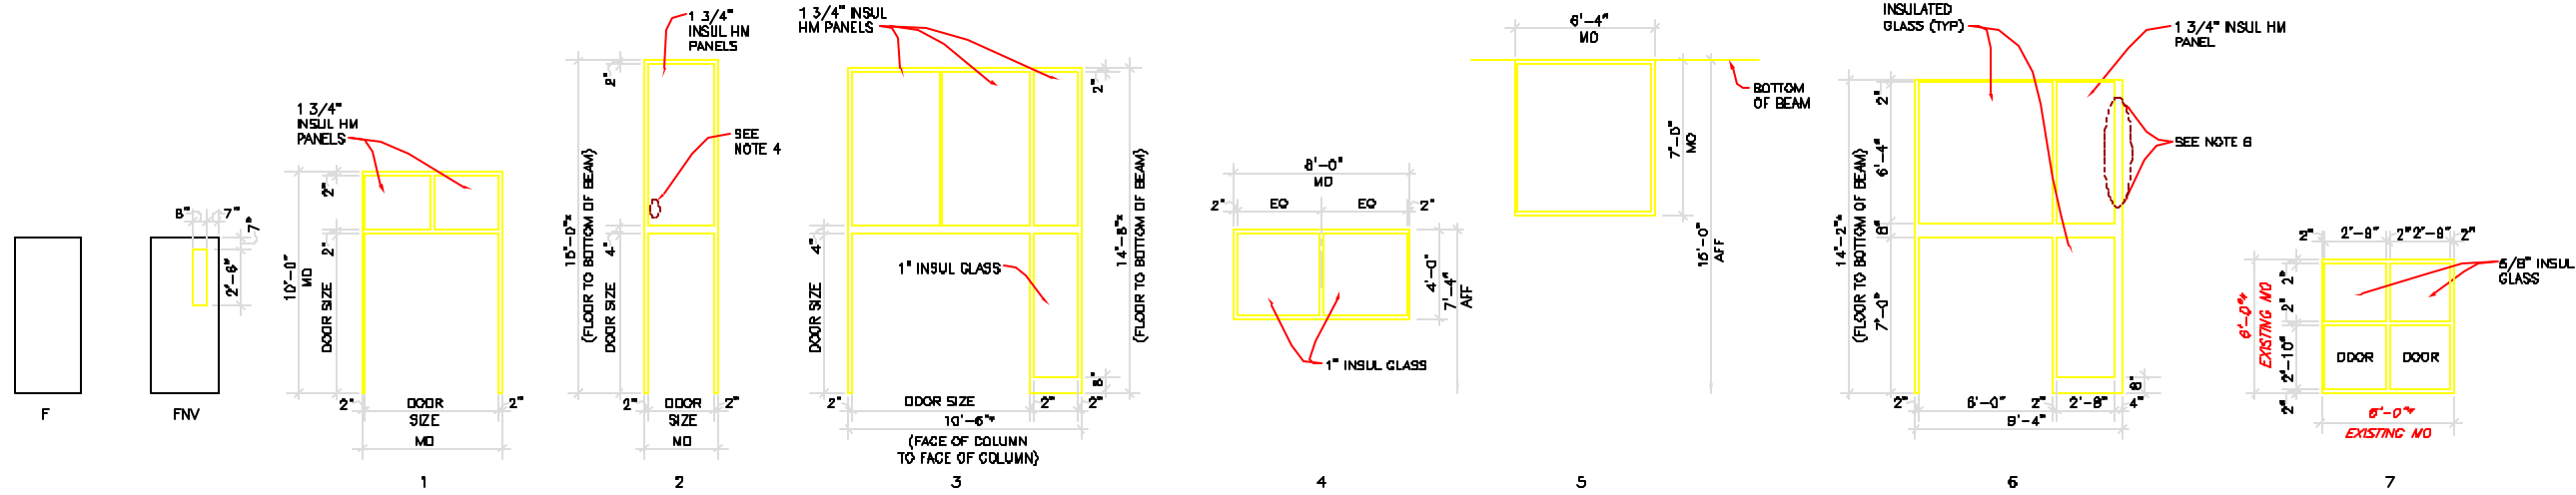

DOOR TYPES

FRAME TYPES

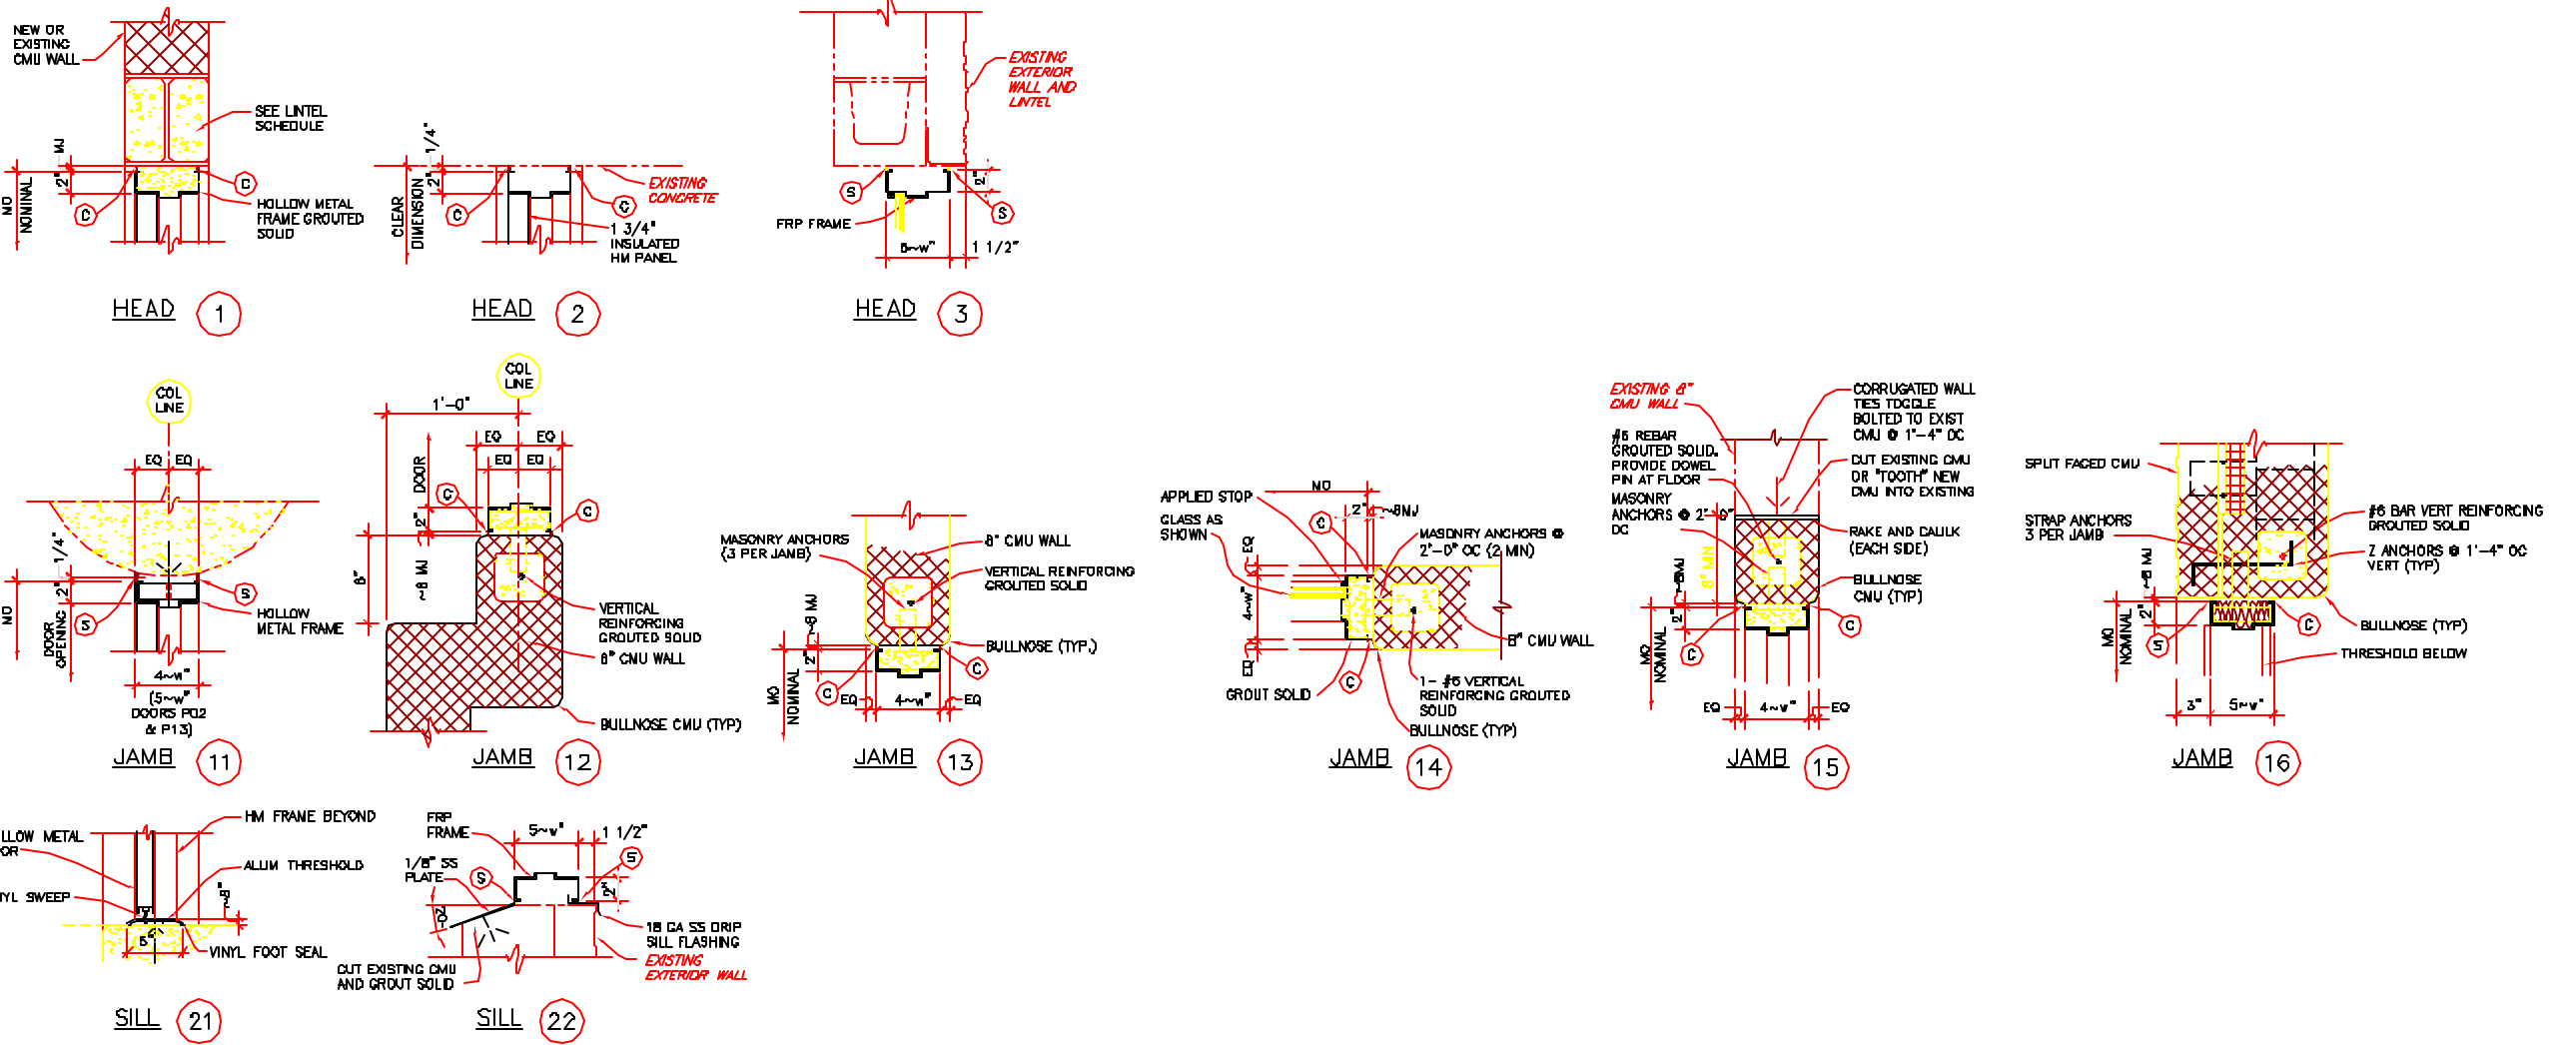

PROGRESS PRINTS	4-4-01
DESIGNED BY	3-4-01
CHECKED BY	3-4-01
DATE	3-4-01
APPROVED BY	3-4-01
DATE	3-4-01
PROJECT NO.	70551A
BOOK NO.	-
SCALE	AS NOTED

DRAWN BY: BLD  
CHECKED BY: JEP  
DATE: 3-4-01  
APPROVED BY: JEP  
DATE: 3-4-01  
PROJECT NO.: 70551A  
BOOK NO.: -  
SCALE: AS NOTED

REVISIONS  
NO. DESCRIPTION DATE

Wright-Pierce  
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Topsham, Maine USA 04086  
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PORTLAND WATER DISTRICT  
PORTLAND, MAINE  
PRIMARY SEDIMENTATION BASINS  
UPGRADE WITH ODOR CONTROL FACILITIES  
DOORS

DWG A-2  
7 OF 79