
20A, 2-POLE, MOTOR RATED SWITCH. FLUSH MOUNTED IN WALL AT 48" AFF: CONTRACTOR SHALL COORDINATE EXACT SWITCH LOCATION WITH EQUIPMENT SUPPLIER AND ARCHITECT PRIOR TO ROUGH-IN.


CONTRACTOR SHALL PROVIDE EMPTY 3/4" CONDUIT FOR CONTROLS AND POWER WIRING BETWEEN INDOOR UNIT (SAC) AND CORRESPONDING OUTDOOR UNIT (SCU). POWER AND CONTROLS FROM OUTDOOR UNIT TO INDOOR UNIT SHALL BE PROVIDED BY MECHANICAL CONTRACTOR. COORDINATE EQUIPMENT LOCATION WITH MECHANICAL CONTRACTOR PRIOR TO ROUGH-IN.


REFER TO PANEL SCHEDULES ON SHEET E3.1 FOR FURTHER INFORMATION.

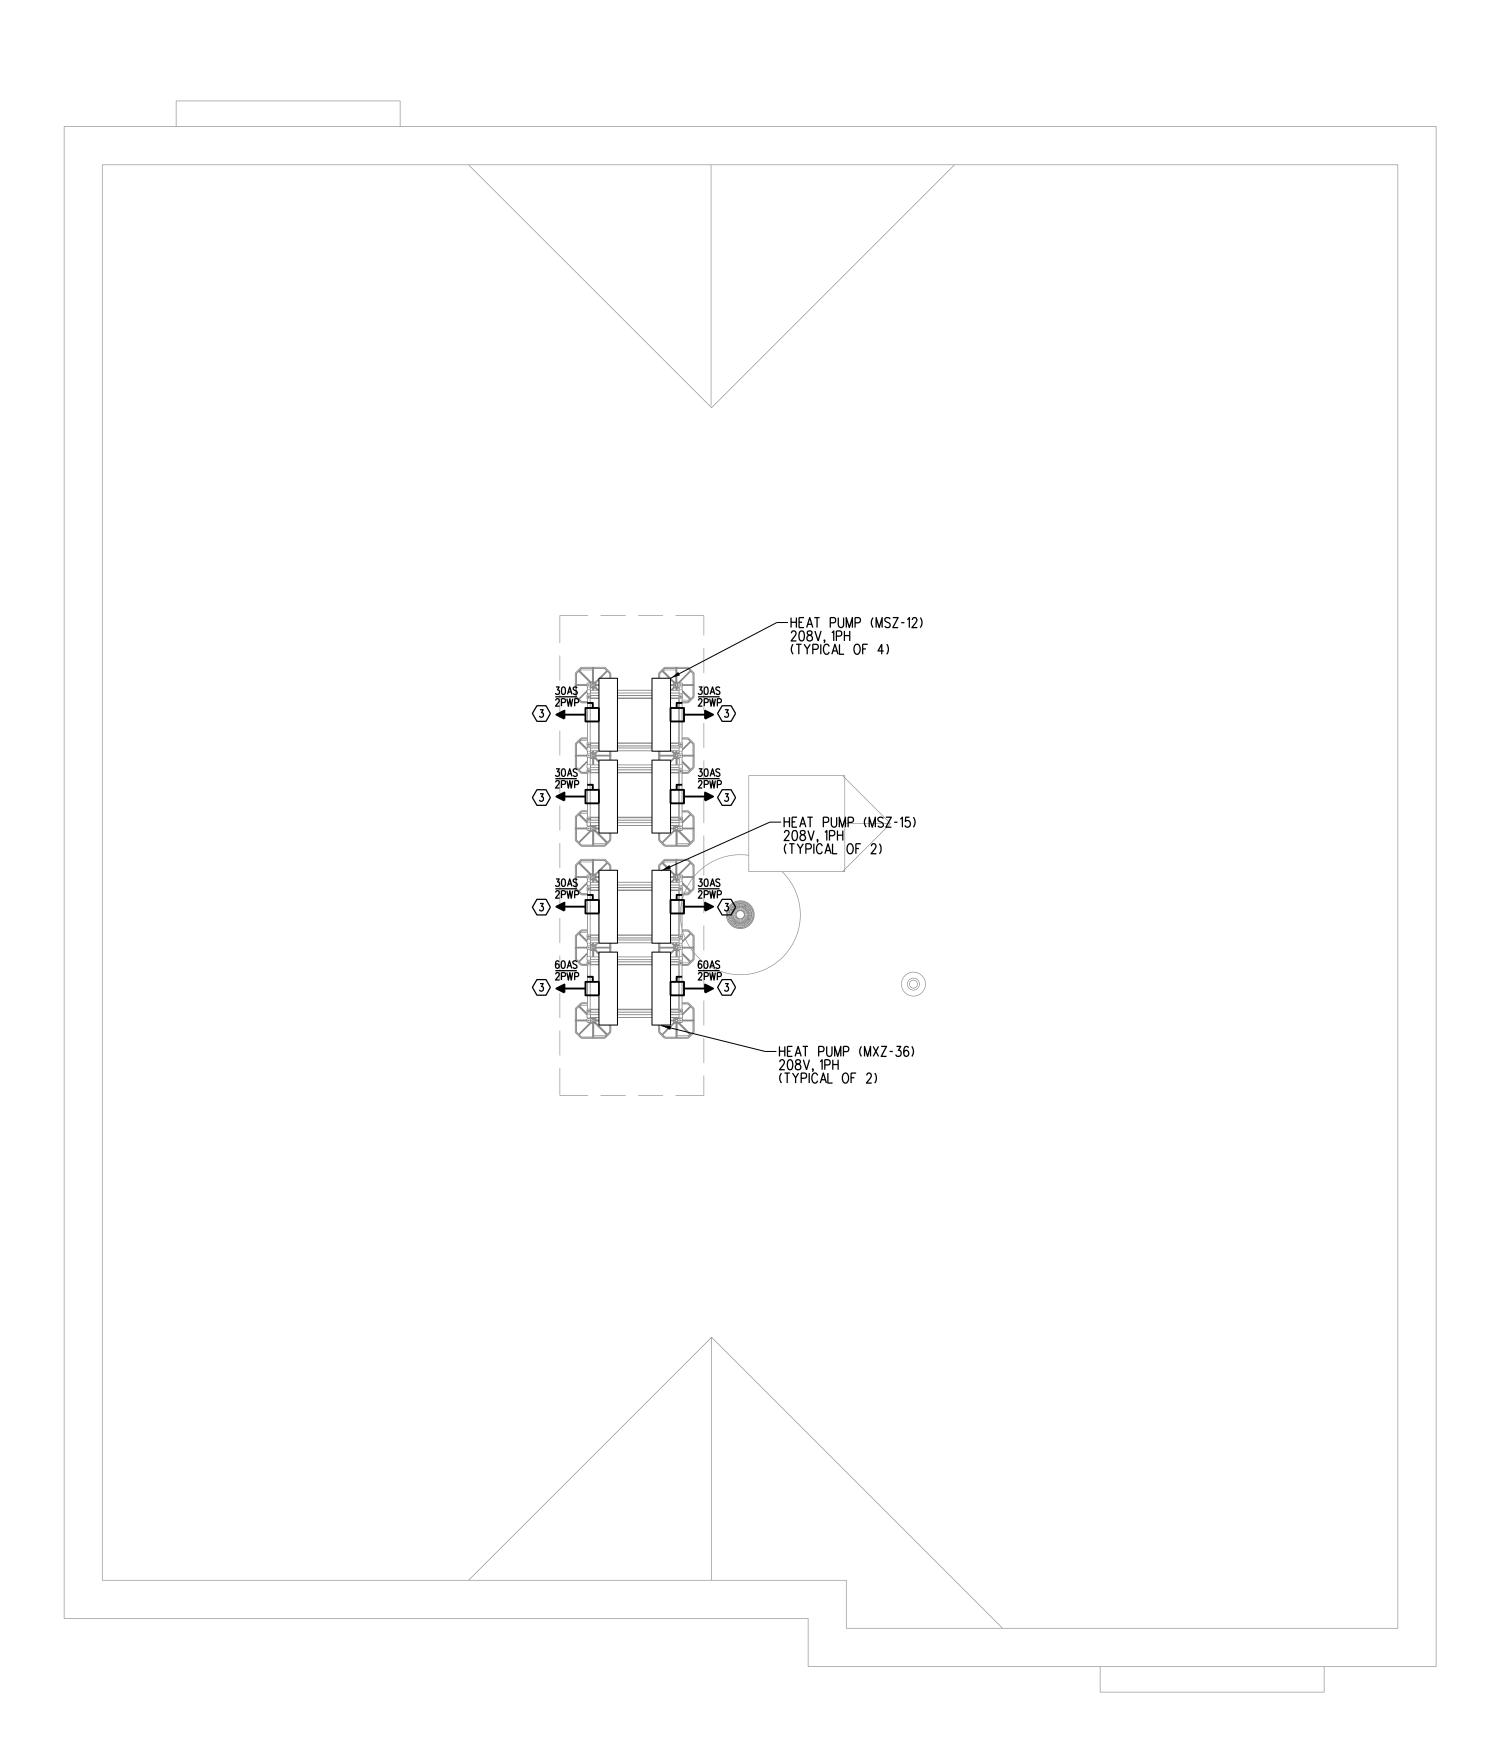

ROOF POWER PLAN

SCALE: 1/4" = 1'-0"

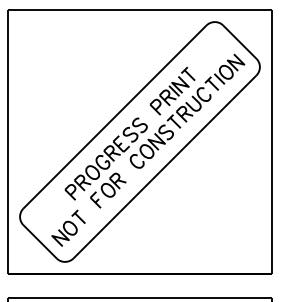

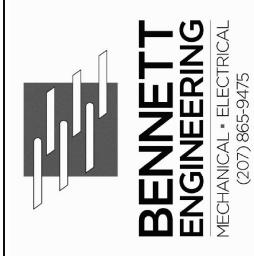

IDEAL ELECTRIC 86 China Rd. Winslow, ME 04901

55 MUNJOY ST. APARTMENTS
65 Munjoy St., Portland, ME 04101

PLAN

ELECTRICAL

ROOF

E2.3

| Date Drawn: | 09/16/2016 |
|-----------------------------|------------|
| Drawn By: | CAT |
| Checked By: | SAJ |
| Revision: 1. 2. 3. 4. 5. 6. | |
| BEI Project No: | 3936 |
| Scale: AS | NOTED |

Sht Num: