AARON C. JONES No. 10968 April 10th, 2011	- author
JONES No. 10968	ATE OF MANAGE
No. 10968	
SONAL April Wth, 2017	
April Joth, 2017	CENSED
	April Wth, 2017
	·

© 2017 RYAN SENATORE ARCHITECTURE

ARCHITECTURE 565 CONGRESS ST. SUITE 304 PORTLAND, MAINE 04101

207-650-6414

senatorearchitecture.com CONSULTANTS: STRUCTURAL: Structural Integrity 77 Oak Street Portland, ME 04101

207-774-4614

REVISIONS:


10 April, 2017 PROJECT No. 1703 DRAWN BY: WMc/BDH CHECKED BY: AS NOTED

SCALE: SHEET TITLE:

DECK FRAMING PLAN

FRAMING PLAN SYMBOLS KEY WOOD COLUMN STEEL COLUMN NUMBER OF WOOD STUDS IN POST BELOW COLUMN ABOVE THIS LEVEL COLUMN CONTINUOUS THROUGH THIS LEVEL EXISTING COLUMN BELOW ✓ JOIST/TRUSS BEARING CONTINUOUS JOIST WITH INTERMEDIATE BEARING FLUSH FRAMED JOIST BEARING WITH HANGER WOOD STUD BEARING WALL BELOW SHEAR WALL NUMBER OF TRIM STUDS UNDER HEADER NUMBER OF KING STUDS ADJACENT TO HEADER

LEGEND DROPPED BEAM — — — FLUSH BEAM

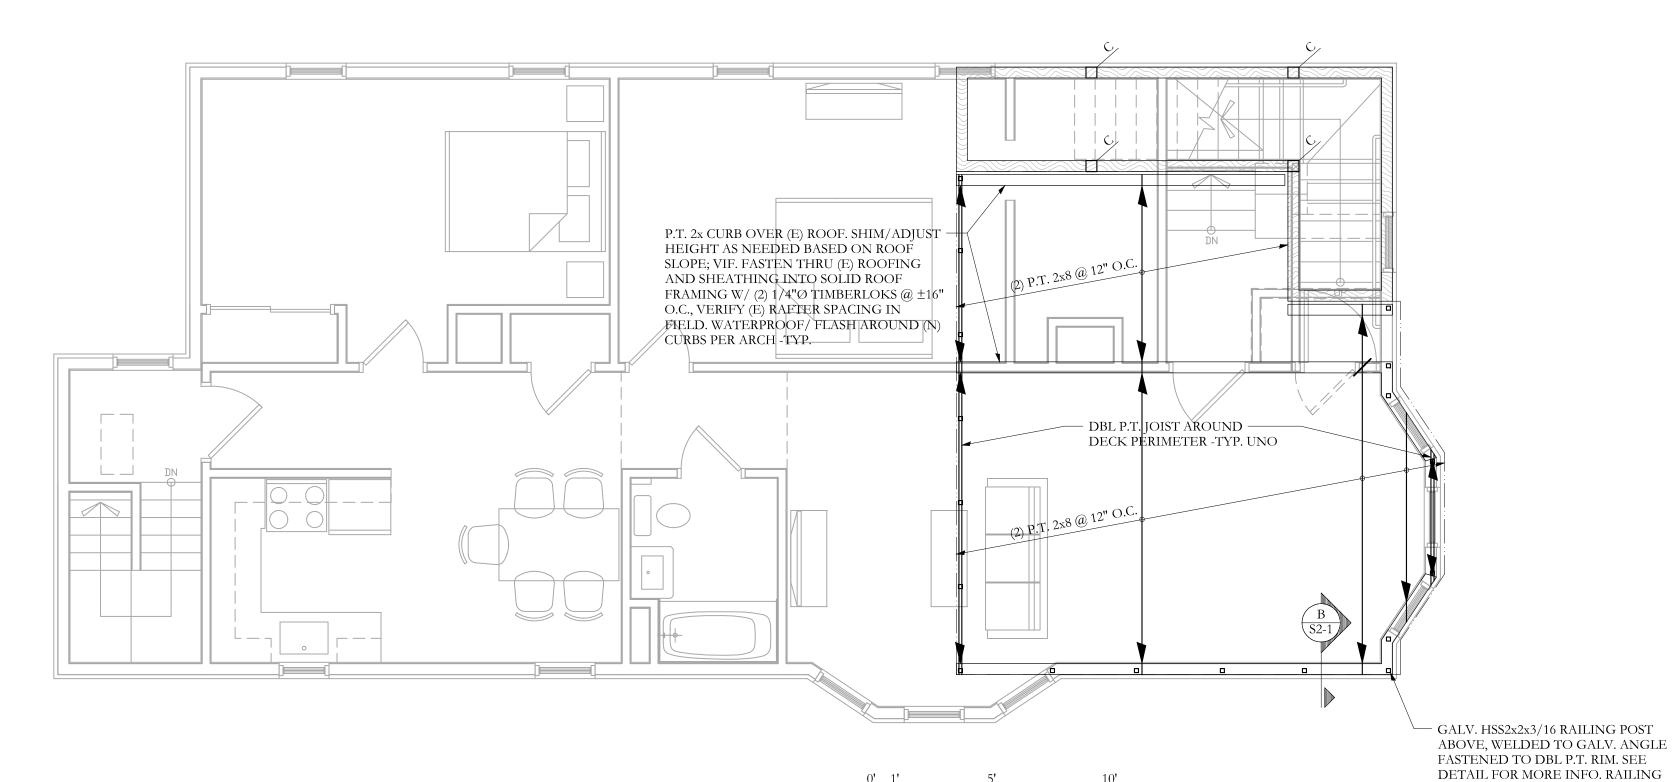

DECK FRAMING PLAN SCALE 1/4"=1'-0"

1. SEE GENERAL NOTES FOR ADDITIONAL INFORMATION.

2. TEMPORARY SHORING OF ALL WORK BY CONTRACTOR -TYP 3. (E) INDICATES EXISTING, (N) INDICATES NEW.

- 4. ALL WOOD COLUMNS IN 2x6 WALLS SHALL BE 3-2x6 AND IN 2x4 WALLS SHALL BE 3-2x4
- UNLESS NOTED OTHERWISE ON PLANS. 5. ALL HEADERS IN 2x6 BEARING WALLS ARE (3) 2x6, UNO.

- 6. ALL HEADERS IN 2x4 BEARING WALLS ARE (2) 2x8, UNO.
- 7. ALL NEW FLOOR SHEATHING TO BE 3/4", SEE GENERAL NOTES FOR MORE INFO -TYP. 8. ALL NEW ROOF SHEATHING TO 5/8", SEE GENERAL NOTES FOR MORE INFO -TYP.

FOR PERMIT

POST LAYOUT PER ARCH -TYP.

