


EXISTING FRAMING PLAN

SCALE: 1/4"=1'-0"

FRAMING DEMOLITION NOTES

- I. Remove lumber framing members as shown. Provide temporary support for any load bearing conditions
- 2. Masonry flues to remain
- 3. Provide temporary support for existing vent stack.

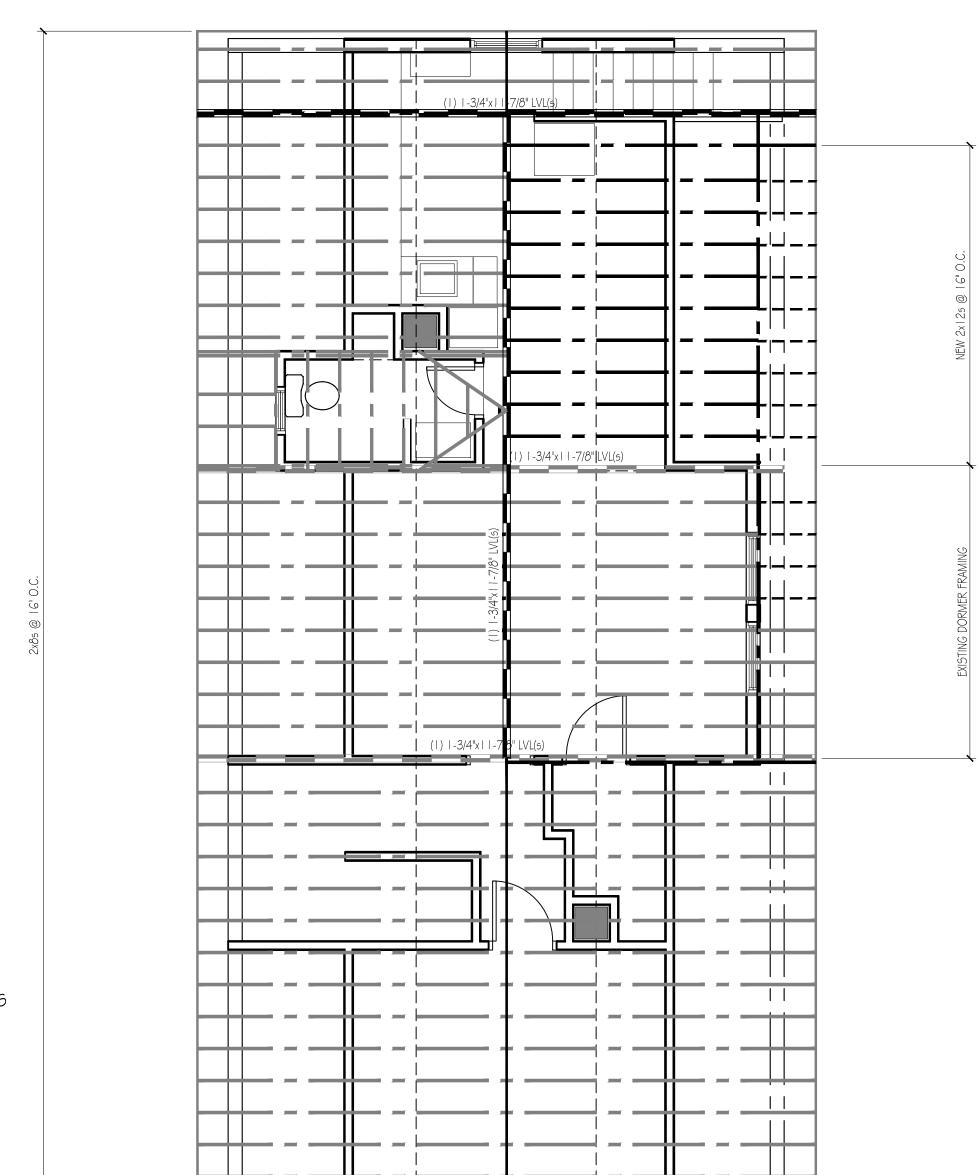

LEGE

EXTENT OF SIZE, TYPE, SPACING OF FRAMING

COLUMN CENTER-LINE OR CENTER STICK

BRACING

WALL BELOW FRAMING

WALL ABOVE FRAMING

ENGINEERED JOIST OR TRUSS

SOLID SAWN WOOD JOIST OR RAFTER

SOLID SAWN OR ENGINEERED RIM JOIST

DLANING WALL


SOLID SAWN WOOD JOIST DOUBLED UNDER WALLS RUNNING PARALLEL TO JOISTS


ENGINEERED OR SOLID SAWN BEAM OR HEADER

STEEL BEAN

REVISED FRAMING PLAN

SCALE: 1/4"=1'-0"

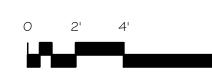

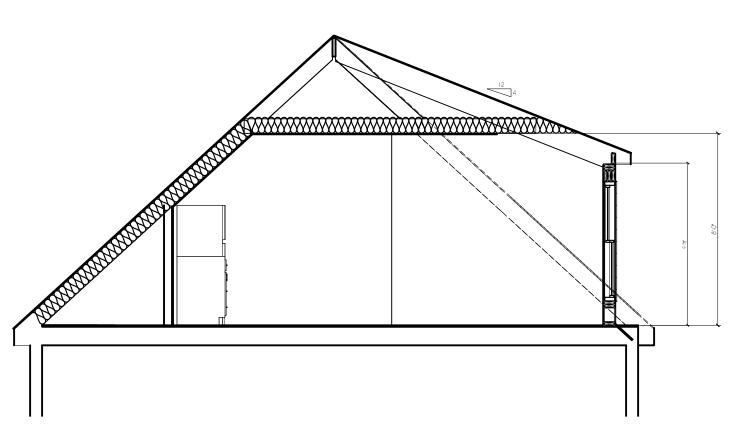

BEVIBODIF FRADORISHERAN

SCALE: 1/4"=1'-0"



WOOD FRAMING NOTES:

1. STRUCTURAL LUMBER: SPIB Grading Rules Agency / No. 2 or Better Southern Pine

Fb = 1500 PSI Fv = 100 PSI

Fc = 1650 PSI E = 1600000 PSI

2. DESIGN CODE: THIS BUILDING IS DESIGNED TO COMPLY WITH THE 2009 EDITION OF THE INTERNATIONAL BUILDING CODE, IBC 2009.

3. FASTENERS: COMPLY WITH RECOMMENDED FASTENING SCHEDULE

OF THE INTERNATIONAL BUILDING CODE IBC 2009 UNLESS SHOWN OTHERWISE ON THE DRAWINGS.

4. SHEATHING: APA RATED 'EXPOSURE 1' PLYWOOD OR COMPOSITE PANEL:

LOCATIONTHICKNESSSPAN RATINGEDGE NAILINGFIELD NAILINGROOF SHEATHING: $\frac{5}{8}$ —INCH40/208d AT 6" OC8d AT 12" OCWALL SHEATHING: $\frac{1}{2}$ —INCH16/08d AT 6" OC8d AT 12" OCFLOOR SHEATHING: $\frac{3}{4}$ —INCH48/248d AT 6" OC8d AT 12" OC

5. SPIKE TOGETHER ALL FRAMING MEMBERS WHICH ARE BUILT-UP USING MULTIPLE 2x

6. PROVIDE PRESSURE TREATED LUMBER FOR ALL LUMBER IN CONTACT WITH MASONRY OR CONCRETE OR EXPOSED TO WEATHER.

7. ROOF SHEATHING: 5/8" APA RATED SHEATHING, EXTERIOR OR STRUCTURAL I OR II RATED SHEATHING, SPAN RATING 40/20. INSTALL SHEETS WITH FACE GRAIN DIRECTION PERPENDICULAR TO SUPPORTING MEMBERS.

8. WALL SHEATHING: 1/2" APA RATED SHEATHING, EXTERIOR OR STRUCTURAL I OR II RATED SHEATHING, SPAN RATING 32/16. INSTALL SHEETS WITH FACE GRAIN DIRECTION PERPENDICULAR TO SUPPORTING MEMBERS.

I. Contractor/owner responsible for securing all necessary permits.

2. Contractor/owner will Comply with all applicable codes and ordinances.

3. Contractor/owner to verify all site grades and dimensions.

ERIC N. ** GRONDAHL G

Renovations to Existing Apartment Building 23 Vesper Street

DATE: 08-04-17
SCALE: As Noted
DRAWN: JJO

FRAMING PLANS

SHEET:

TITLE:

ET: A1-03