


ROOF PLAN

1/8" = 1'-0"

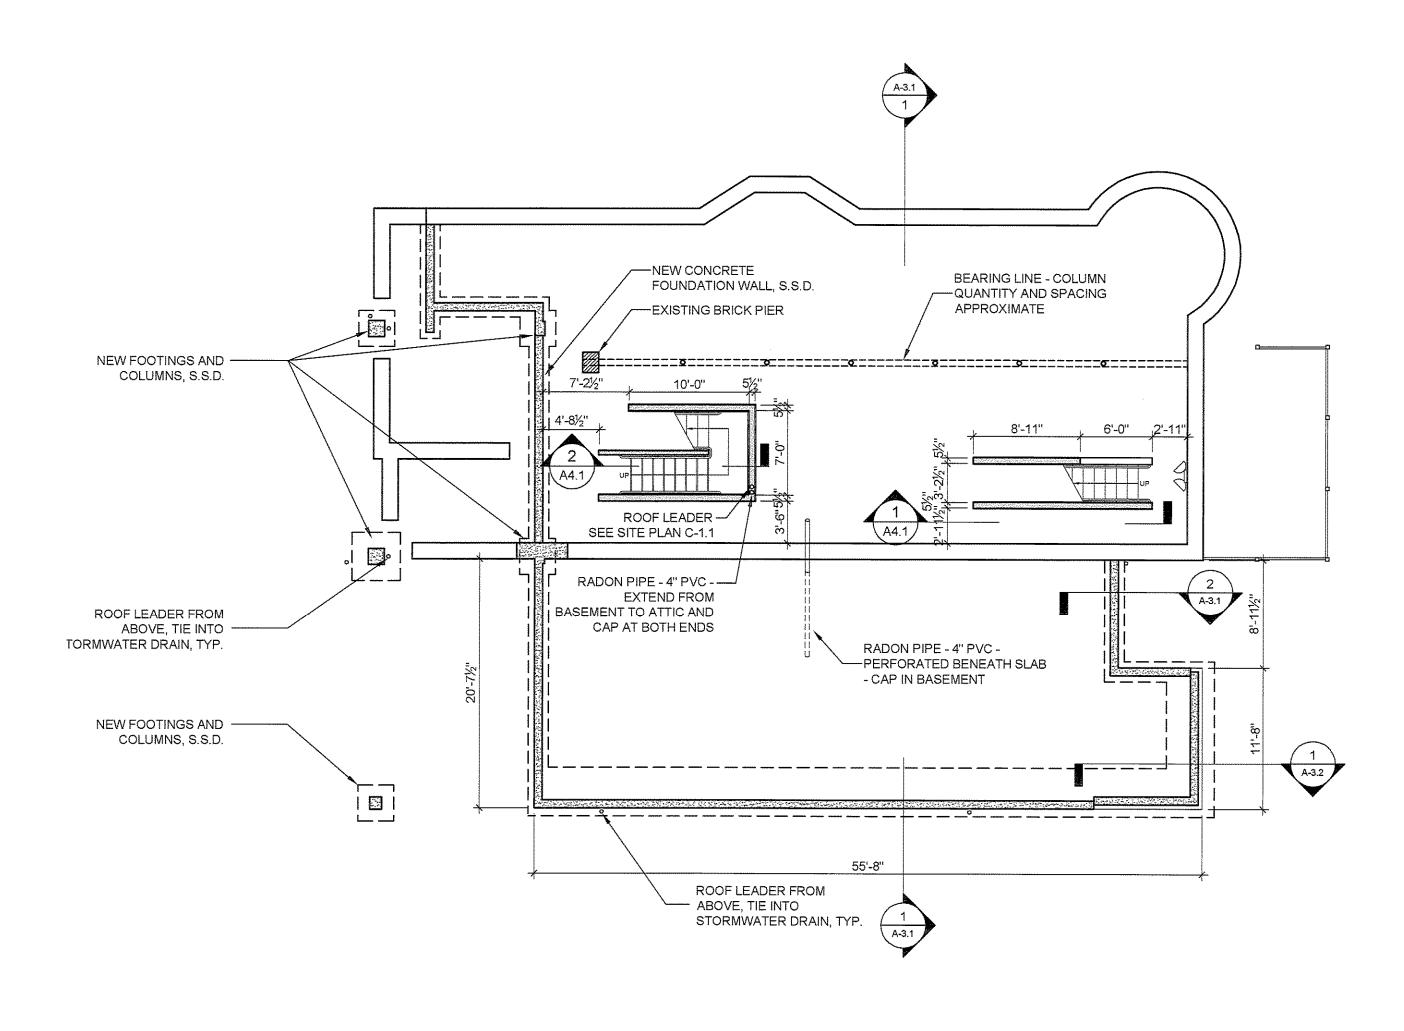

1 BASEMENT PLAN
A1.1 1/8" = 1'-0"

LEGEND

EXISTING CONSTRUCTION TO REMAIN


___ DEMOLITION


NEW CONSTRUCTION

1 HOUR RATED NEW CONSTRUCTION

1 HOUR RATED EXISTING CONSTRUCTION

NOTE: SEE A-3.1 FOR CONSTRUCTION ASSEMBLIES

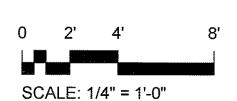

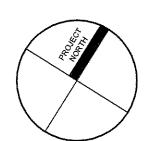

GENERAL NOTES (SEE G-1.1 FOR MORE GENERAL NOTES)

1. DRAWING NOTES: DRAWING NOTES, UNLESS THEY INDICATE OR ARE OBVIOUS, REFER TO NEW CONSTRUCTION.

2. LAYOUT: UNLESS INDICATED OTHERWISE, FLOOR PLAN DIMENSIONS ARE TO FINISH FACE OF EXISTING CONSTRUCTION AND ARE TO FACE OF FRAMING OF NEW CONSTRUCTION. DOORS AND WINDOWS ARE DIMENSIONED TO CENTERLINES OR ROUGH OPENINGS. STAIR TREAD AND RISER LAYOUT DIMENSIONS ARE TO TREAD NOSINGS. © 2007 TFH ARCHITECTS

THE ESTATES OF LONGFELLOW INN
30 EASTERN PROMENADE, PORTLAND, ME
CASCO BAY VENTURES

TFH ARCHITECTS
100 COMMERCIAL STREET
PORTLAND MAINE 04101
TELEPHONE 207 775 6141
ARCHITECTURE PLANNING

CONSULTANTS:

<u>CIVIL:</u>
Land Consulting Engineers, PA
967 Broadway
South Portland, ME 04106
Tel. 207-767-7300
Fax. 1-866-207-2033

<u>STRUCTURAL:</u>

Fax. 1-866-207-2033

STRUCTURAL:
Shelley Engineering, Inc.
90 Bridge St. Suite 300
Westbrook, ME O4092
Ph.207.854.5465 ext. 19
Fax.207.854.8706

REVISIONS:

DATE: 02.14.2008

PROJECT No. 0610

DRAWN BY: SA

CHECKED BY: TST

SCALE: AS NOTED

SHEET TITLE:
BASEMENT AND
ROOF PLAN

A1.1