


POWER WORK NOTES


- ① 20A, 2-POLE, MOTOR RATED SWITCH, FLUSH MOUNTED IN WALL AT 48" AFF; CONTRACTOR SHALL COORDINATE EXACT SWITCH LOCATION WITH EQUIPMENT SUPPLIER AND ARCHITECT PRIOR TO ROUGH-IN.
- ② CONTRACTOR SHALL PROVIDE EMPTY 3/4" CONDUIT FOR CONTROLS AND POWER WIRING BETWEEN INDOOR UNIT (SAC) AND CORRESPONDING OUTDOOR UNIT (SCU). POWER AND CONTROLS FROM OUTDOOR UNIT TO INDOOR UNIT SHALL BE PROVIDED BY MECHANICAL CONTRACTOR. COORDINATE EQUIPMENT LOCATION WITH MECHANICAL CONTRACTOR PRIOR TO ROUGH-IN.
- ③ REFER TO PANEL SCHEDULES ON SHEET E3.1 FOR FURTHER INFORMATION.

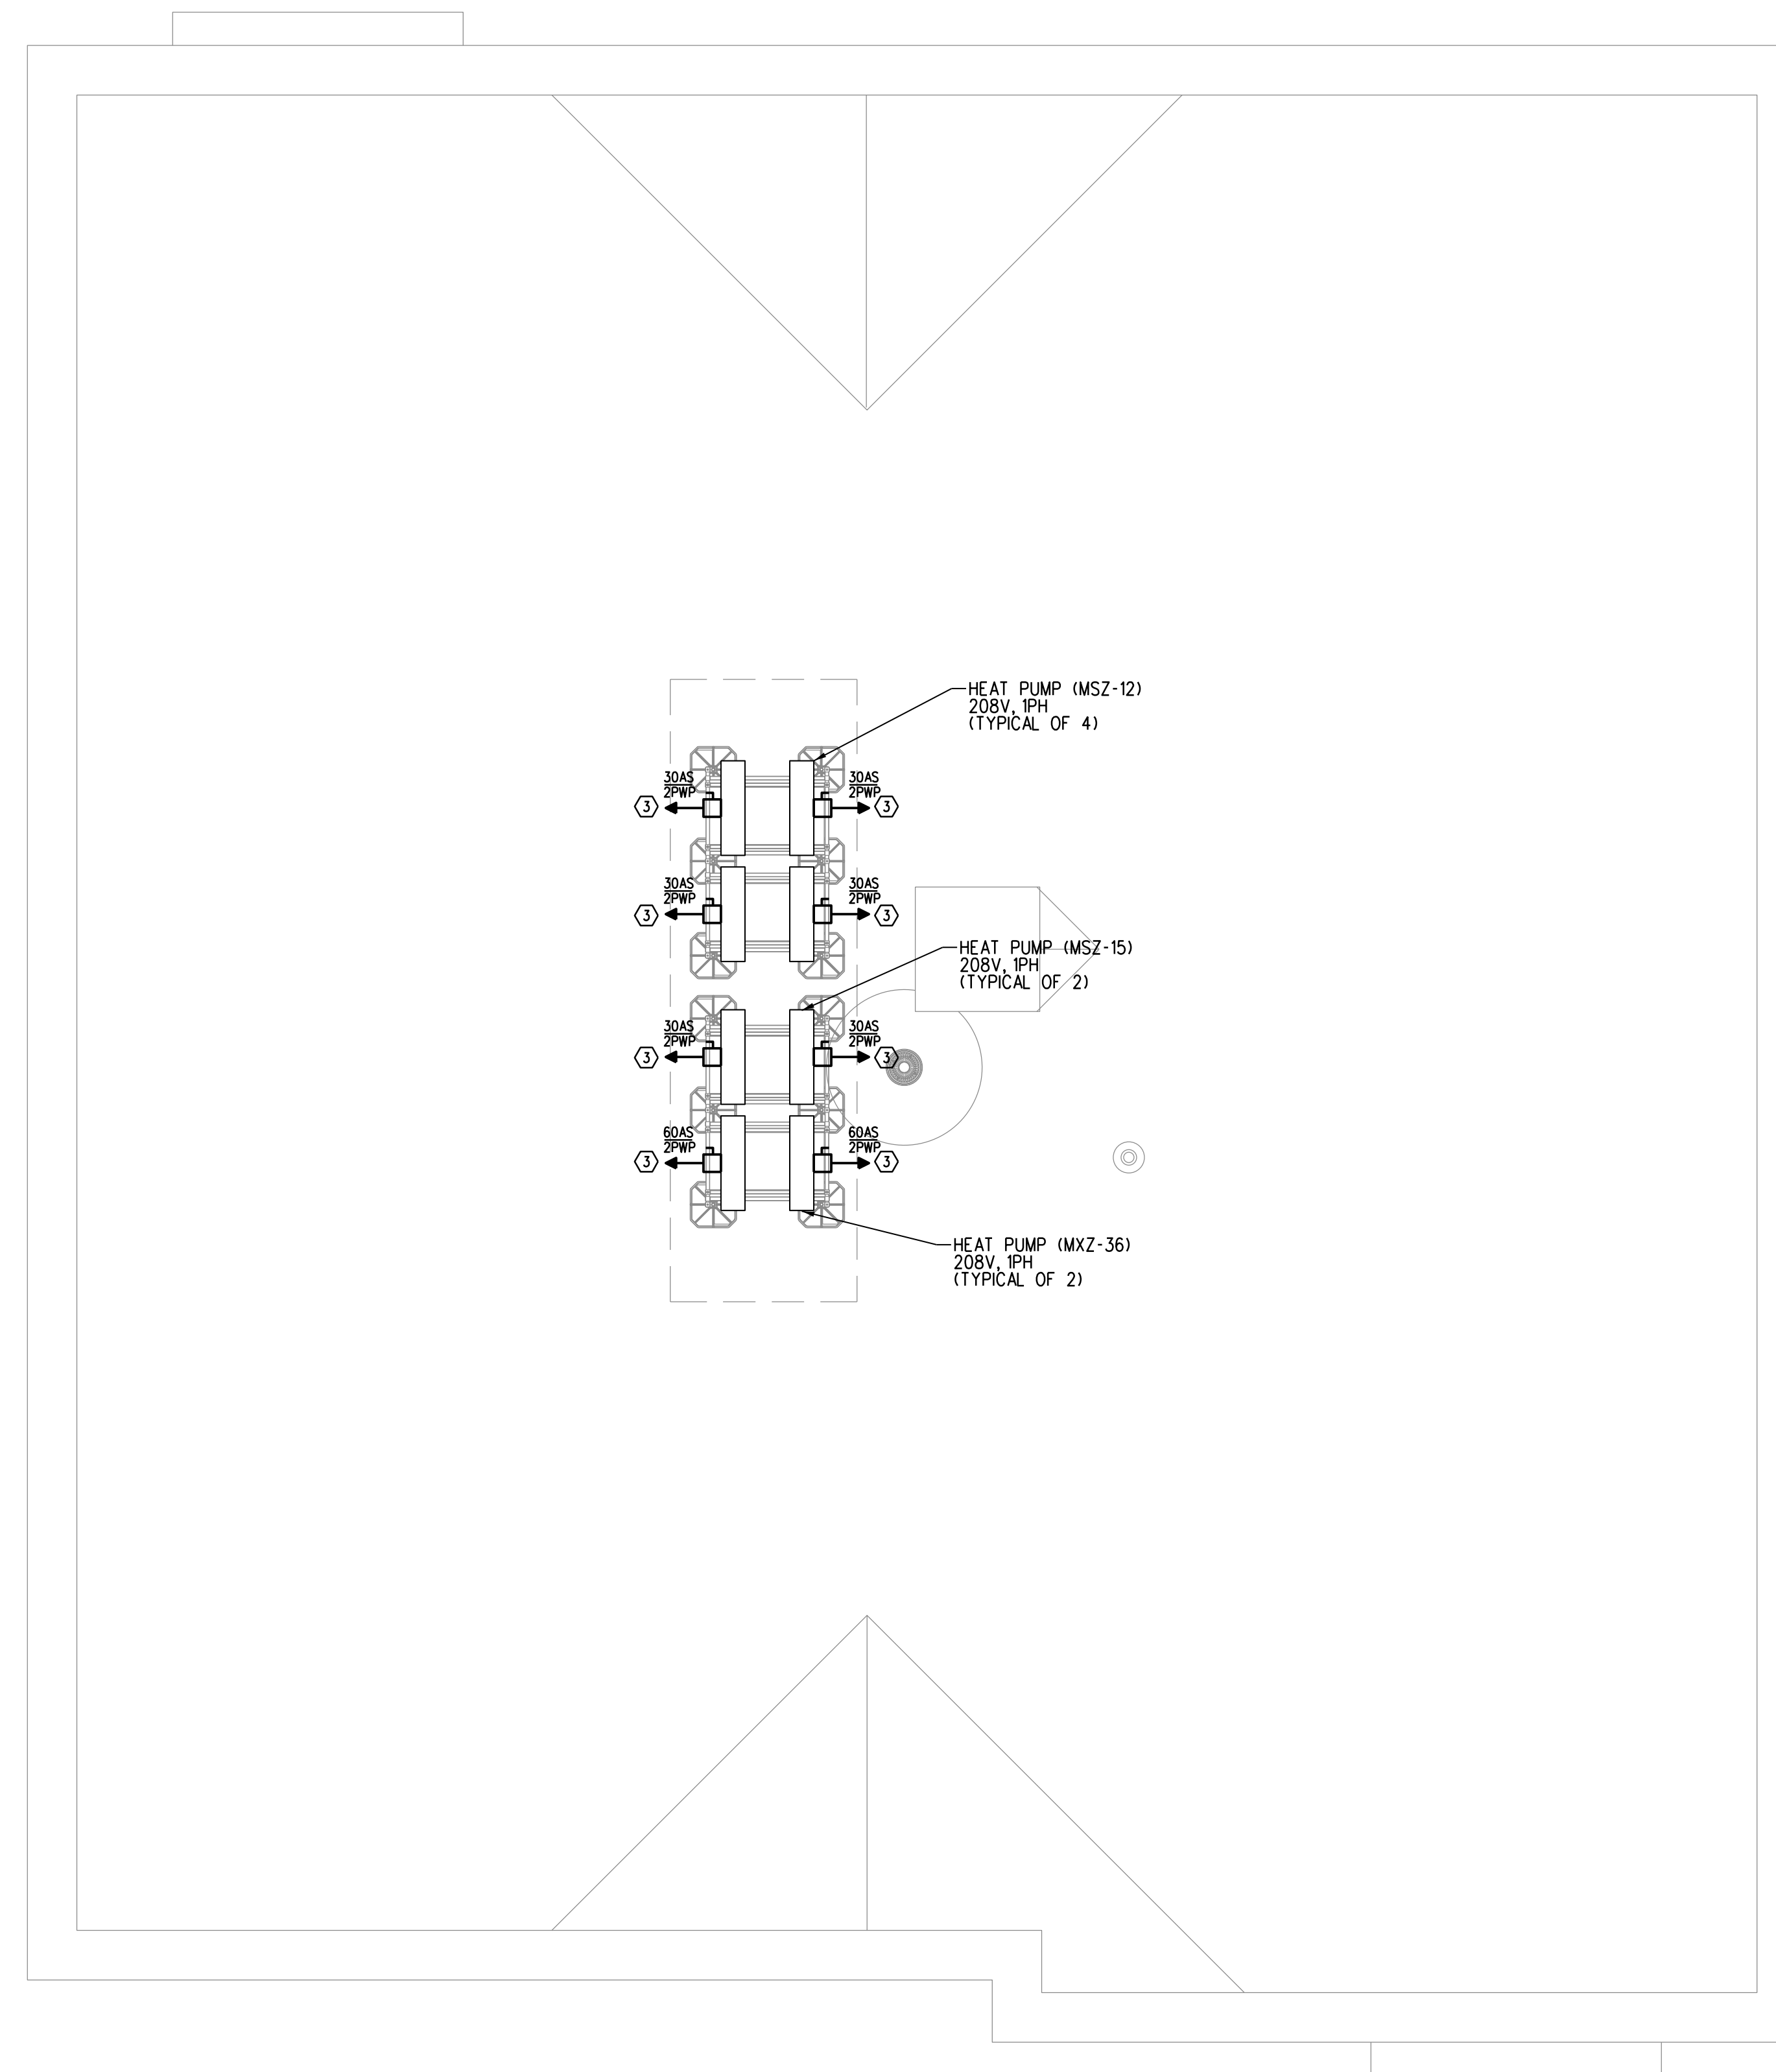

ROOF POWER PLAN

SCALE: 1/4" = 1'-0"

PROGRESS PRINT
 NOT FOR CONSTRUCTION

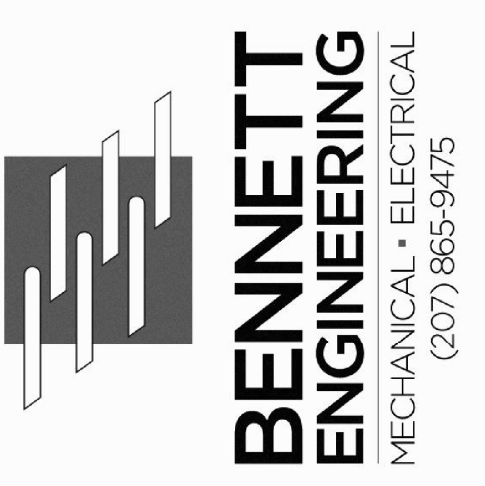

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 ROOF ELECTRICAL PLAN

Date Drawn:	09/16/2016
Drawn By:	CAT
Checked By:	SAJ
Revision:	1. 2. 3. 4. 5. 6. 7.
BEI Project No:	3936
Scale:	AS NOTED
Sht Num:	E2.3